## Attachment II AET Standard Drawings

# NORTH CAROLINA TURNPIKE AUTHORITY AET STANDARD DRAWINGS

### Typical All-Electronic Tolling (AET) Toll Zone Guidelines

- C-1 Typical Mainline AET Toll Zone Plan View
- C-2 Typical Ramp AET Toll Zone Plan View
- C-3 Typical 2-Lane, 2-Way AET Toll Zone Plan View
- C-4 AET Toll Zone Access
- C-5 Typical Mainline/Ramp Loop and Joint Locations Detail for Pavement
- C-6 Typical 2-Lane, 2-Way Loop and Joint Locations Detail for Pavement
- A-1 AET Toll Zone Vault Plan
- A-2 AET Toll Zone Vault Elevations
- A-3 Typical AET Toll Zone Gantry Elevations
- A-4 Typical AET Toll Zone Gantry Side Elevation
- A-5 Typical Express Lane Toll Zone Elevation
- E-1 Typical Mainline AET Toll Zone Conduit Detail
- E-2 Typical Ramp AET Toll Zone Conduit Detail
- E-3 Typical 2-Lane, 2-Way AET Toll Zone Conduit Detail
- E-4 AET Toll Zone Cabinets with Concrete Pads
- E-4a Express Lane Toll Zone Cabinets with Concrete Pads
- E-5 Toll Zone Vault Electrical Plan
- E-6 Toll Zone Vault Conduit Plan
- E-7 Typical Express Lane Toll Site Plan View
- R-1 Revisions


### **Abbreviations**

- AET All-Electronic Tolling
- **AVC Automatic Vehicle Classification**
- AVI Automatic Vehicle Identification
- C Conduit
- C/L Centerline
- DMS Dynamic Message Sign
- **EOP** Edge of Pavement
- EQ Equal Distance
- FON Fiber Optic Network


(includes conduit, fiber, boxes, etc.)

- ITS Intelligent Transportation Systems
- LPS Lightning Protection System
- **NEC National Electrical Code**
- NFPA National Fire Protection Association
- R/W Right-of-Way
- SOW Scope of Work
- SPD Surge Protection Device
- TYP Typical
- **UL Underwriters Laboratories**
- **UPS Uninterruptable Power Supply**



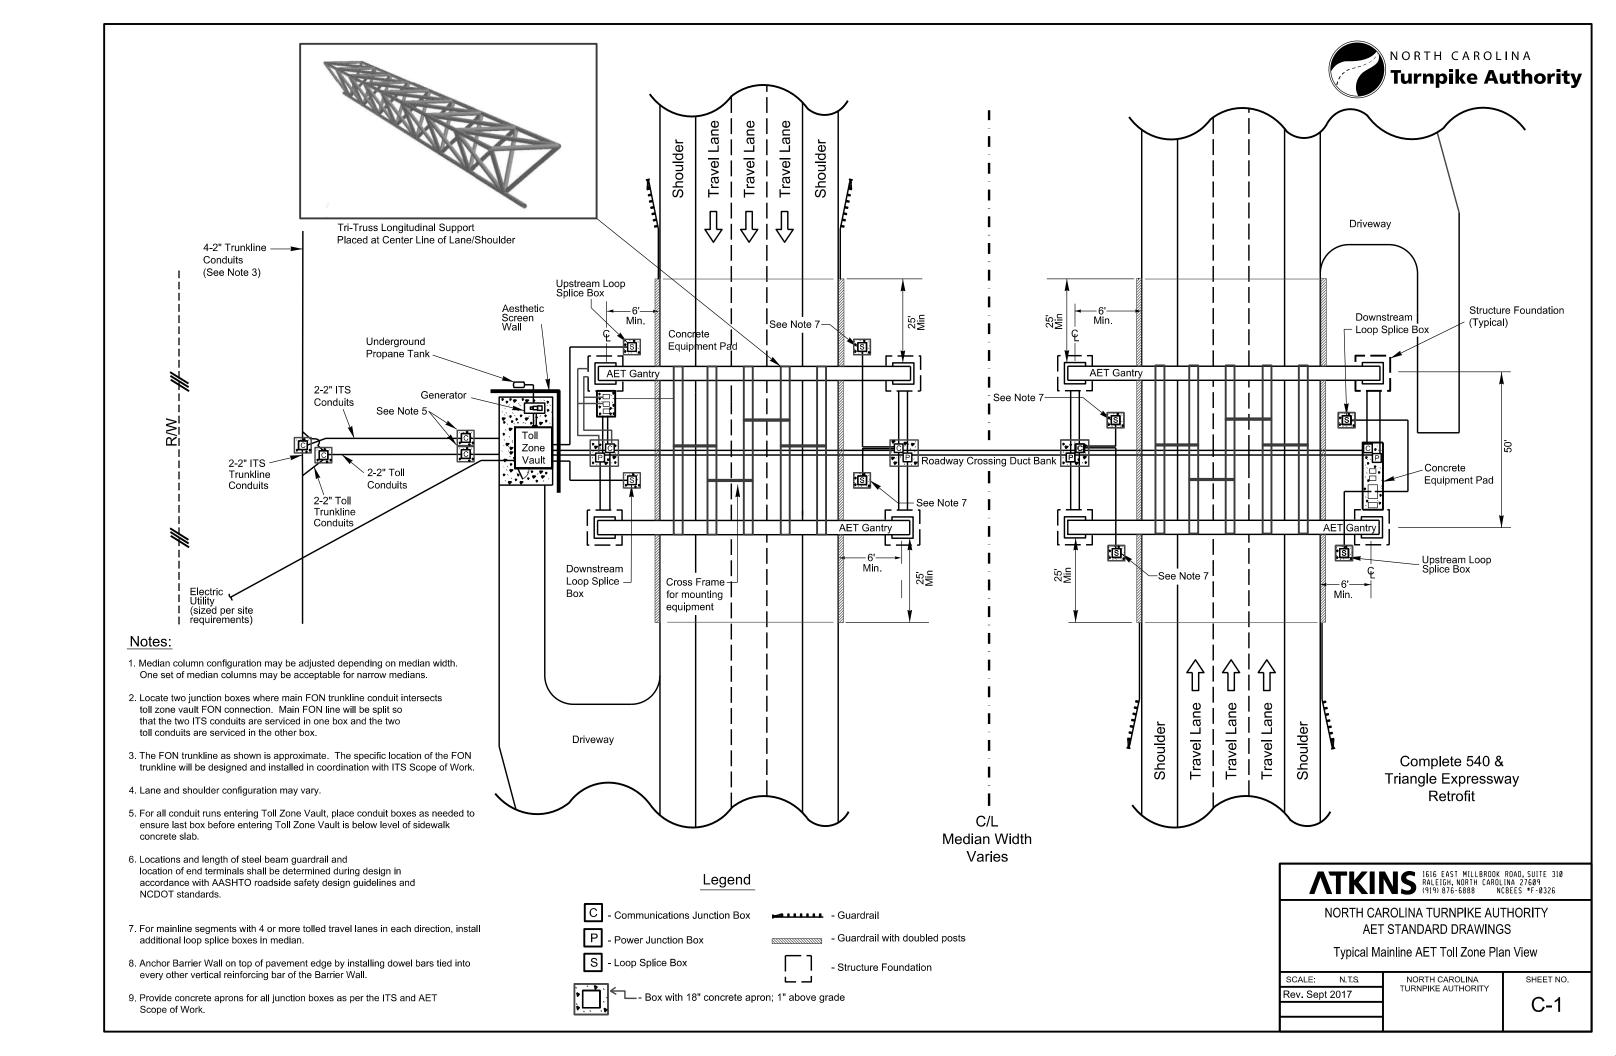



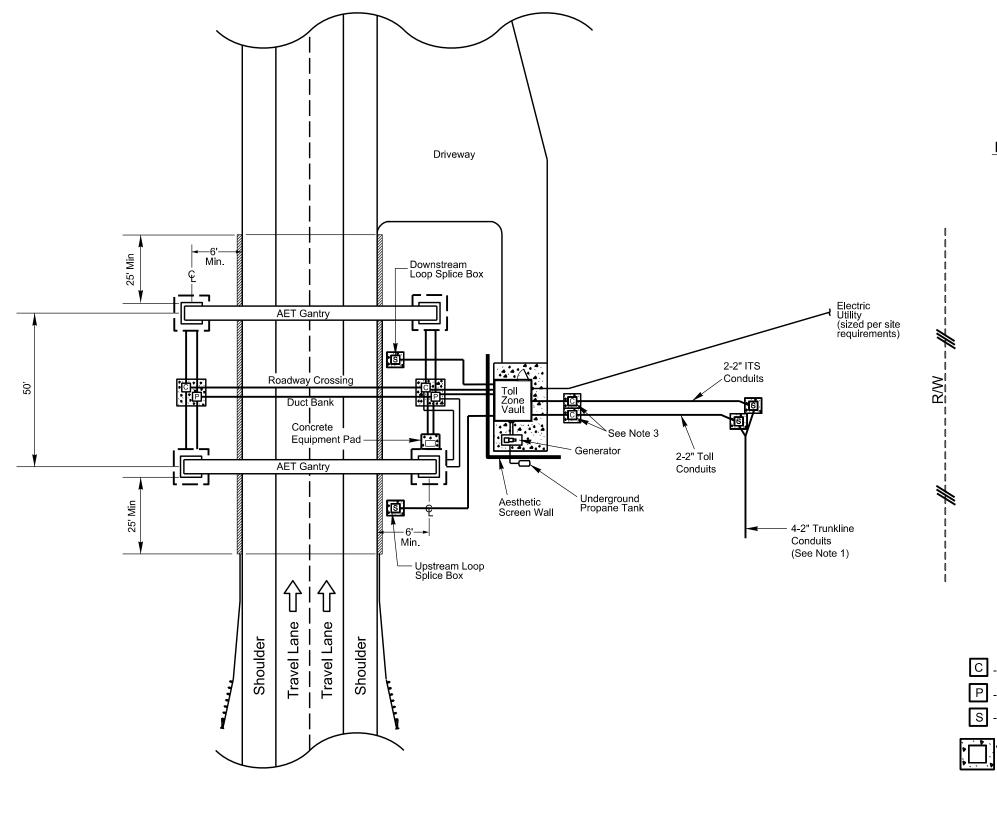

### Notes:

- The FON trunkline as shown is approximate. The specific location of the FON trunkline will be designed and installed in coordination with ITS Scope of Work.
- 2. Lane and shoulder configuration may vary.
- For all conduit runs entering Toll Zone Vault, place conduit boxes as needed to ensure last box before entering Toll Zone Vault is below level of sidewalk concrete slab.
- Locations and length of steel beam guardrail and location of end terminals shall be determined during design in accordance with AASHTO roadside safety design guidelines and NCDOT standards.
- Anchor Barrier Wall on top of pavement edge by installing dowel bars tied into every other vertical reinforcing bar of the Barrier Wall.
- Provide concrete aprons for all junction boxes as per the ITS and AET Scope of Work.

### Legend


C - Communications Junction Box	<b>————</b>	- Guardrail
P - Power Junction Box		- Guardrail with doubled posts
S - Loop Splice Box	Ŀij	- Structure Foundation
Box with 18" concrete apro	ىر كا n; 1" above gı	rade

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NORTH CAROLINA TURNPIKE AUTHORITY
AET STANDARD DRAWINGS

Typical Ramp AET Toll Zone Plan View

SCALE: N.T.S NORTH CAROLINA TURNPIKE AUTHORIT

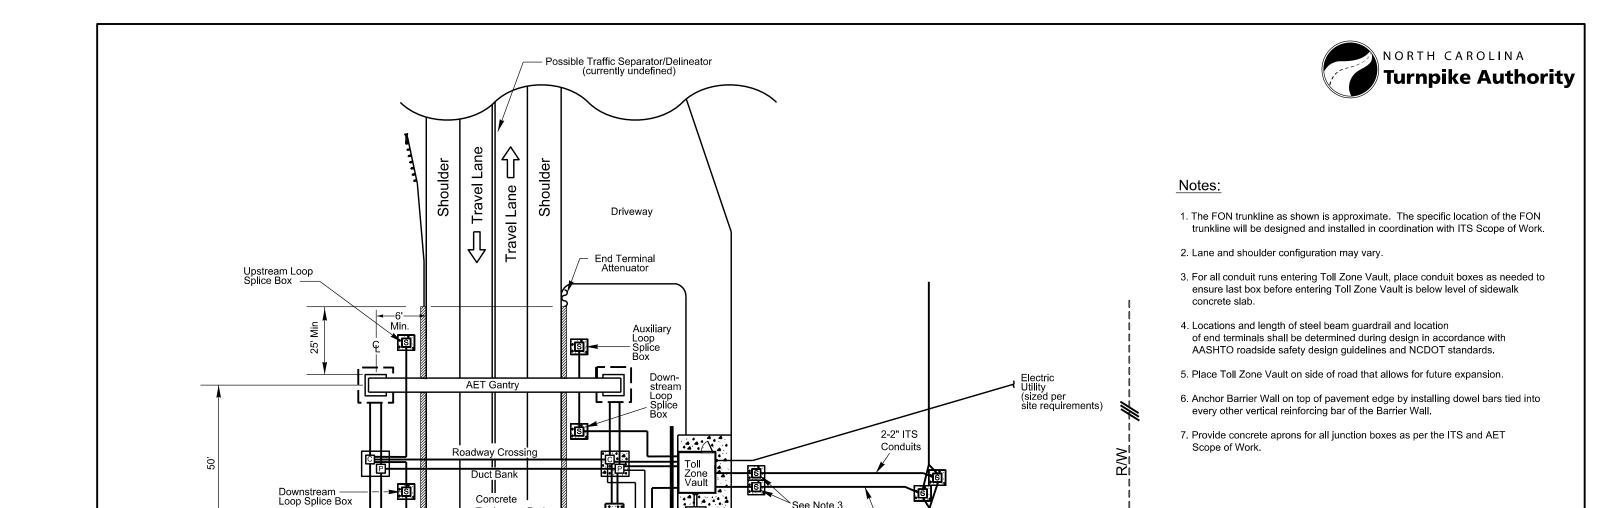

Generator

Aesthetic Screen Wall

-Upstream Loop Splice Box

Underground

2-2" Toll

Conduits

4-2" Trunkline Conduits (See Note 1)

Concrete Equipment Pad -

**AET Gantry** 

Travel Lane

Shoulder

Û

Travel Lane

Shoulder

Auxiliary Loop —— Splice Box

### Legend

<del></del> _				
C - Communications Junction Box	<b>————</b>	- Guardrail		
P - Power Junction Box		- Guardrail with doubled posts		
S - Loop Splice Box		- Structure Foundation		
Box with 18" concrete apron: 1" above grade				



NORTH CAROLINA TURNPIKE AUTHORITY AET STANDARD DRAWINGS

Typical 2-Lane, 2-Way AET Toll Zone Plan View


SCALE: NORTH CAROLINA N.T.S. Rev. Oct 2014

SHEET NO. C-3



### Signing Notes:

- 1. Signing applies to AET Toll Zones with and without buildings.
- 2. Signing applies to both mainline and ramp AET Toll Zones.
- 3. Sign spacing shall be in accordance with NCDOT and MUTCD standards.
- 4. Sign sizes shall be in accordance with MUTCD Table 2B-1.
- 5. U-channel support design shall be in accordance with NCDOT standards.

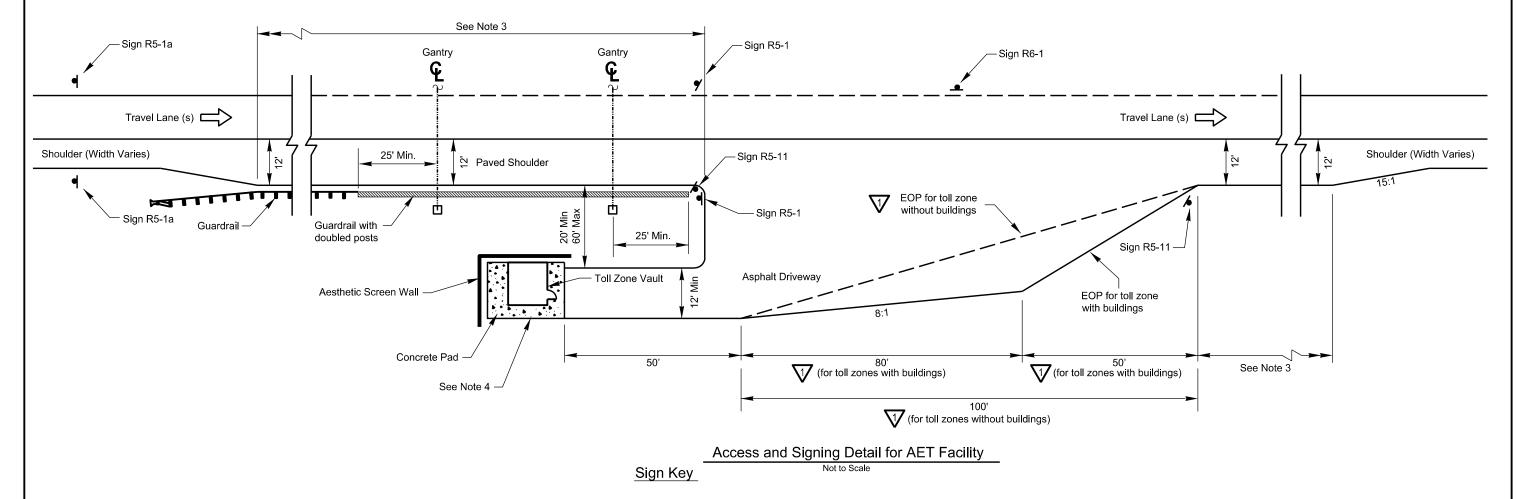


#### Notes

- 1. AET Toll Zone Vault and concrete pad may vary in size.
- Locations and length of steel beam guardrail and location of end terminals shall be determined during design in accordance with AASHTO roadside safety design guidelines and NCDOT standards.
- Acceleration and deceleration lengths shall be determined based on the design criteria included in the Roadway Scope of Work.
- 4. Center Toll Zone Vault between gantries.
- 5. Provide driveway whether vault is present or not.



Ground-mounted sign on U-channel support(s)

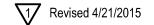


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AET STANDARD DRAWINGS

AET Toll Zone Access & Signing

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## INFORMATION NOT YET AVAILABLE

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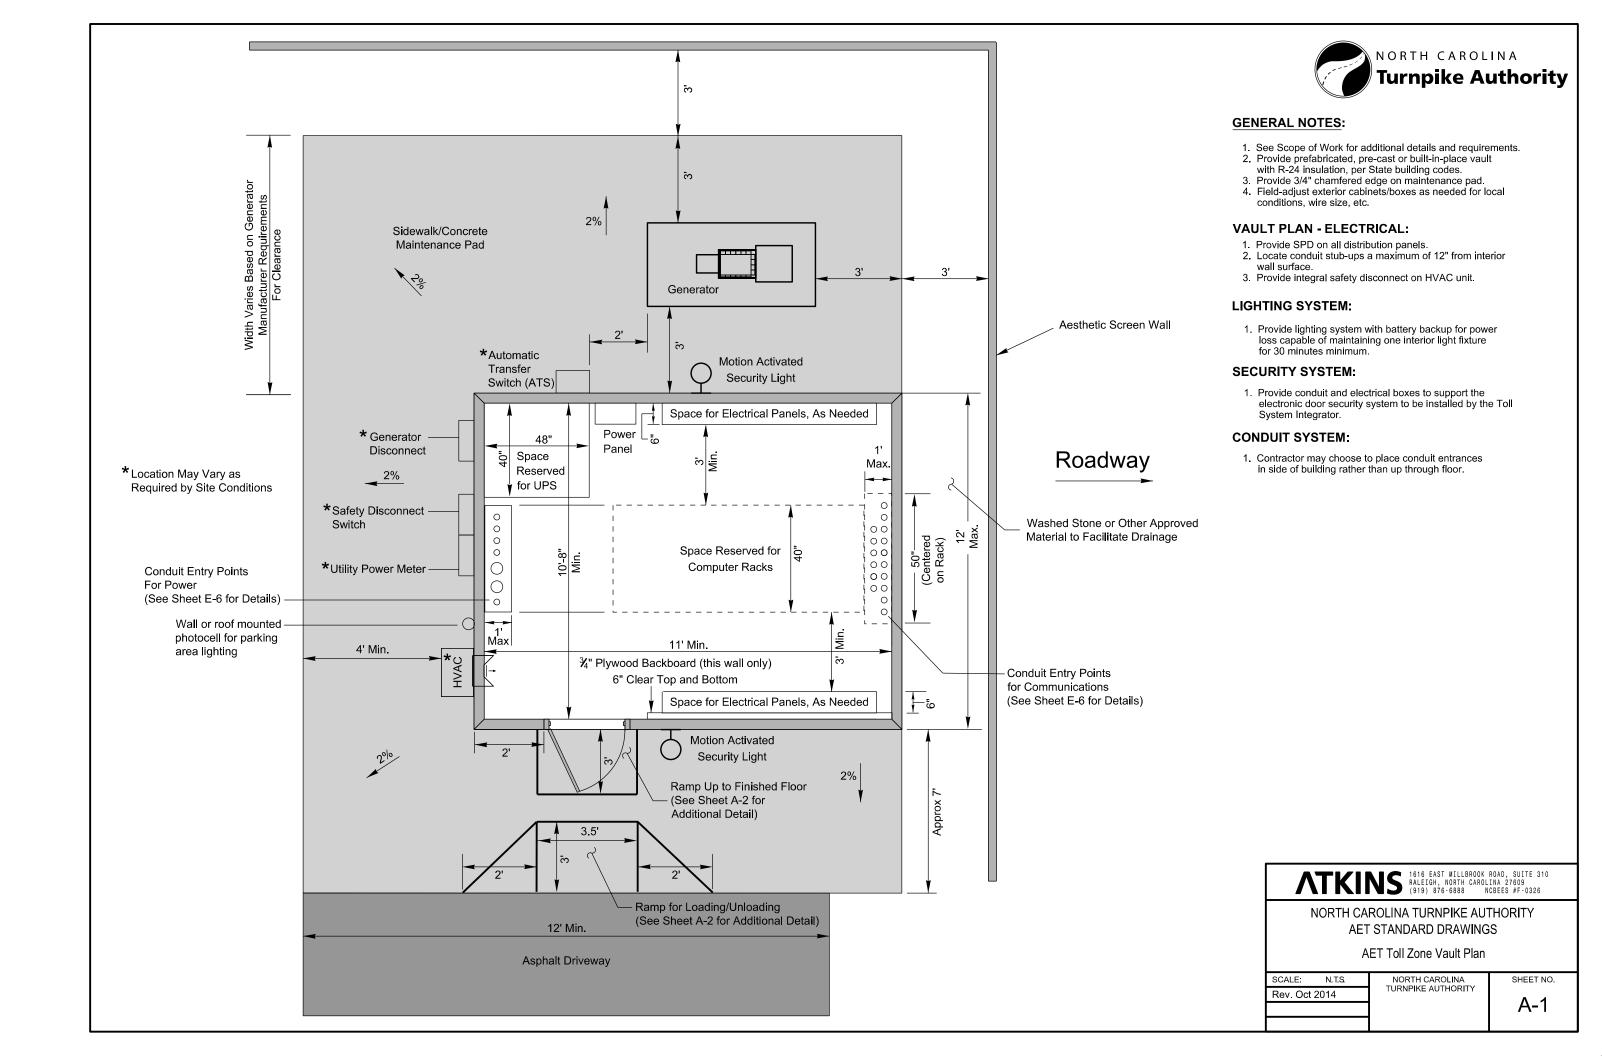
NORTH CAROLINA TURNPIKE AUTHORITY
AET STANDARD DRAWINGS

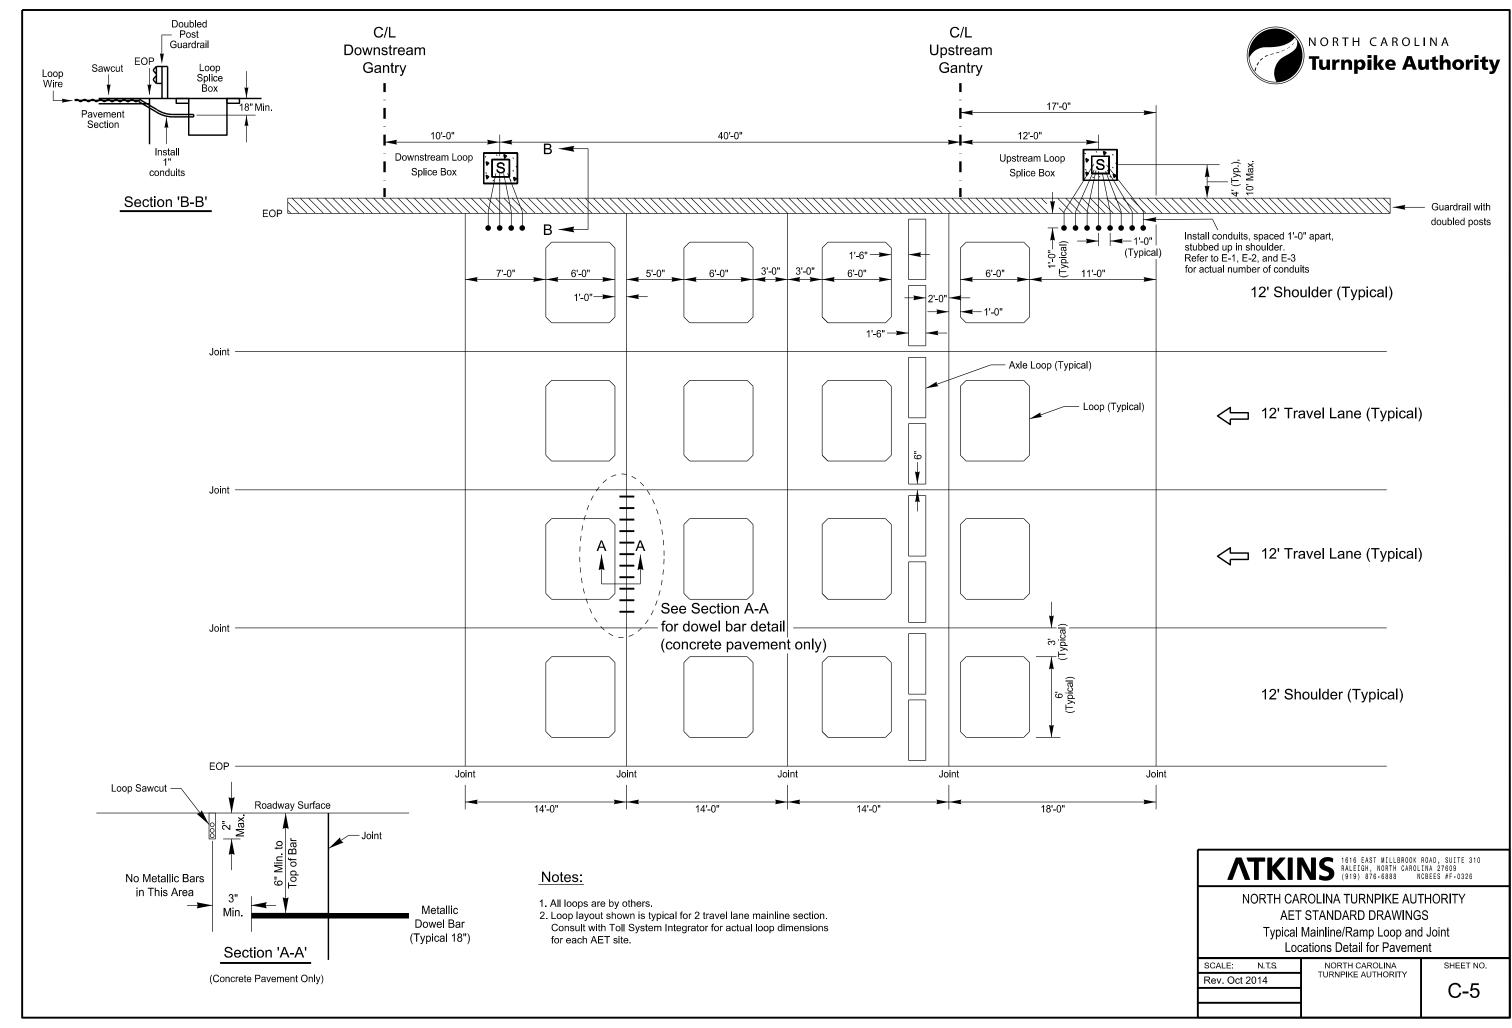Typical 2-Lane, 2-Way Loop and Joint Locations
Detail for Pavement


SCALE: N.T.S. NORTH TURNPIKI

NORTH CAROLINA TURNPIKE AUTHORITY

C-6






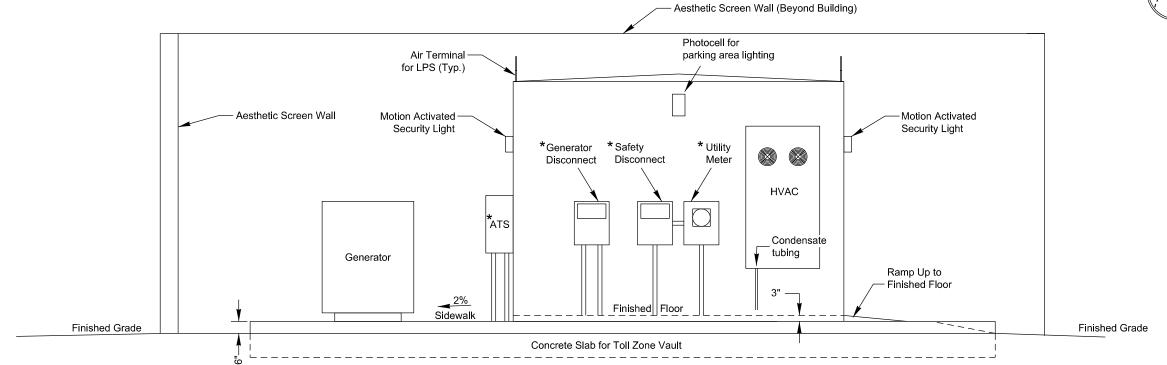

### Side Elevation Not to Scale

\* Location May Vary as Required by Site Conditions

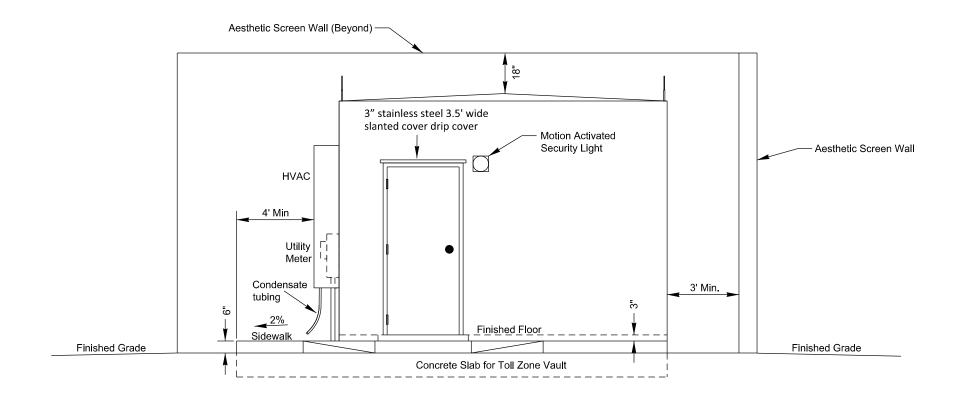

Front Elevation

Not to Scale

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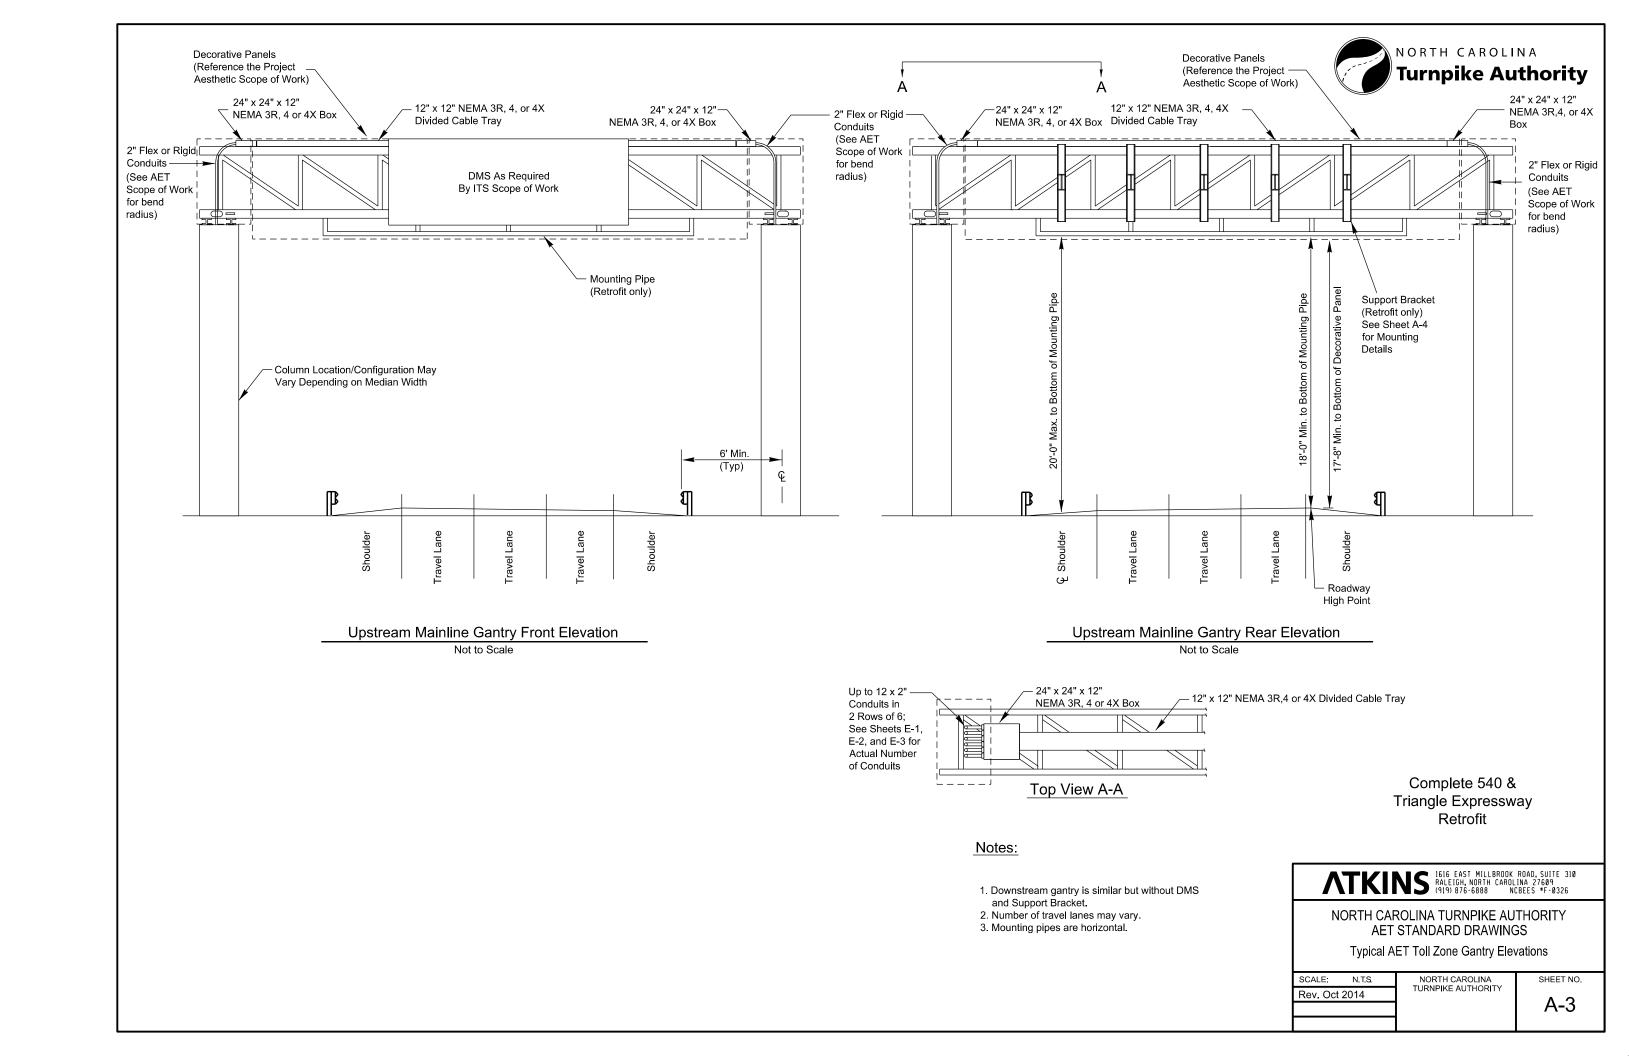
NORTH CAROLINA TURNPIKE AUTHORITY AET STANDARD DRAWINGS **AET Toll Zone Vault Elevations** 

SCALE: N.T.S SHEET NO.


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A-2








#### Notes:

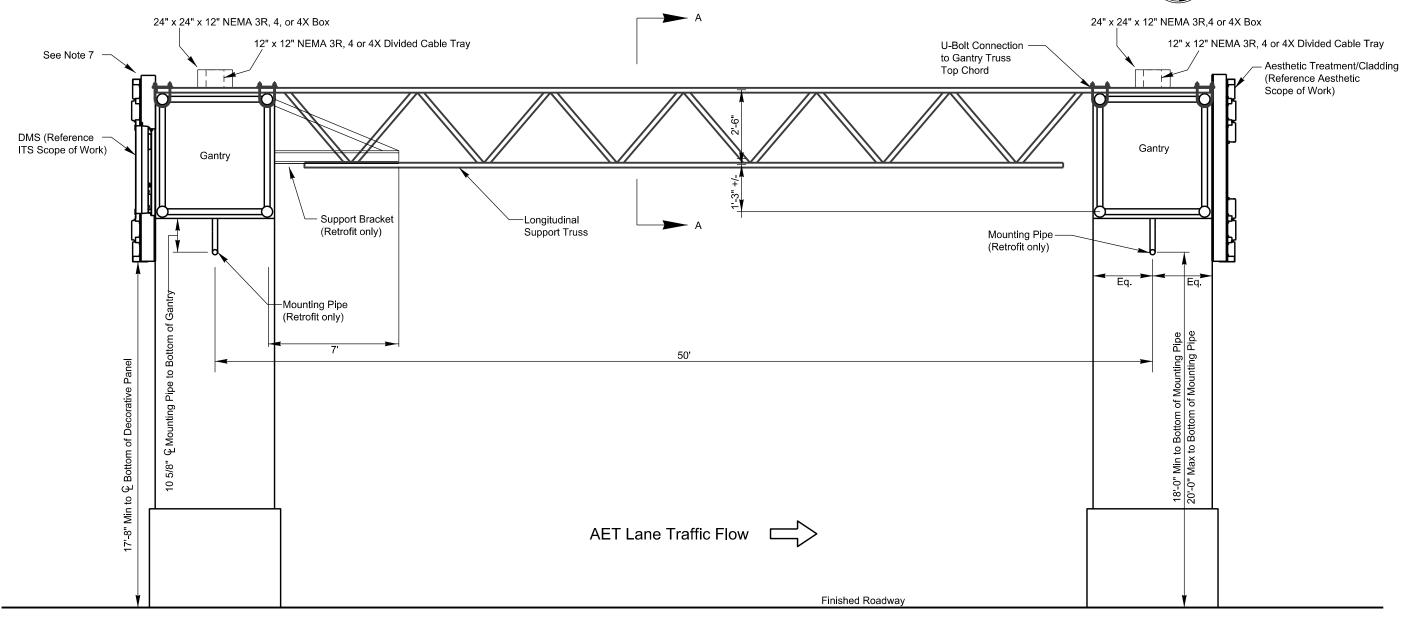- 1. All mounting heights are to the centerline of the mounting pipe.
- 2. Heights are typical for both gantries.
- 3. Install DMS per the ITS Scope of Work.
- 4. Mounting pipes:
  - Camera/Antenna 2" Rigid Galvanized Pipe. AVC/Profiler - 3" Rigid Galvanized Pipe (if mounting pipe is used)
- 5. Divided cable tray shall be watertight (NEMA 3R) and grounded on both ends per NEC.
- 6. All conduit from the divided cable tray to the top of the columns shall be concealed behind cladding or earwalls. (See Aesthetic Scope of Work for cladding details).
- 7. Top of gantry aesthetic treatment shall be higher than top of cable tray and watertight box.

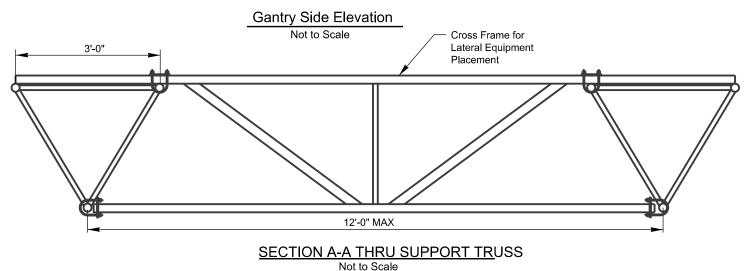

Complete 540 & Triangle Expressway Retrofit

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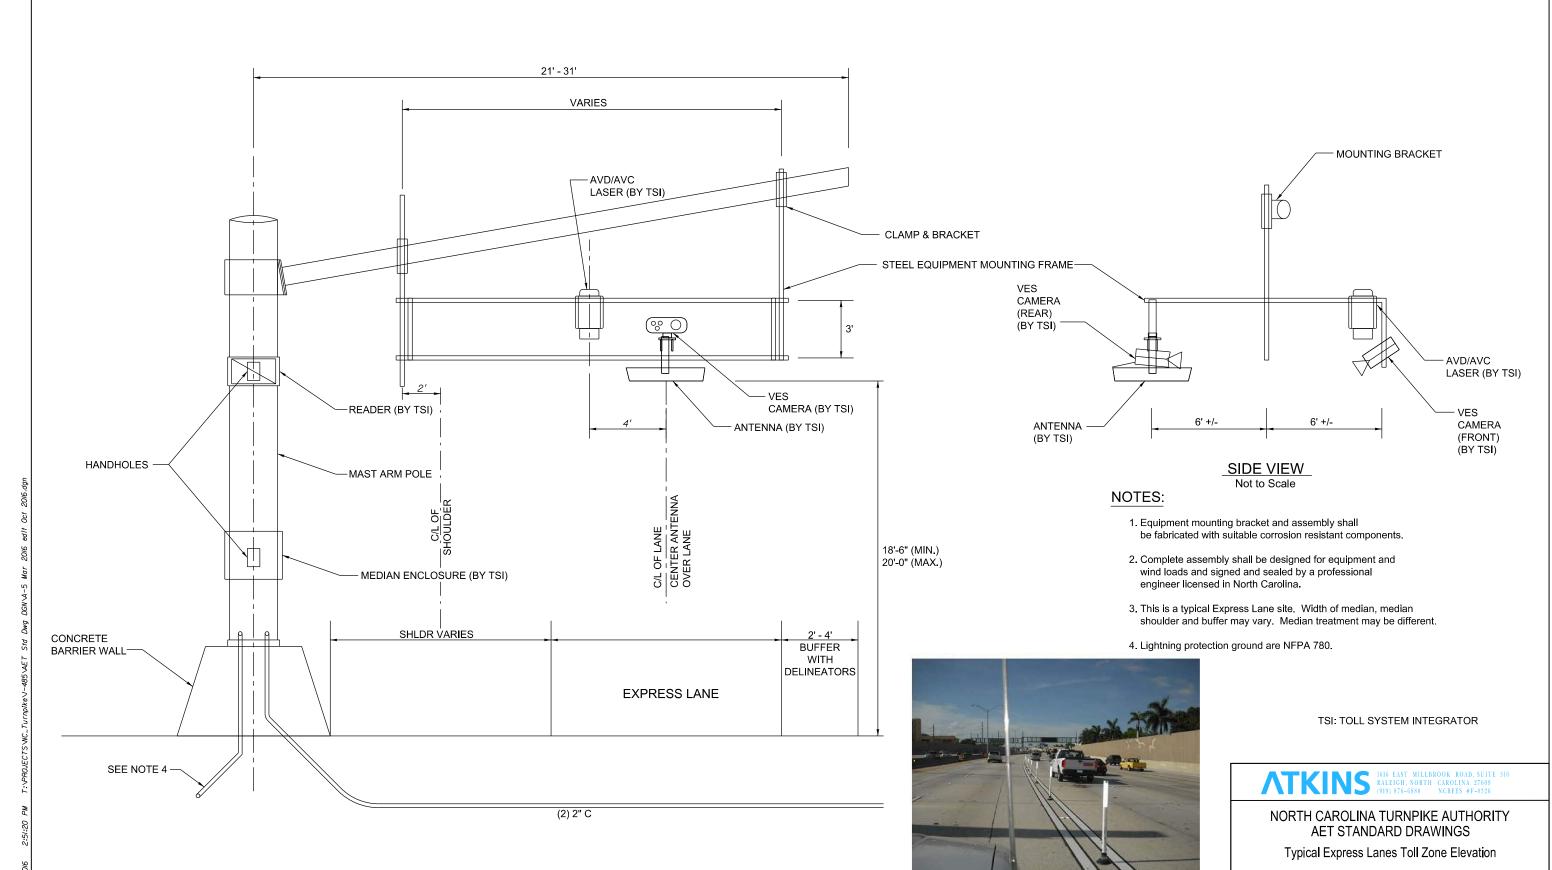
NORTH CAROLINA TURNPIKE AUTHORITY AET STANDARD DRAWINGS Typical AET Toll Zone Gantry Side Elevation

Rev. Sept. 2017

NORTH CAROLINA TURNPIKE AUTHORITY

A-4





**ELEVATION VIEW** 


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DELINEATORS EXAMPLE


SCALE: N.T.S. NORTH CAROLINA TURNPIKE AUTHORITY

AROLINA SHEET NO.

A-5



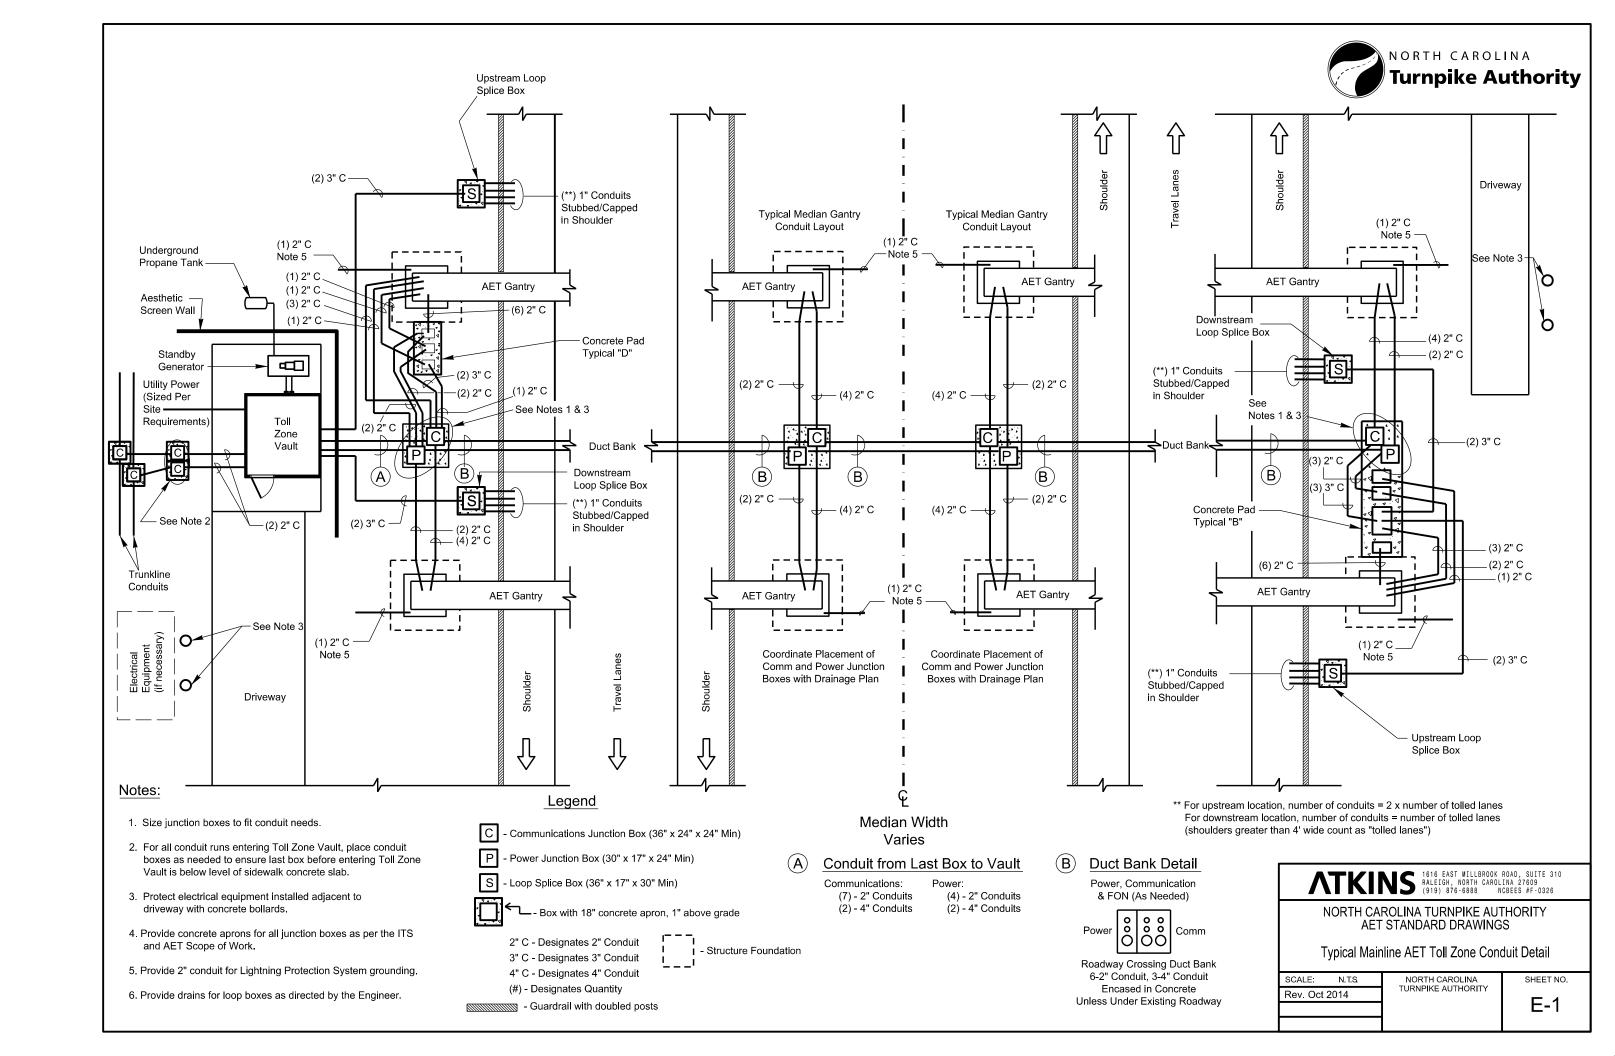

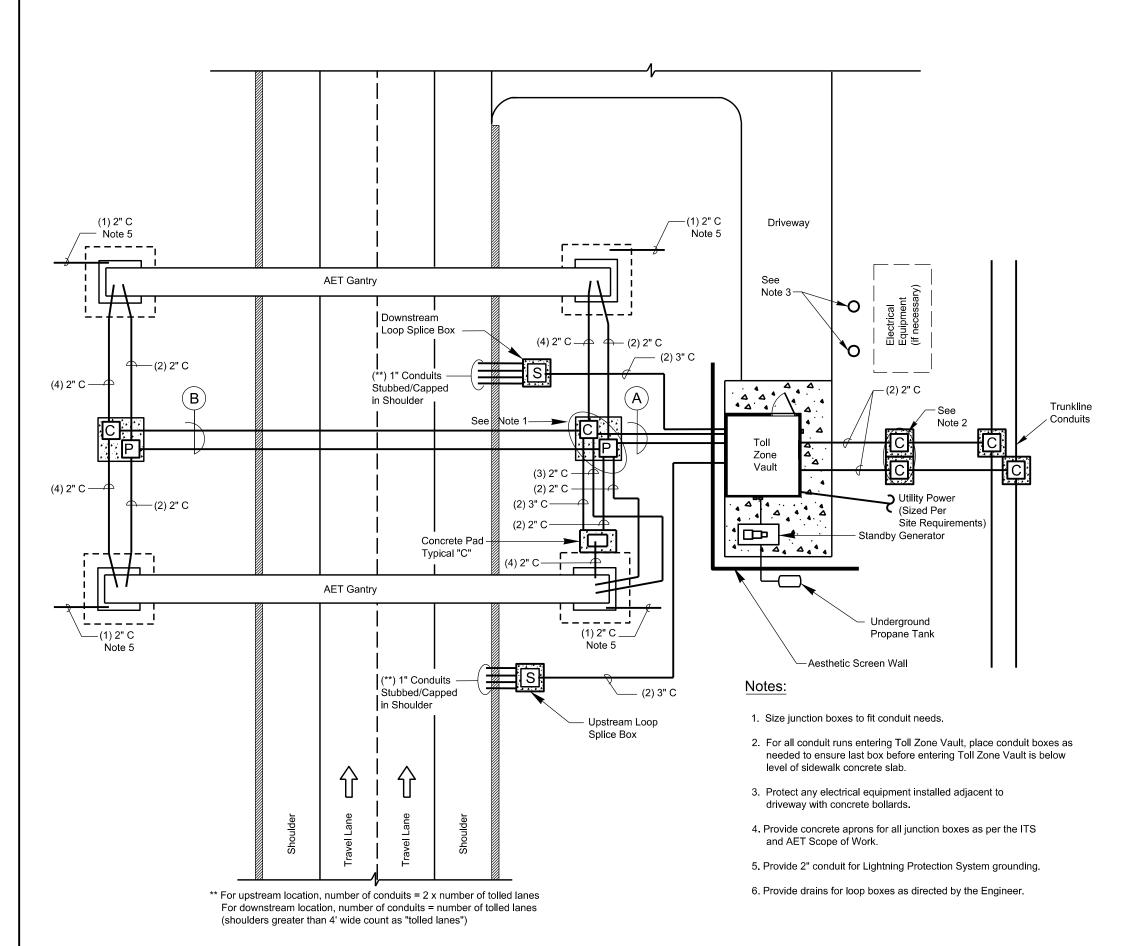

### Legend

C - Communications Junction Box (36" x 24" x 24" Min)

P - Power Junction Box (30" x 17" x 24" Min)

S - Loop Splice Box (36" x 17" x 30" Min)

Box with 18" concrete apron, 1" above grade

2" C - Designates 2" Conduit

3" C - Designates 3" Conduit

4" C - Designates 4" Conduit

(#) - Designates Quantity

📉 - Guardrail with doubled posts

I - I - Structure Foundation

### (A) Conduit from Last Box to Vault

Communications:

Power:

(7) - 2" Conduits (2) - 4" Conduits (4) - 2" Conduits

(2) - 4" Conduits

### B) Duct Bank Detail

Power, Communication & FON (As Needed)

Power O O Comr

Roadway Crossing Duct Bank 6-2" Conduit, 3-4" Conduit Encased in Concrete Unless Under Existing Roadway


ATKINS 1616 EAST MILLBROOK ROAD, SUITE 310 RALEIGH, NORTH CAROLINA 27609 (919) 876-6888 NCBEES #F-0326


NORTH CAROLINA TURNPIKE AUTHORITY
AET STANDARD DRAWINGS


Typical Ramp AET Toll Zone Conduit Detail

SCALE: N.T.S.
Rev. Oct 2014

NORTH CAROLINA TURNPIKE AUTHORITY

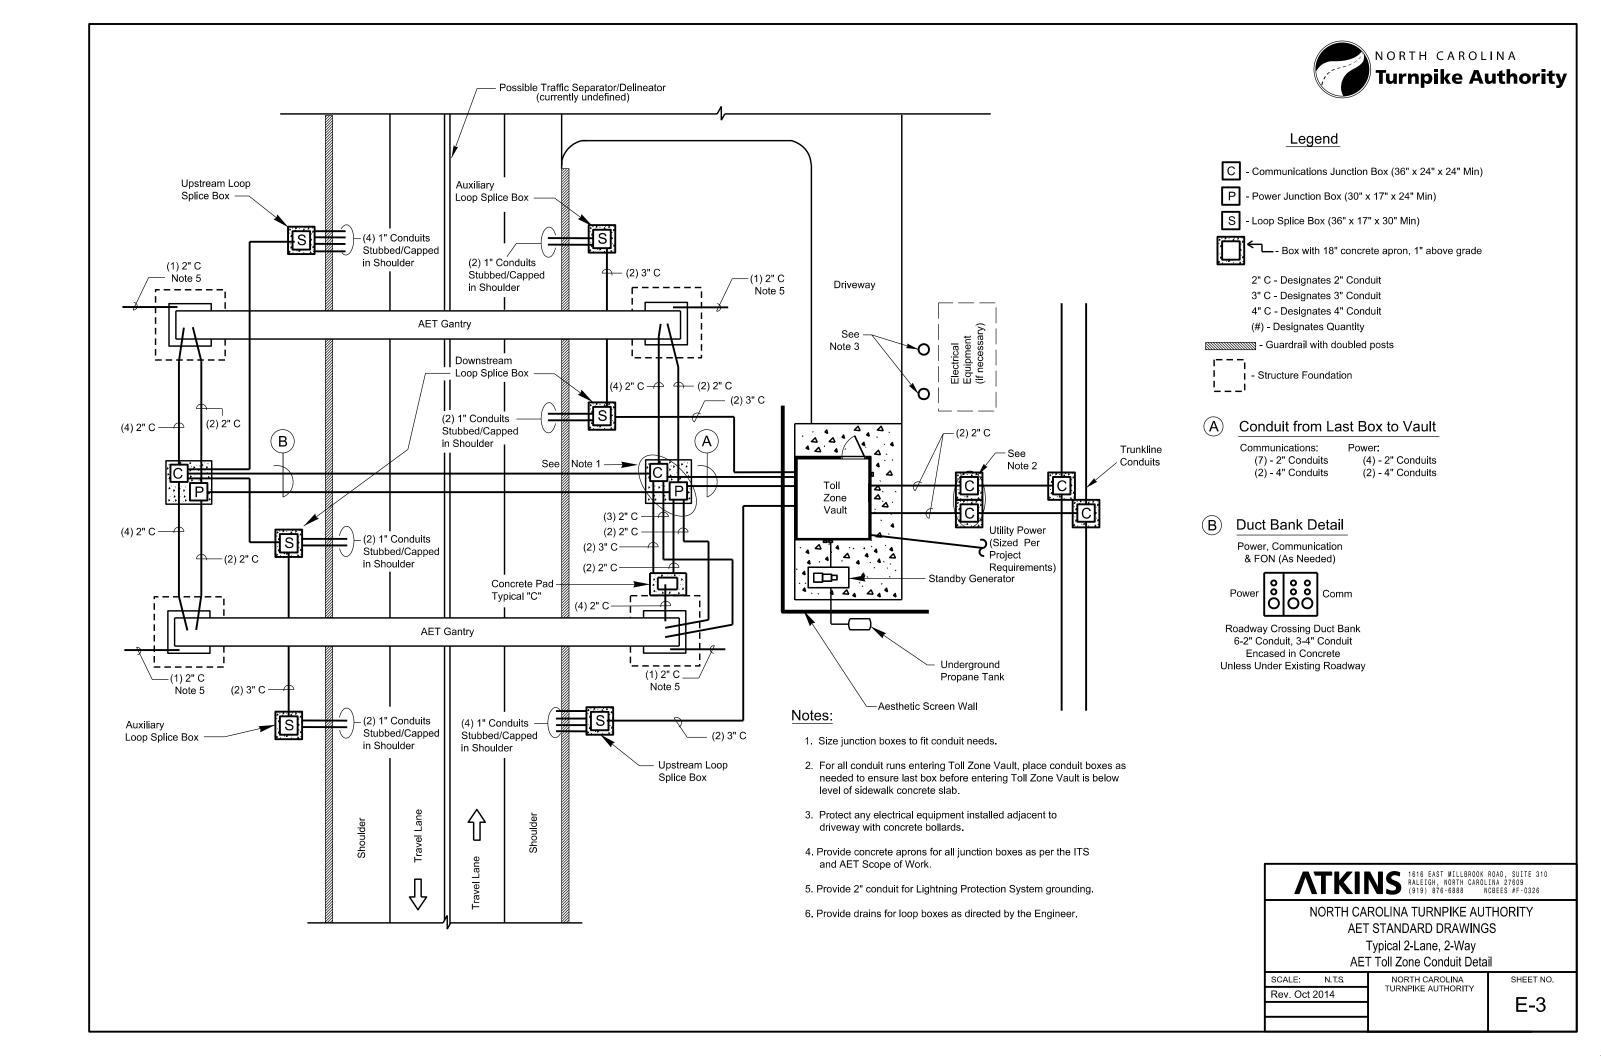

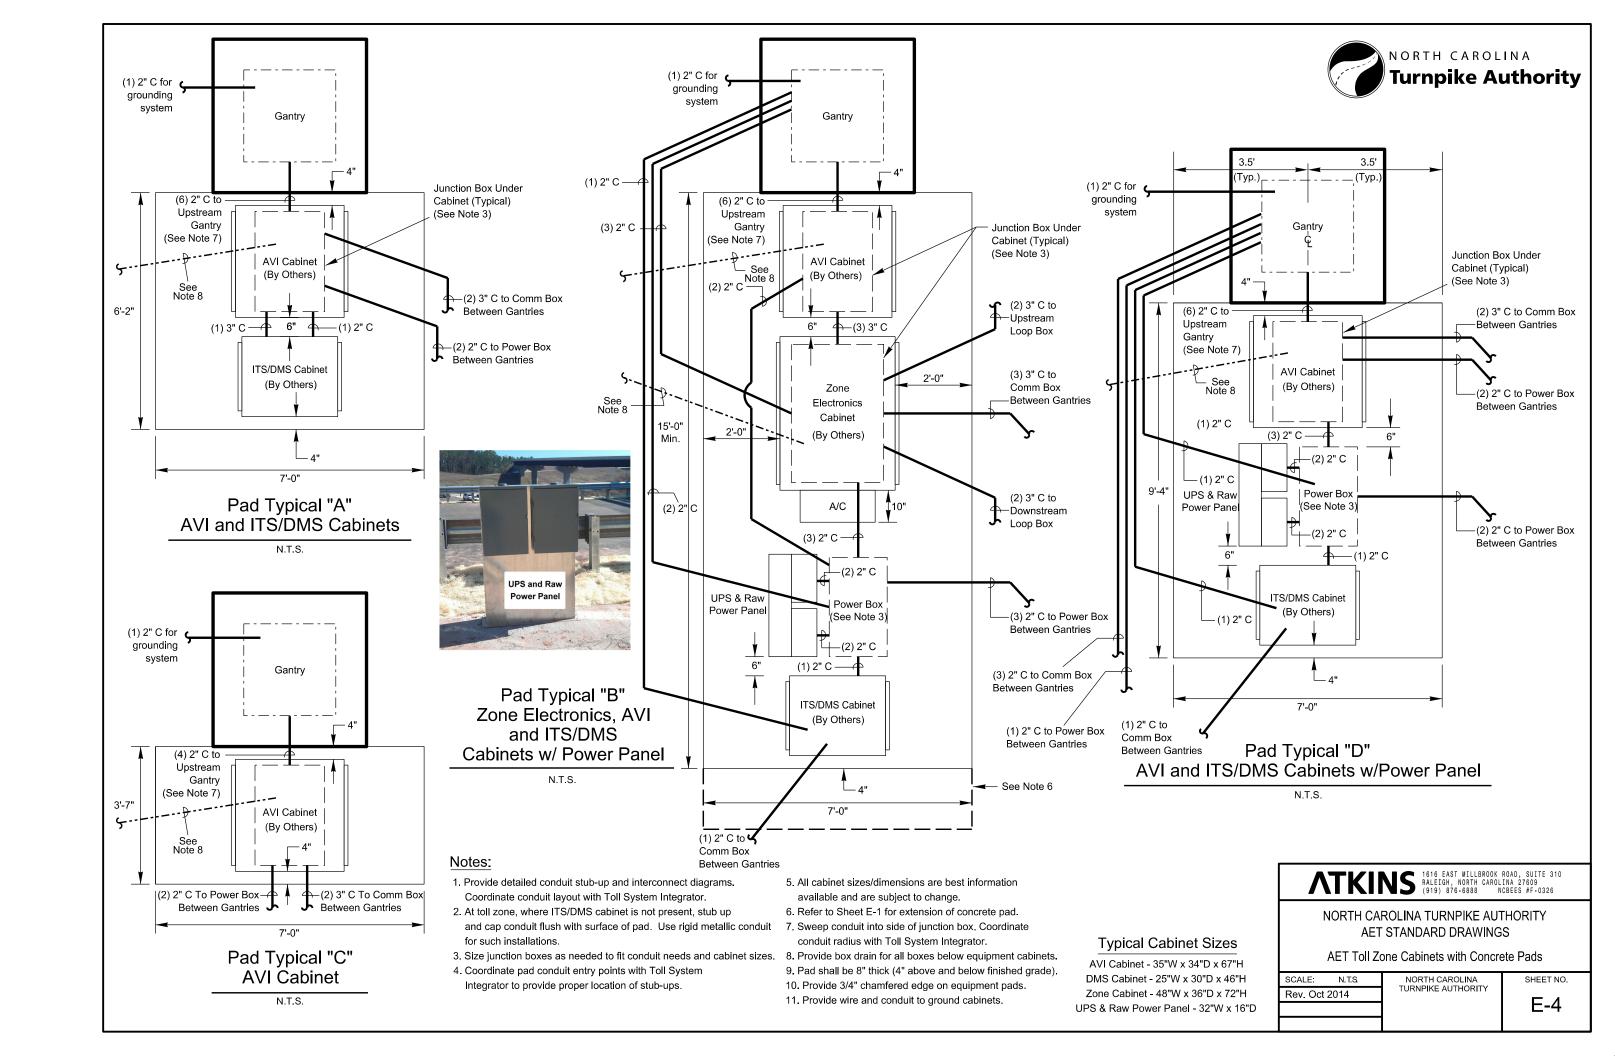

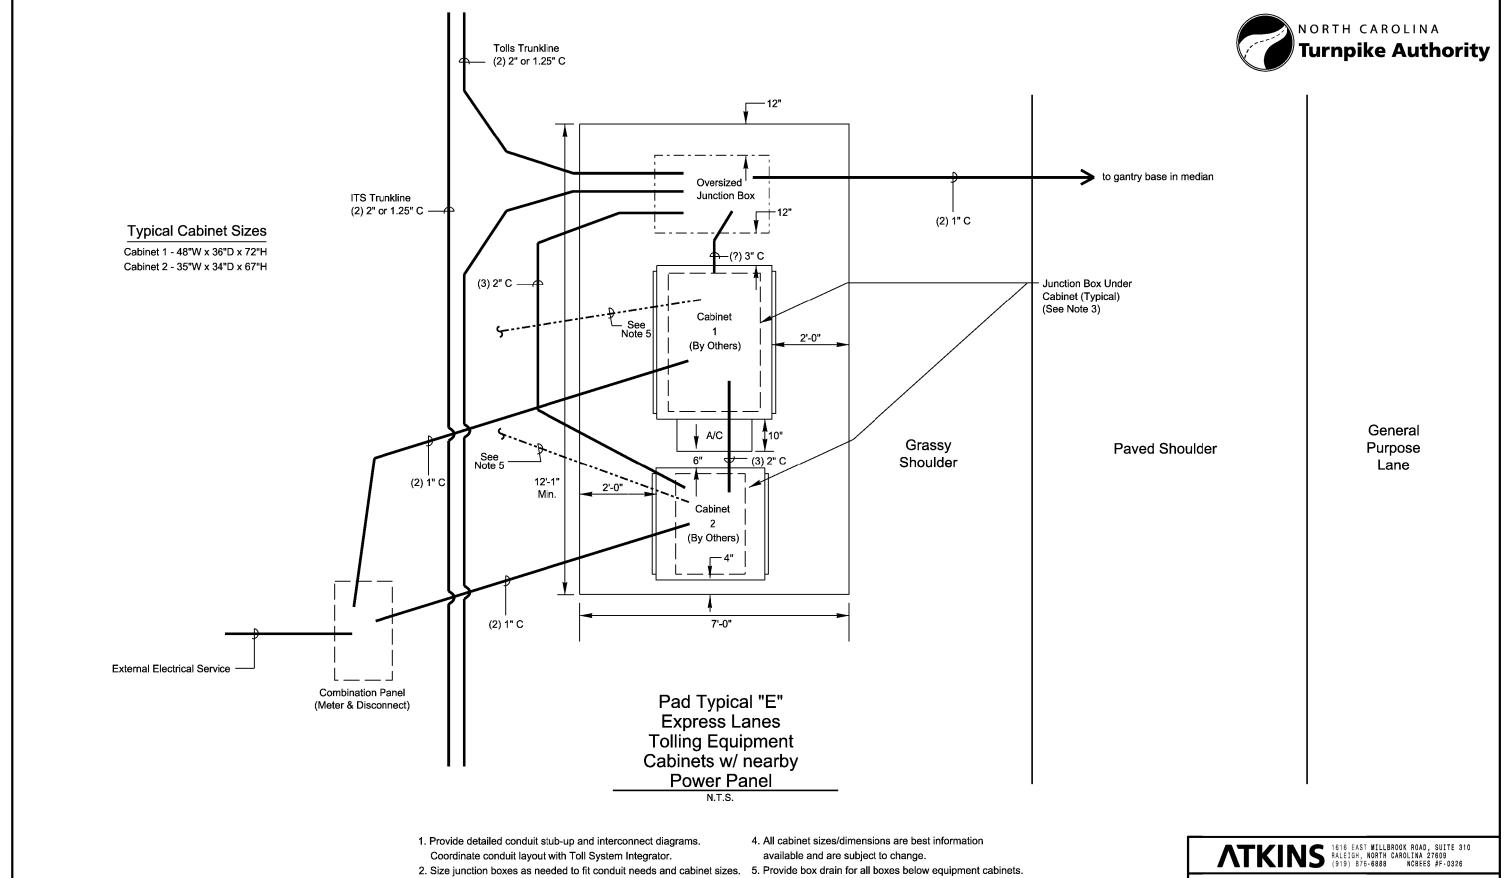

- 3. Coordinate pad conduit entry points with Toll System Integrator to provide proper location of stub-ups.
- 6. Pad shall be 8" thick (4" above and below finished grade).
- 7. Provide 3/4" chamfered edge on equipment pads.
- 8. Provide wire and conduit to ground cabinets.


NORTH CAROLINA TURNPIKE AUTHORITY AET STANDARD DRAWINGS


Express Lanes Toll Zone Cabinets with Concrete Pads

SCALE: N.T.S. Rev. Mar 2016

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E-4a



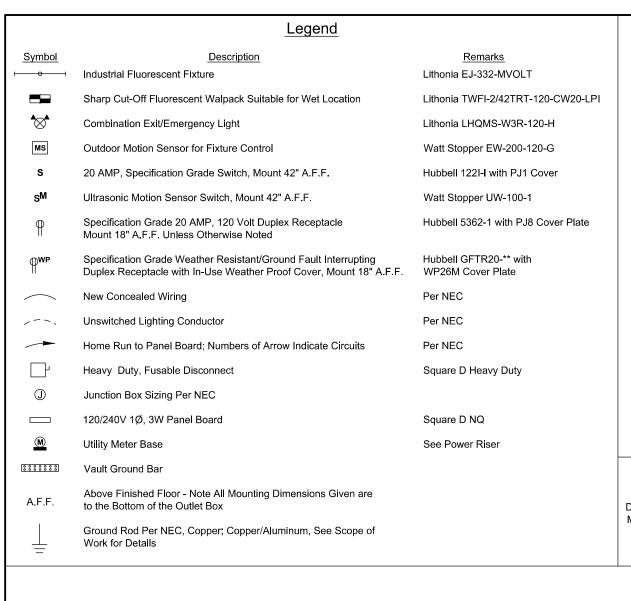

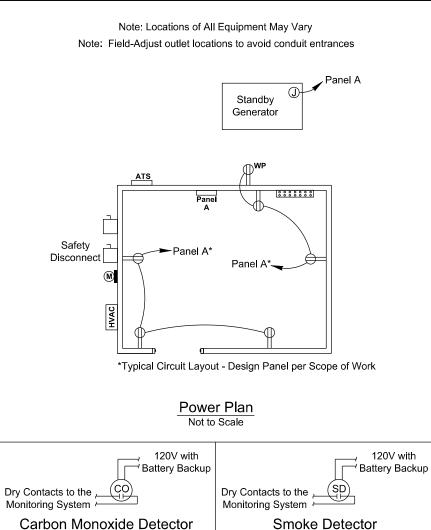Not to Scale

Not to Scale




Note: Lights and Motion Sensors may be Field Adjusted as Necessary to Provide Proper Illumination


Note: Wire outside lights directly to panel as shown

Lighting Plan

Not to Scale

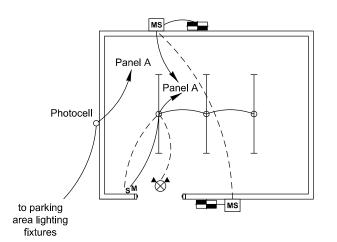

### Key Notes:

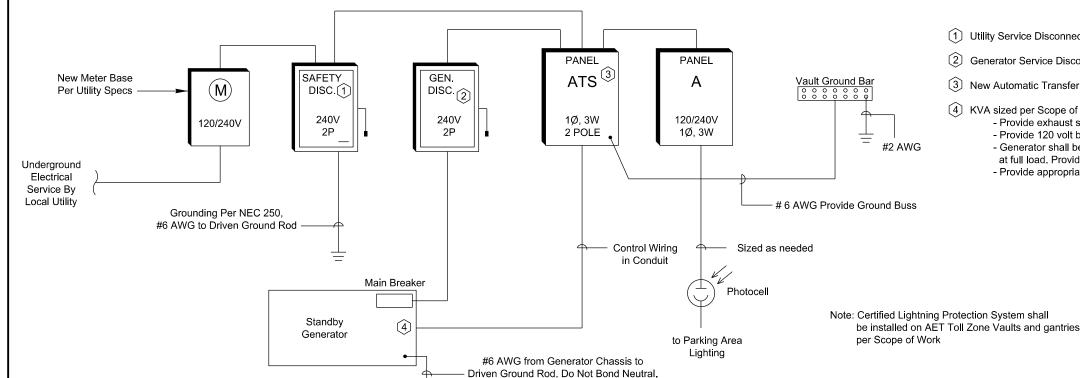

- 1 Utility Service Disconnect: Sized per Scope of Work, 2 Pole, NEMA 3R. Fuse at Rated AMPS
- ② Generator Service Disconnect: Sized per Scope of Work, 2 Pole, NEMA 3R Non Fused
- (3) New Automatic Transfer Switch: Sized per Scope of Work, Rated, 2 Pole, Neutral Conductor is not switched
- (4) KVA sized per Scope of Work 120/240 Volt, Single Phase, 3 Wire Standby Generator with the following features:
  - Provide exhaust silencer and sound attenuated weather proof enclosure
     Provide 120 volt battery charger and 120 volt jacket heater
  - Generator shall be propane (LP) gas fired. Contractor to provide fuel tank with 72 hour capacity at full load. Provide all piping, valves, and regulators
  - Provide appropriately sized circuit breakers




NORTH CAROLINA TURNPIKE AUTHORITY AET STANDARD DRAWINGS


Toll Zone Vault Electrical Plan

Rev. Oct 2014

NORTH CAROLINA SHEET NO. TURNPIKE AUTHORITY

E-5

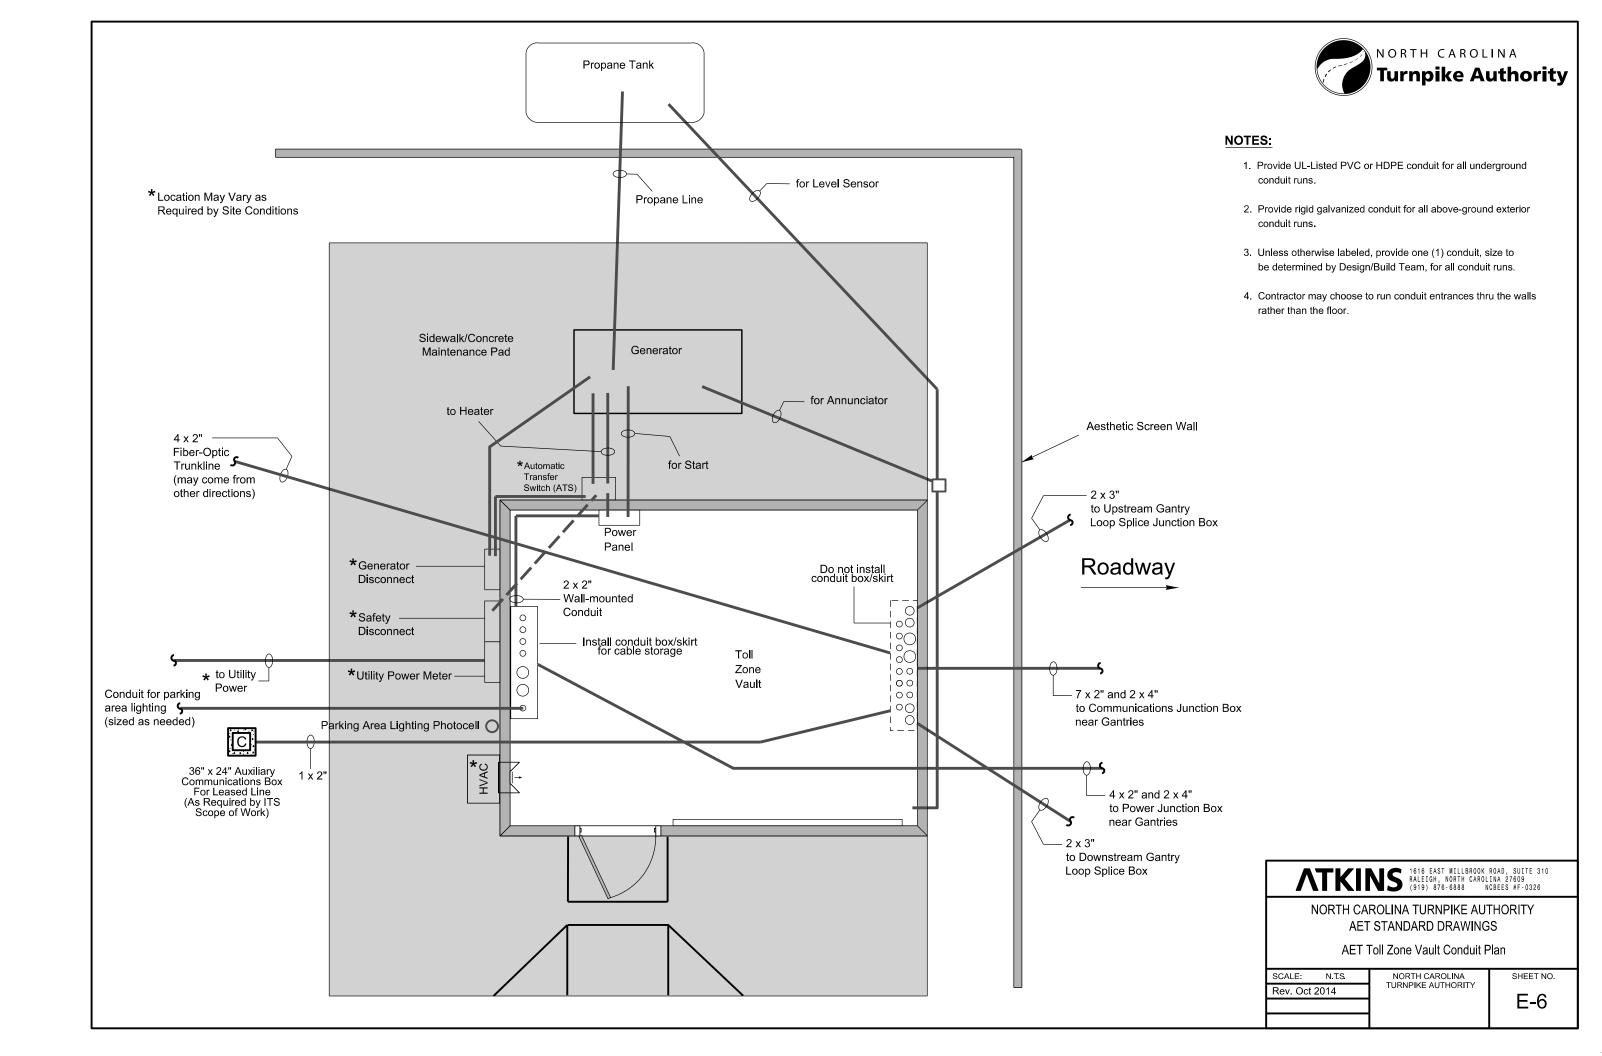

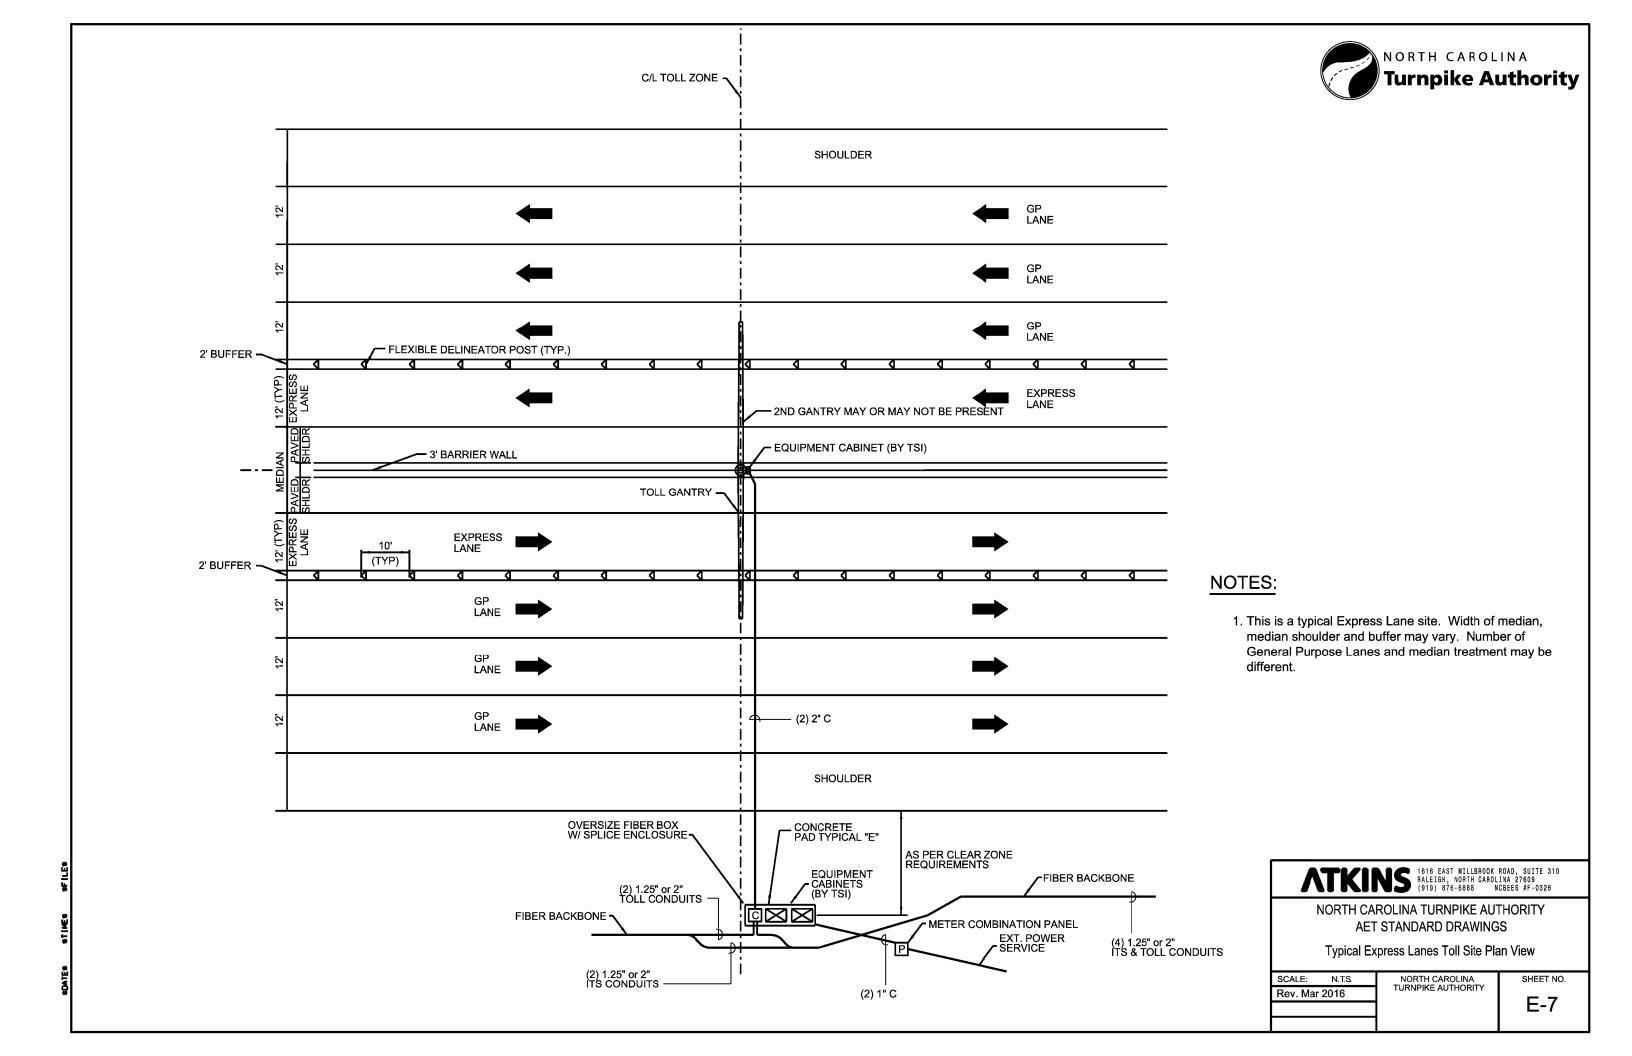

### AET STANDARD DRAWINGS - REVISIONS

Date	Sheet	Revisions
10/2014	C-1,2,3; A-3	Changed offset of column from 5' min. to 6' min. behind guardrail
10/2014	C-4,5; E-1,2,3	Clarified that barrier thru toll zone shall be double-post guard rail
10/2014	A-1, E-6	Contractor conduit may enter vault thru walls as well as floor
10/2014	A-1	Changed interior long dimension from 15' min. to 11' min.
10/2014	A-2	Added drip cover over door and condensate tubing
10/2014	A-3	Changed nomenclature associated with cable tray
10/2014	E-1,2,3	Added note regarding drains for loop boxes
10/2014	E-4	Added note to provide wire and conduit for grounding
10/2014	E-5	Added note to field-adjust outlets; added note regarding wiring of outside notes
04/2015	C-4	Added details for the smaller driveway for locations without vault
03/2016	A-5,E-7,E-4a	Added new sheets for typical Express Lanes toll zones/sites

