
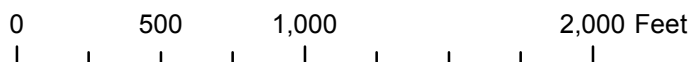


Emergency Shoreline Stabilization
SR 1142 Waterlily Road
Currituck County Quad Name Barco

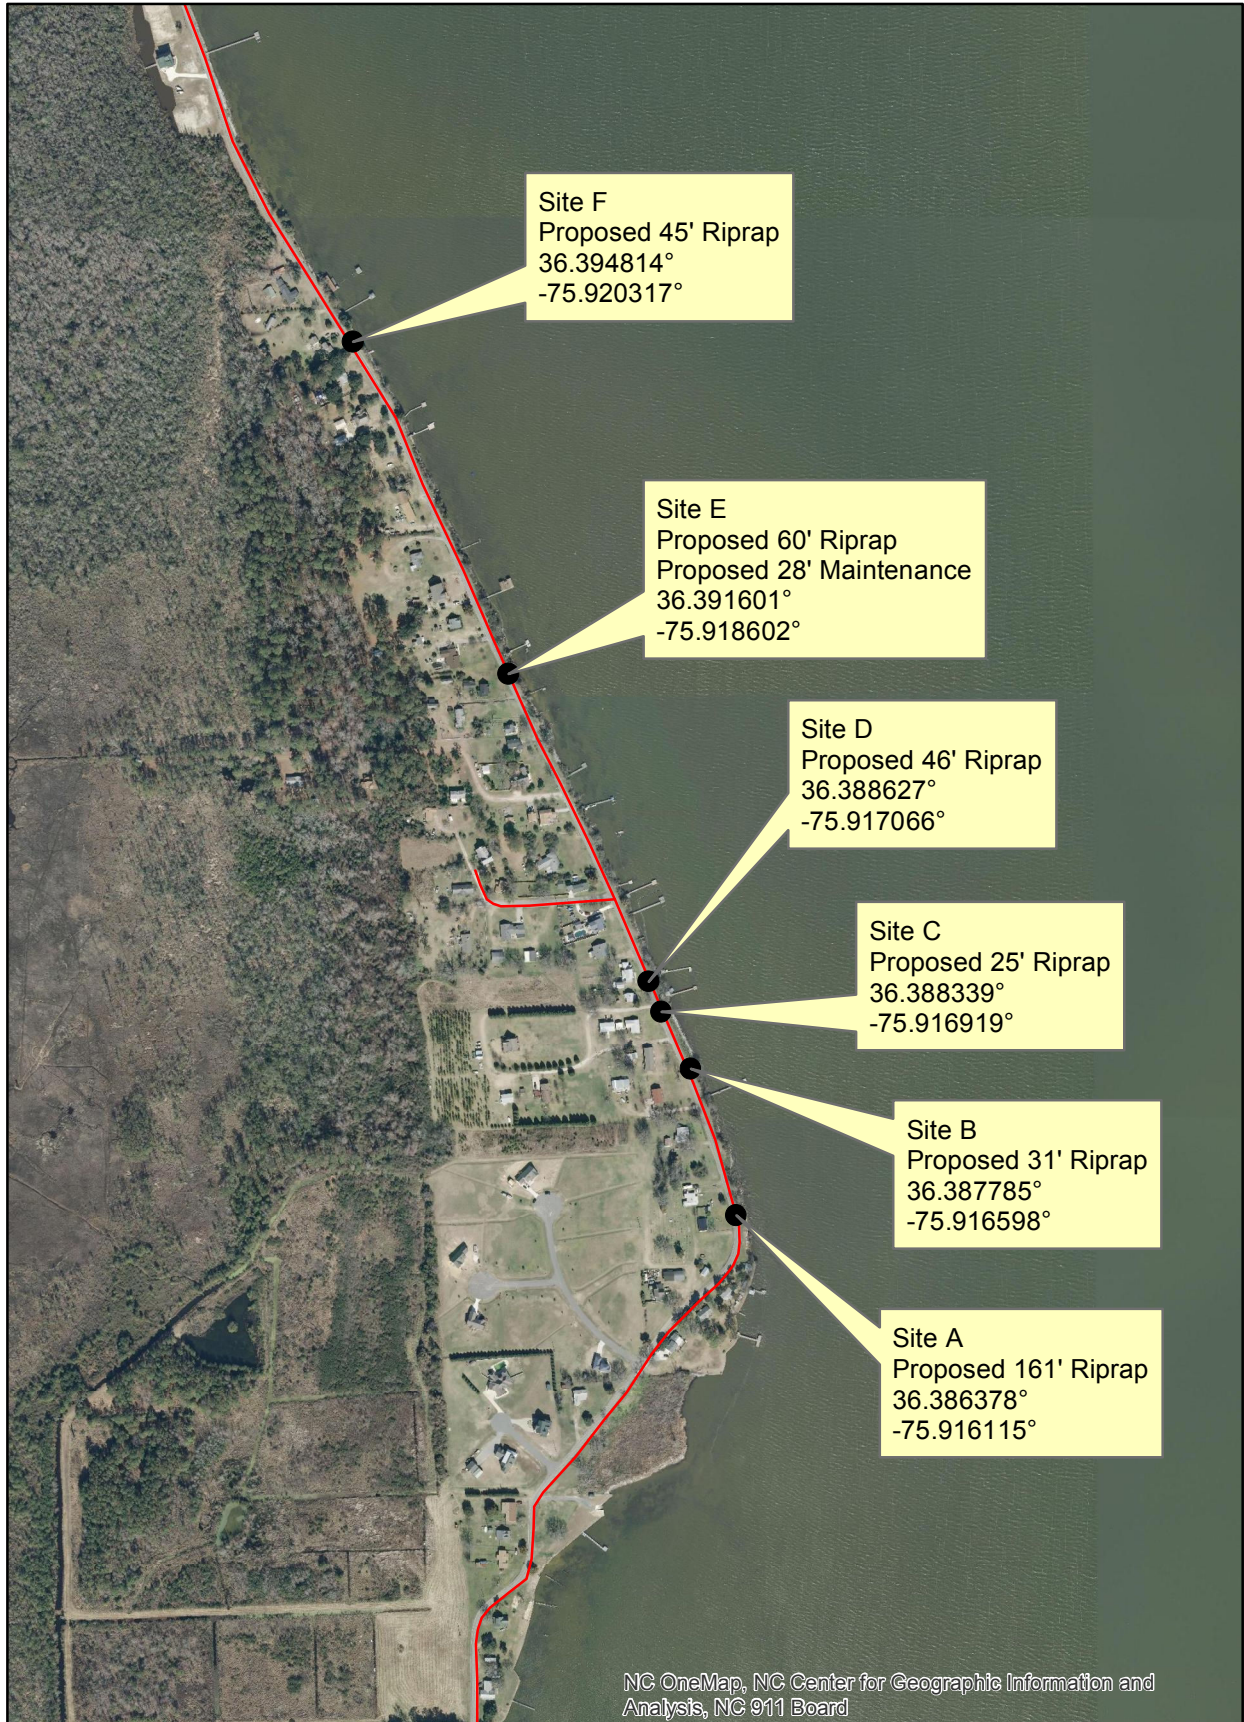

CURT W. AND MITCHELL A. COREY
805 WINSTON SALEM AVE.
VIRGINIA BEACH, VA 23451

WATERLILY ROAD EMERGENCY SHORELINE STABILIZATION


DIANA SNOWDEN LAMOUNTAIN
4500 HEMWAY RD.
CHESTER, VA 23831

ROBERT E. HALSTEAD
1051 WATERLILY RD.
COINJOCK, NC 27923

← 0.77 MILES TO SR 1154

SR 1142 WATERLILY ROAD

TO SITE B →

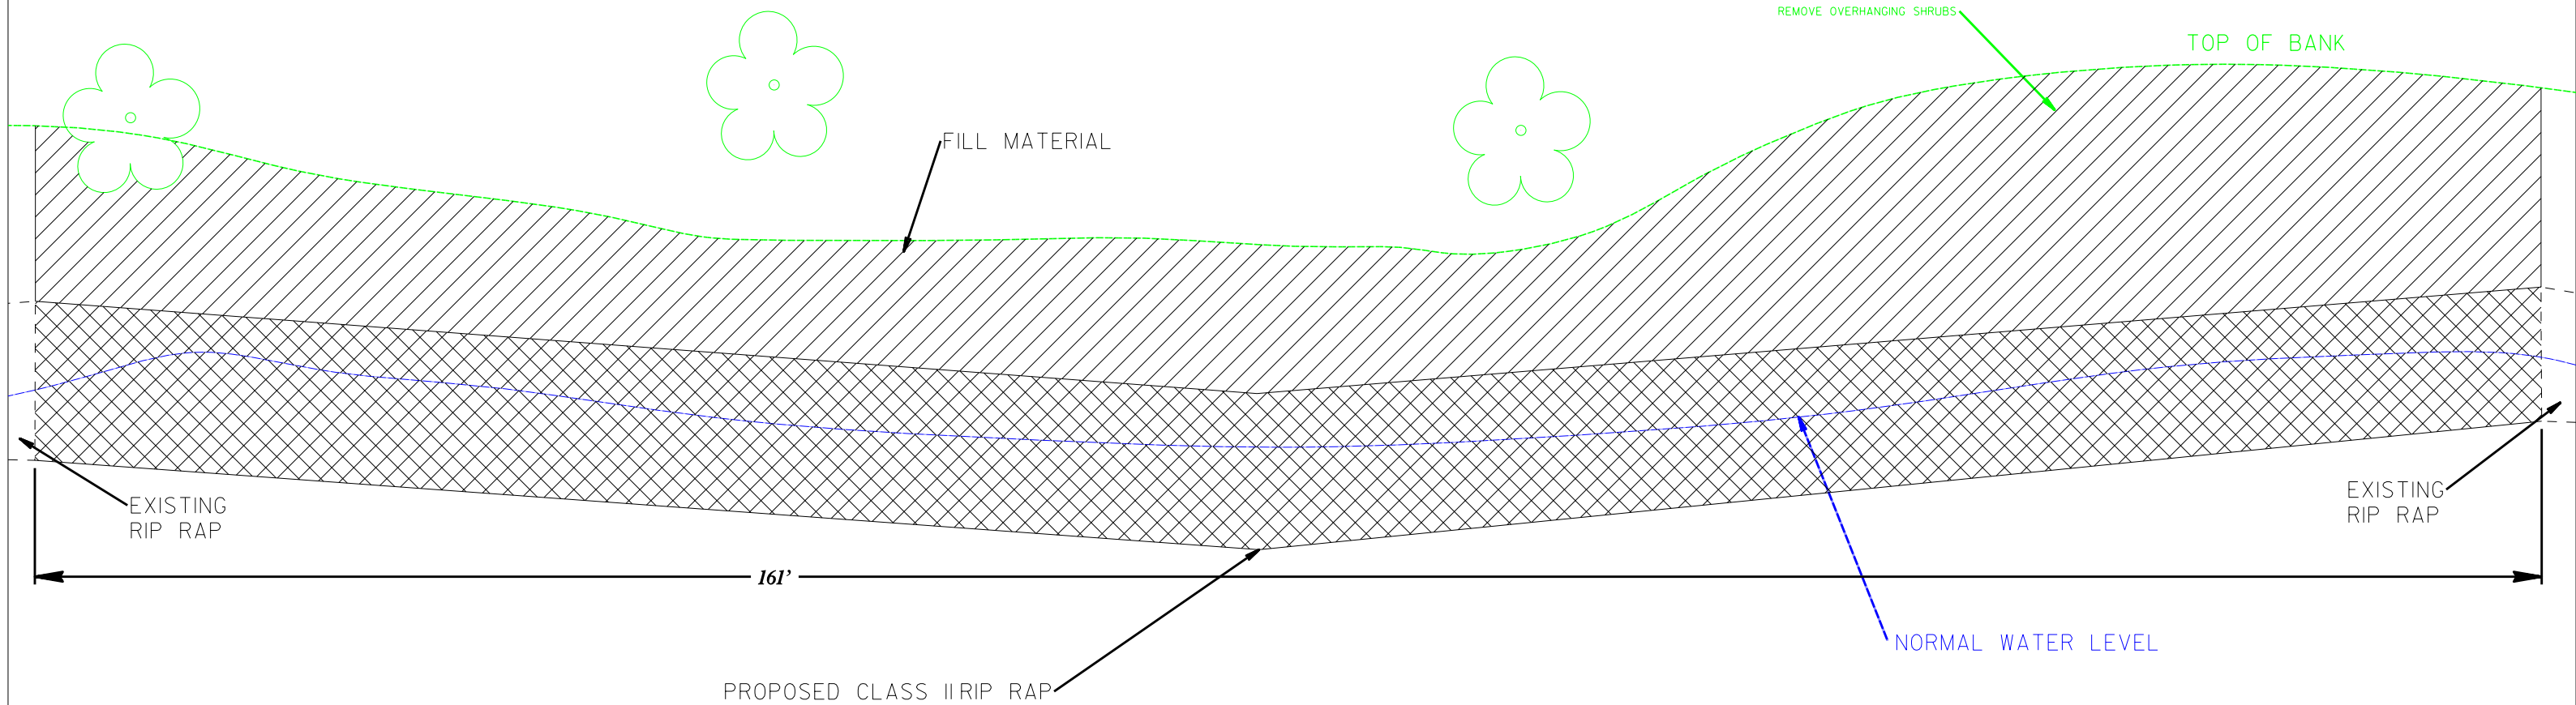

NC DEPT. OF TRANSPORTATION

COUNTY: CURRITUCK
 QUAD: BARCO
 BASIN: PASQUOTANK
 PROJECT: SHOULDER STABILIZATION
 WBS ELEMENT: DF14701.2027010
 SCALE: 1" = 10'
 DATE: 10/14/2015
 DRAWN BY: PAUL WILLIAMS

SURFACE WATER IMPACT 954 SQ. FT.

CURRITUCK SOUND

SITE A

N 36.386378°
W 75.916115°

WAYNETTE TWIFORD SPEIGHT
1067 WATERLILY RD.
COINJOCK, NC 27923

WATERLILY ROAD
EMERGENCY SHORELINE STABILIZATION

AMY SPEIGHT MCSPADDEN
1073 WATERLILY RD.
COINJOCK, NC 27923



← **TO SITE A**

SR 1142 WATERLILY ROAD

TO SITE C →

FILL MATERIAL

TOP OF BANK

EXISTING
RIP RAP

NORMAL WATER LEVEL

EXISTING
RIP RAP

PROPOSED CLASS II RIP RAP

31'

CURRITUCK SOUND

NC DEPT. OF TRANSPORTATION

COUNTY:	CURRITUCK
QUAD:	BARCO
BASIN:	PASQUOTANK
PROJECT:	SHOULDER STABILIZATION
WBS ELEMENT:	DF14701.2027010
SCALE:	1" = 10'
DATE:	10/22/2015
DRAWN BY:	PAUL WILLIAMS

N 36.387785°
W 75.916598°

SITE B


SURFACE WATER IMPACT : 181 SQ. FT.

WAYNE PENN TWIFORD, SR
1075 WATERLILY RD.
COINJOCK, NC 27923

WATERLILY ROAD
EMERGENCY SHORELINE STABILIZATION

JOY DENISE EVANS
100 BAYVIEW DR.
AYDLETT, NC 27916


PROPERTY LINE

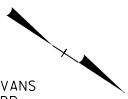

← TO SITE B

SR 1142 WATERLILY ROAD

TO SITE D →

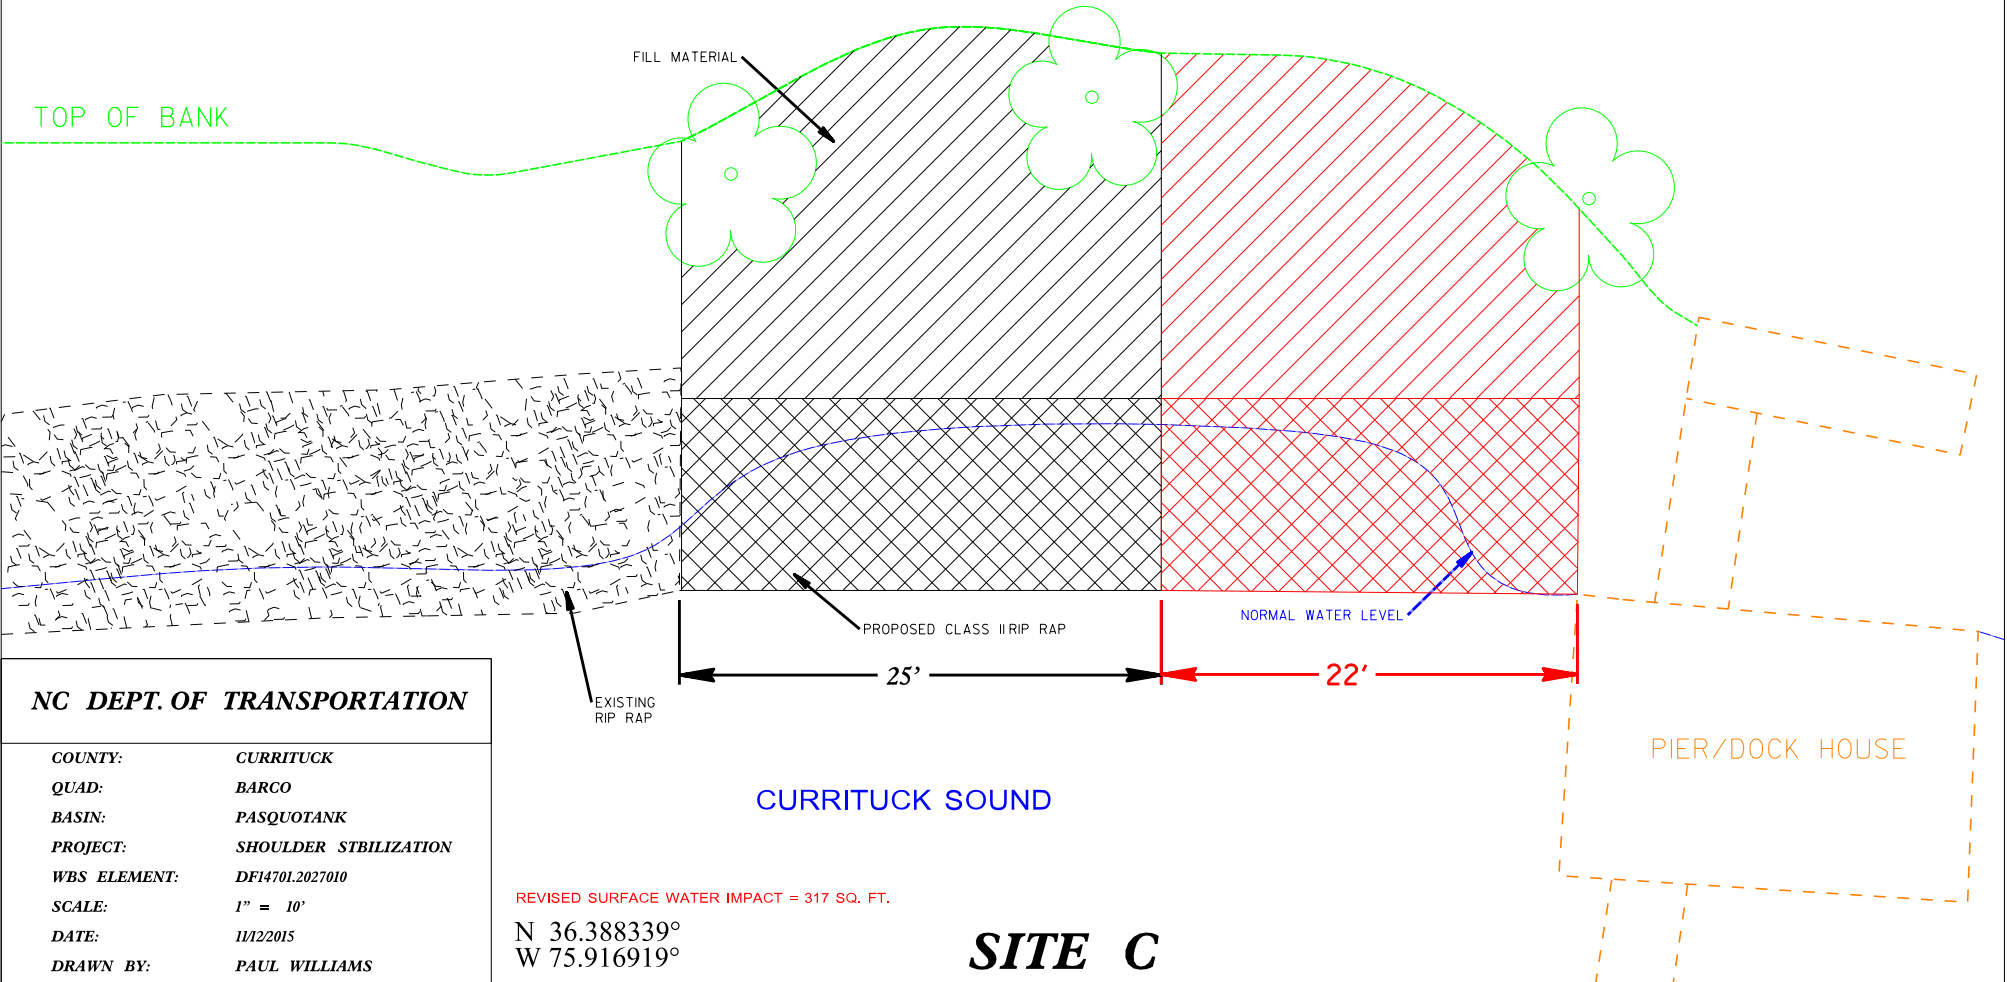

NC DEPT. OF TRANSPORTATION

COUNTY: CURRITUCK
QUAD: BARCO
BASIN: PASQUOTANK
PROJECT: SHOULDER STABILIZATION
WBS ELEMENT: DF14701.2027010
SCALE: 1" = 10'
DATE: 11/22/2015
DRAWN BY: PAUL WILLIAMS

REVISED SURFACE WATER IMPACT = 317 SQ. FT.

N 36.388339°
W 75.916919°

SITE C

JOY DENISE EVANS
100 BAYVIEW DR.
AYDLETT, NC 27916

WATERLILY ROAD
EMERGENCY SHORELINE STABILIZATION

DONALD & BRENDA MACEOIN
44426 LIVONIA TER.
ASHBURN, VA 20147




PROPERTY LINE

← TO SITE C

SR 1142 WATERLILY ROAD

TO SITE E →

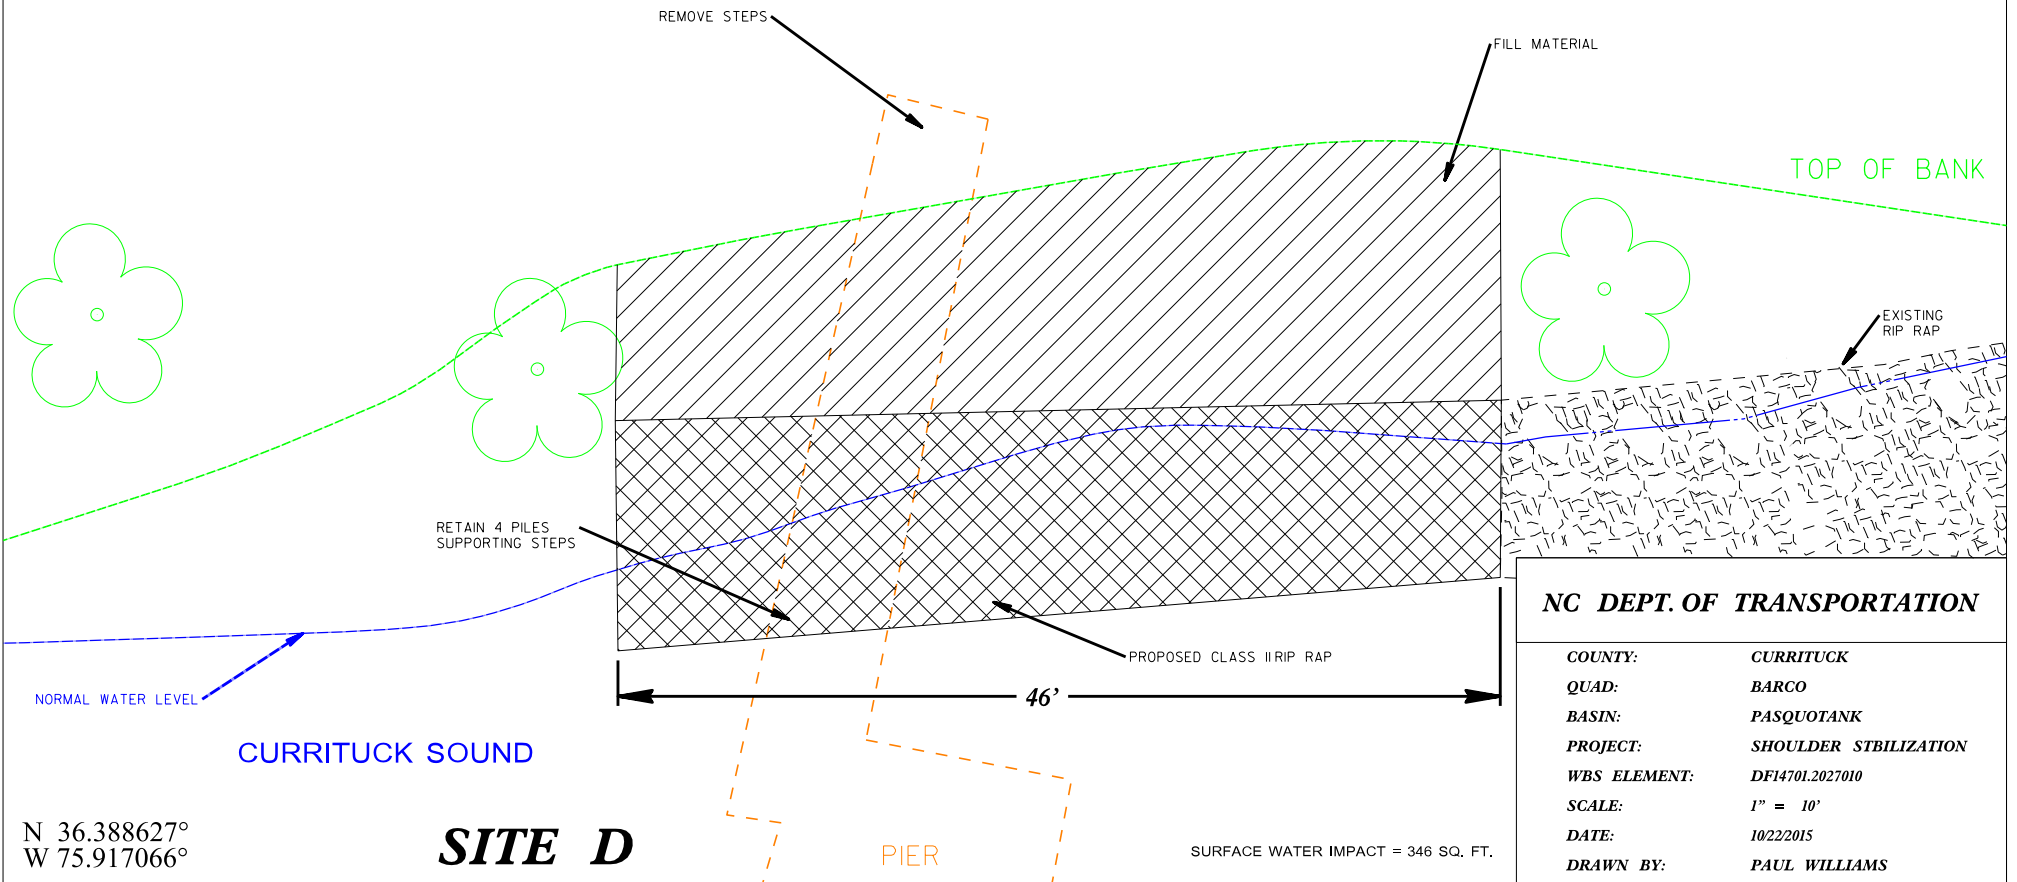

NORMAL WATER LEVEL

CURRITUCK SOUND

SITE D

N 36.388627°
W 75.917066°

PIER

SURFACE WATER IMPACT = 346 SQ. FT.

NC DEPT. OF TRANSPORTATION

COUNTY:	CURRITUCK
QUAD:	BARCO
BASIN:	PASQUOTANK
PROJECT:	SHOULDER STABILIZATION
WBS ELEMENT:	DF14701.2027010
SCALE:	1" = 10'
DATE:	10/22/2015
DRAWN BY:	PAUL WILLIAMS

EVELYN & JOHN DOUGLASS
1127 WATERLILY RD
COINJOCK, NC 27923

WATERLILY ROAD
EMERGENCY SHORELINE STABILIZATION


MELISSA LEE HENLEY SHELL
1135 WATERLILY RD
COINJOCK, NC 27923



← TO SITE D

SR 1142 WATERLILY ROAD

TO SITE F →

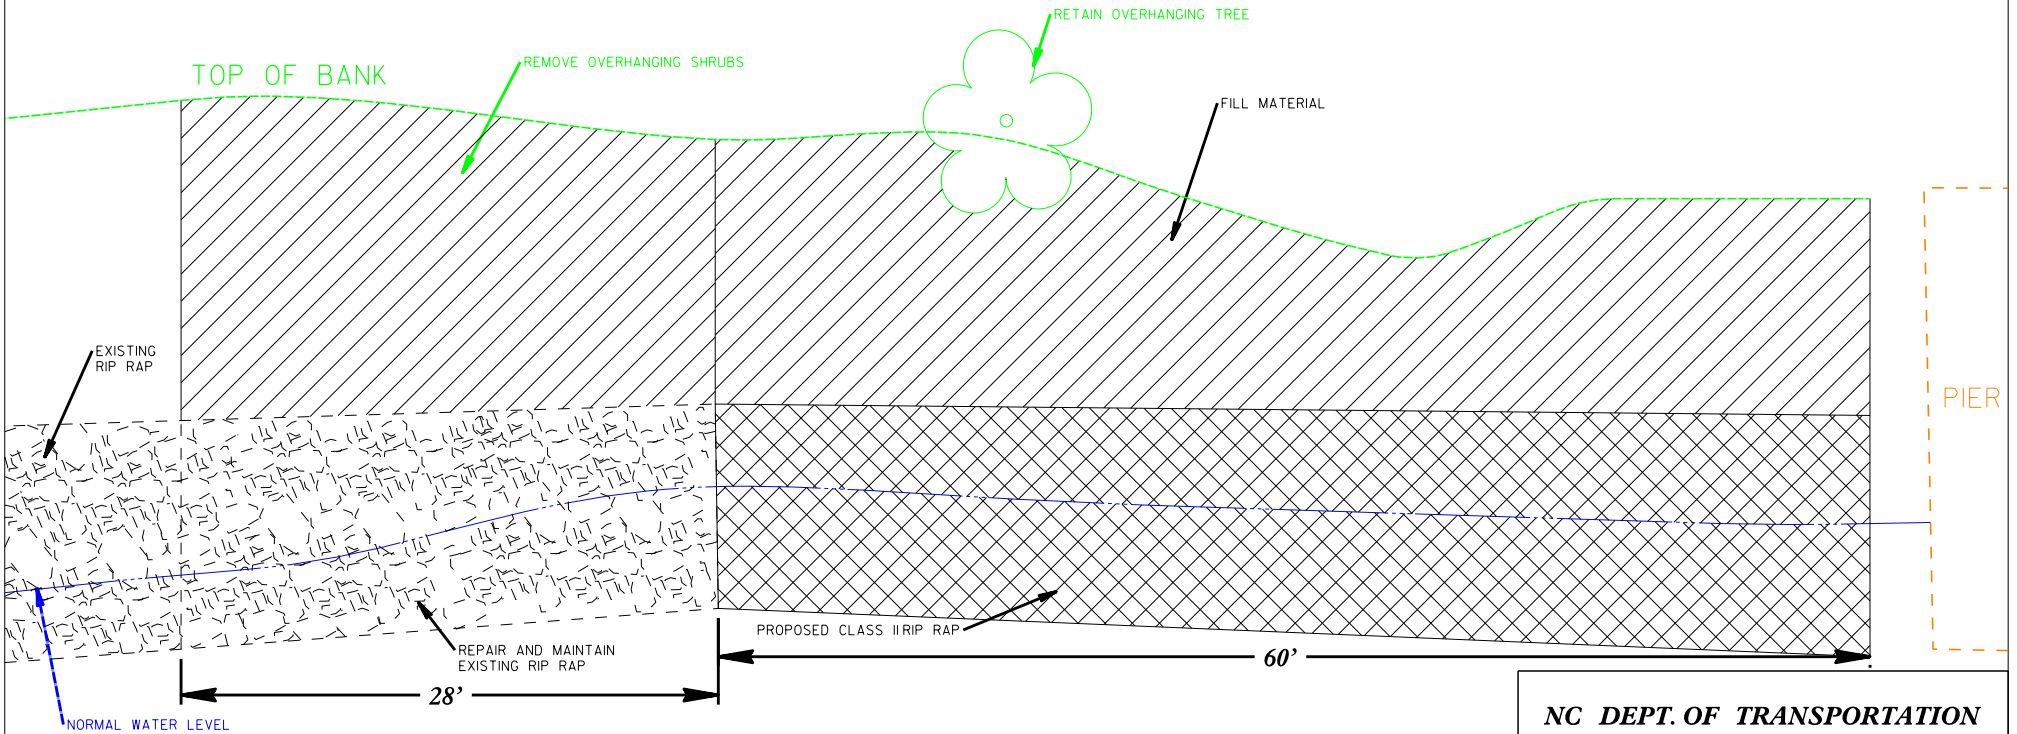

CURRITUCK SOUND

N 36.391601°
W 75.918602°


SITE E

SURFACE WATER IMPACT = 389 SQ. FT.

NC DEPT. OF TRANSPORTATION	
COUNTY:	CURRITUCK
QUAD:	BARCO
BASIN:	PASQUOTANK
PROJECT:	SHOULDER STABILIZATION
WBS ELEMENT:	DF14701.202710
SCALE:	1" = 10'
DATE:	10/22/2015
DRAWN BY:	PAUL WILLIAMS

LINVILLE P. & BILLY C. ELKIN
JO ANNE ELKIN PRITCHARD
424 N. GEORGE WASHINGTON HWY
CHESAPEAKE, VA 23323

WATERLILY ROAD
EMERGENCY SHORELINE STABILIZATION

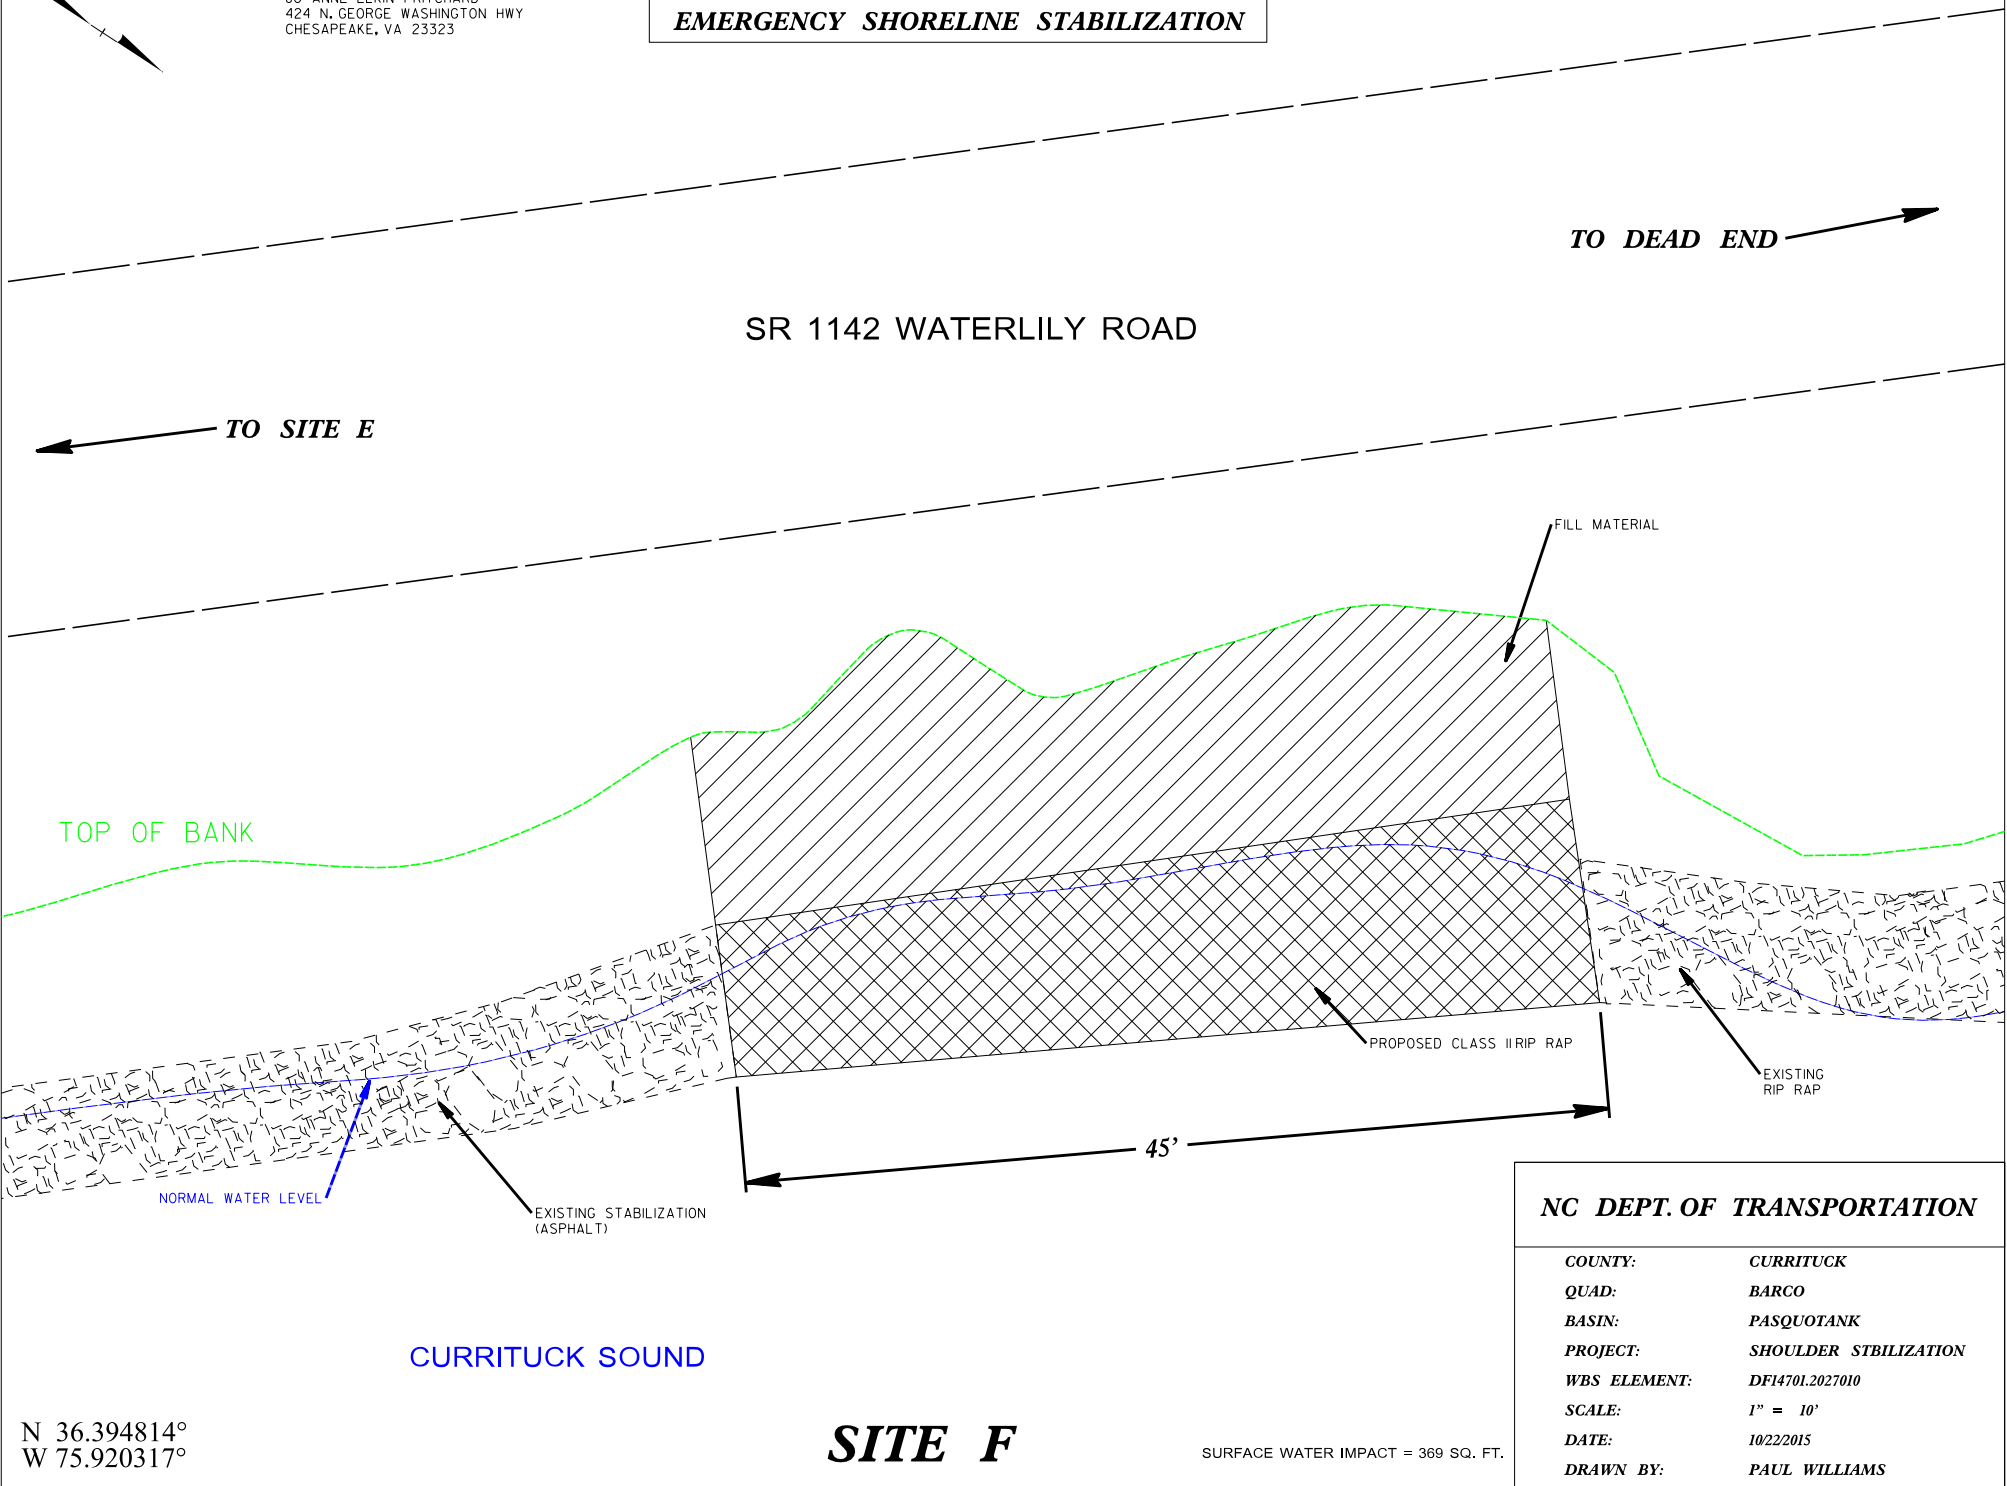

NC DEPT. OF TRANSPORTATION	
COUNTY:	CURRITUCK
QUAD:	BARCO
BASIN:	PASQUOTANK
PROJECT:	SHOULDER STABILIZATION
WBS ELEMENT:	DF14701.2027010
SCALE:	1" = 10'
DATE:	10/22/2015
DRAWN BY:	PAUL WILLIAMS


CURRITUCK SOUND

N 36.394814°
W 75.920317°

SITE F

SURFACE WATER IMPACT = 369 SQ. FT.

WATERLILY ROAD SHORELINE STABILIZATION ELEVATION VIEW - TYPICAL

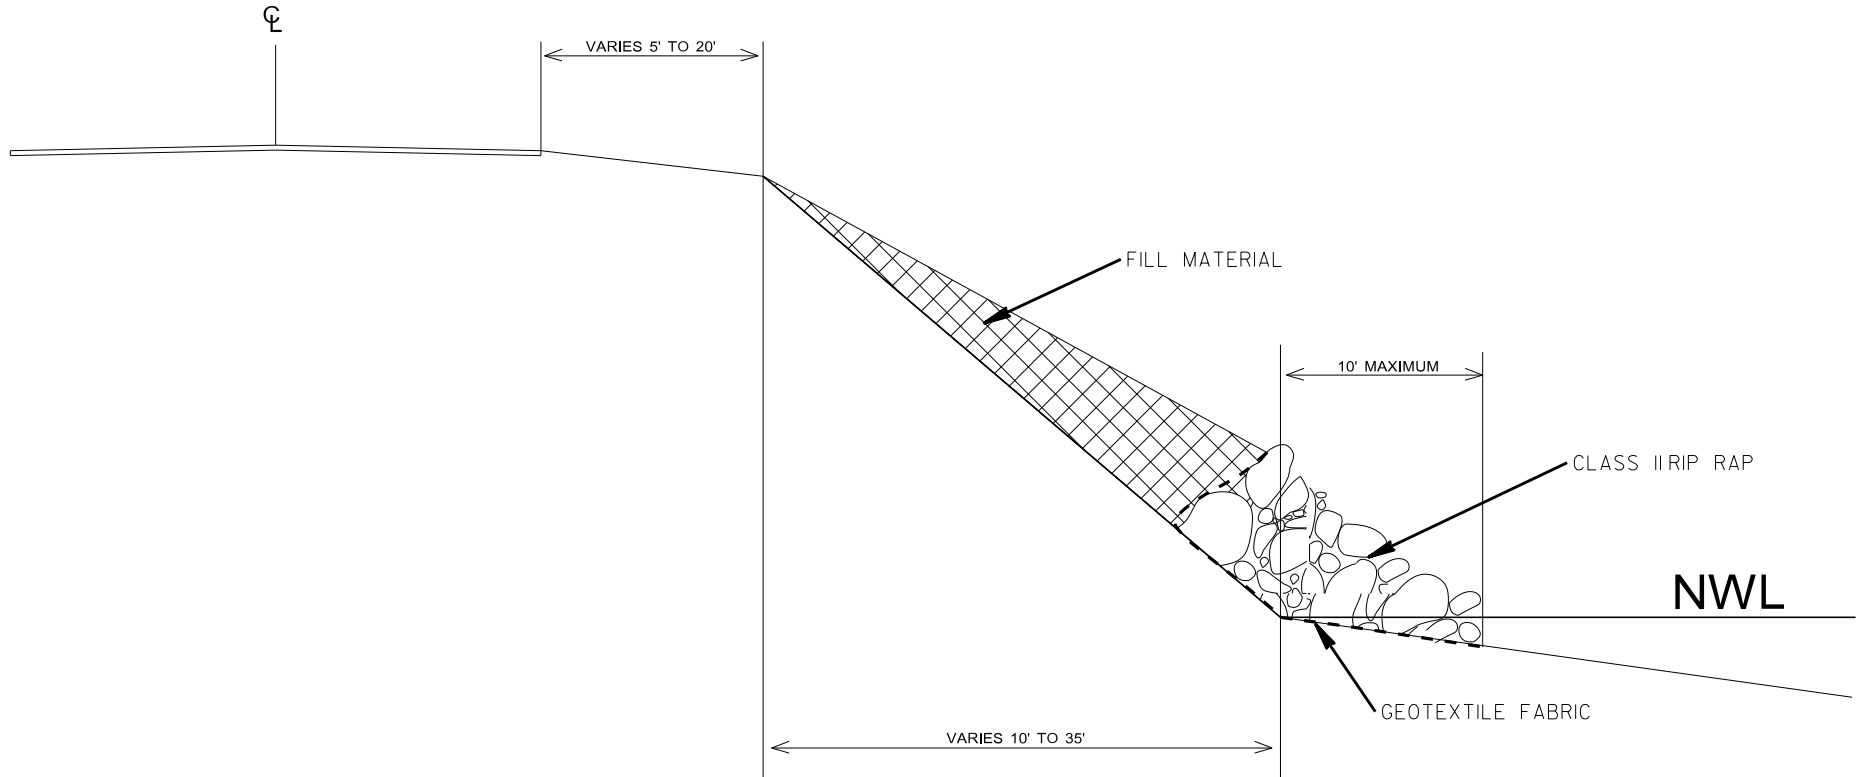

NC DEPT. OF TRANSPORTATION


COUNTY:	CURRITUCK
QUAD:	BARCO
BASIN:	PASQUOTANK
PROJECT:	SHOULDER STABILIZATION
WBS ELEMENT:	DF14701.2027010
SCALE:	1" = 10'
DATE:	10/22/2015
DRAWN BY:	PAUL WILLIAMS

PROJECT NO.	SHEET NO.	TOTAL NO.
DF14701.2027010	9	

SUMMARY OF QUANTITIES

PROJECT NO	COUNTY	MAP NO	ROUTE	DESCRIPTION	TYP NO	LANES	LANE TYPE	FINAL SURFACE TESTING REQUIRED	WARM MIX ASPHALT REQUIRED	LENGTH MI	WIDTH FT	MOBILIZATION LS	CLEARING & GRUBBING .. ACRE(S) LS	BORROW CY	GEOTEXTILE FOR SOIL STABILIZATION SY	GENERIC GRADING ITEM (SHOULDER & SLOPE RECONSTRUCTION) ACR	AC PLANT MIX (REPAIR) TON	MATTING FOR EROSION CONTROL SY	SEED & MULCHING ACR	REMOVAL OF EXISTING STRUCTURES (SITE D) LS	RIP RAP CLASS II (2'-0" THICK) TON	TRAFFIC CONTROL LS
DF14701.2027010	Currituck	1	SR 1142 WATERLILY ROAD	VARIOUS LOCATIONS	1	2	2WU	NO	NO	0.075	20	1	1	2,900	1,300	1	50	4,840	1	1	1,600	1
GRAND TOTAL										0.075		1	1	2,900	1,300	1	50	4,840	1	1	1,600	1

SIGNING FOR RESURFACING PROJECTS

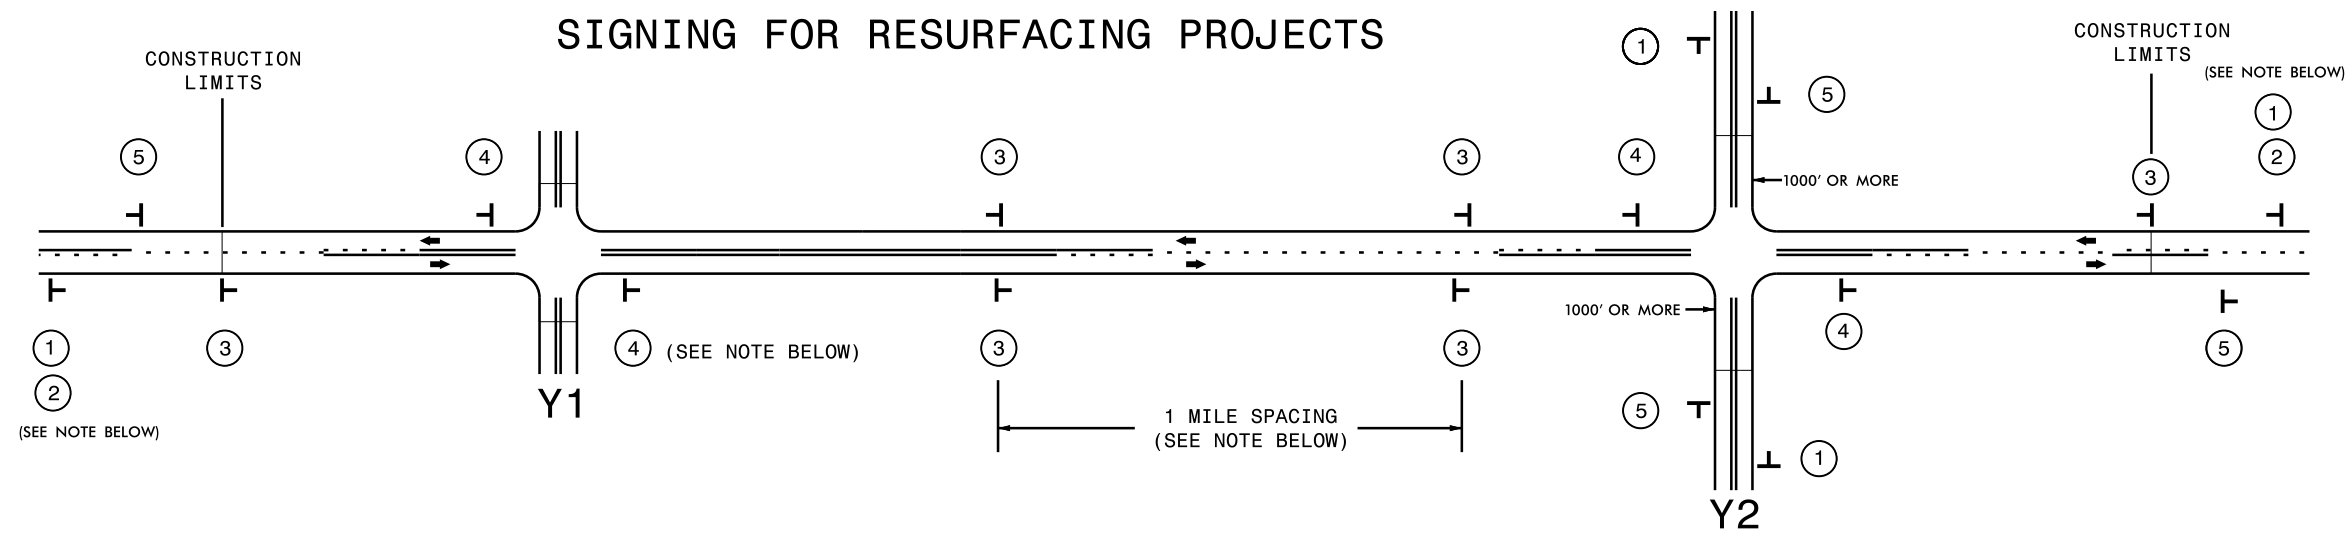


LEGEND	
T	STATIONARY SIGN
←	DIRECTION OF TRAFFIC FLOW

MAINLINE (-L-) SIGNING

-Y- LINE SIGNING

SIGNING NOTES AND PLACEMENT PER DIRECTION		
1 2		<p>PLACE 1000' PRIOR TO BEGINNING OF CONSTRUCTION LIMITS. ONLY USED ON -Y- LINES IF RESURFACING LIMITS EXTEND 1000' ALONG -Y- LINE.</p> <p>#2 SIGN ONLY USED WHEN RESURFACING LIMITS ARE 2 OR MORE MILES IN LENGTH. ROUND UP TO NEXT WHOLE NUMBER. (NO FRACTIONAL OR DECIMAL NUMBERS)</p>
3		<p>PLACE INITIALLY AT THE CONSTRUCTION LIMITS AND SPACED 1 MILE APART THEREAFTER. IF NO -Y- LINES EXIST, PLACE 2ND SET 1/2 MILE FROM THE CONSTRUCTION LIMITS AND THEN SPACE 1 MILE THEREAFTER.</p>
4		<p>THESE ARE FOR -Y- LINES THAT ARE "THROUGH" ROADWAYS. DEAD END AND SUBDIVISION ROADS ARE NOT "THROUGH" ROADWAYS. INSTALL 500' +/- FROM EACH -Y- LINE APPROACH AS SHOWN ABOVE. FOR MULTIPLE -Y- LINES THAT ARE SEPARATED BY 0.25 MILES OR LESS, TREAT AS A SINGLE UNIT AND INSTALL WITHIN 500' OF EACH APPROACH. A MAXIMUM OF 2 SIGN SETS PER MILE. DO NOT INSTALL WHEN -Y- LINES ARE WITHIN 0.5 MILES FROM "END ROAD WORK" SIGN.</p>
5		<p>PLACE 500' FOLLOWING THE END OF CONSTRUCTION LIMITS.</p>
		<p>NO REQUIRED STATIONARY SIGNING FOR THE FOLLOWING -Y- LINE CONDITIONS:</p> <ol style="list-style-type: none"> 1) LESS THAN 1000' OF RESURFACING ALONG -Y- LINE 2) SUBDIVISION ROADS 3) DEAD END ROADS <p>WHEN PAVING/CONSTRUCTION ACTIVITIES PROCEED ACROSS AN UNSIGNED -Y- LINE, ADVANCE WARNING PORTABLE SIGNS SHALL BE USED ALONG THE -Y- LINE AS SHOWN BELOW. REMOVE UPON COMPLETION OF WORK.</p> <div style="display: flex; justify-content: space-around; align-items: center;"> </div> <p>PLACED 500' IN ADVANCE OF FLAGGER. PLACED 250' IN ADVANCE OF FLAGGER.</p>


09-FEB-2015 07:52
 O:\CAD\264931\Drawings\11\Resurfacing\Plans\Resurfacing_AdvWarn_2Ln.dgn
 dtgum AT 01/02/2026

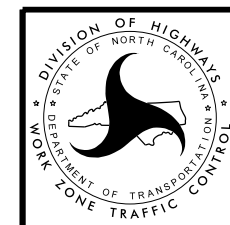

**RESURFACING
 ADVANCE WARNING SIGNS
 FOR
 RURAL AND SUBURBAN
 2 LANE ROADWAYS**


NOTES:

- 1) DETAIL DOES NOT APPLY TO OGAFB AND ULTRA-THIN BONDED WEARING COURSE.
- 2) BACKFILL SHOULDER WITH APPROVED MATERIAL.
- 3) THE SHOULDER WEDGE DEVICE MAY BE DISENGAGED AT PAVED DRIVEWAYS AND SIDE STREETS.

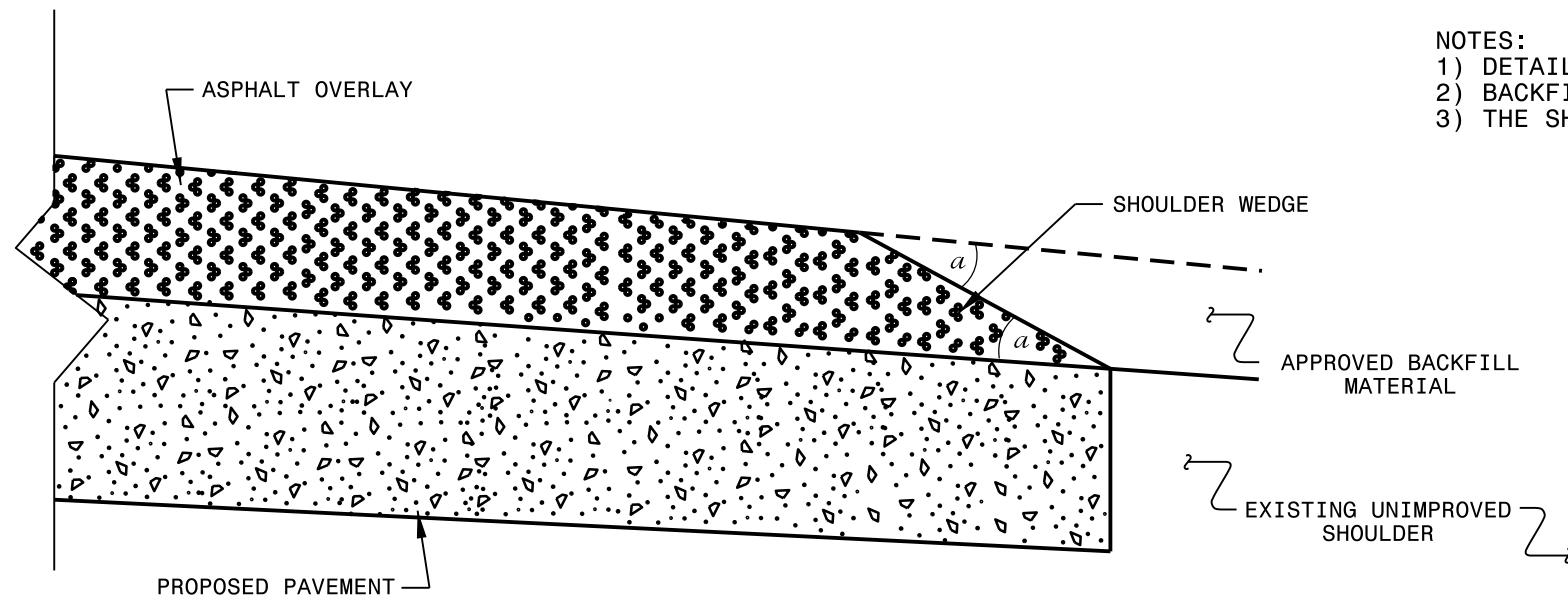


SHOULDER WEDGE DETAIL

(Resurfacing Projects w/ Widening or with Existing Paved Shoulder having no dropoffs)

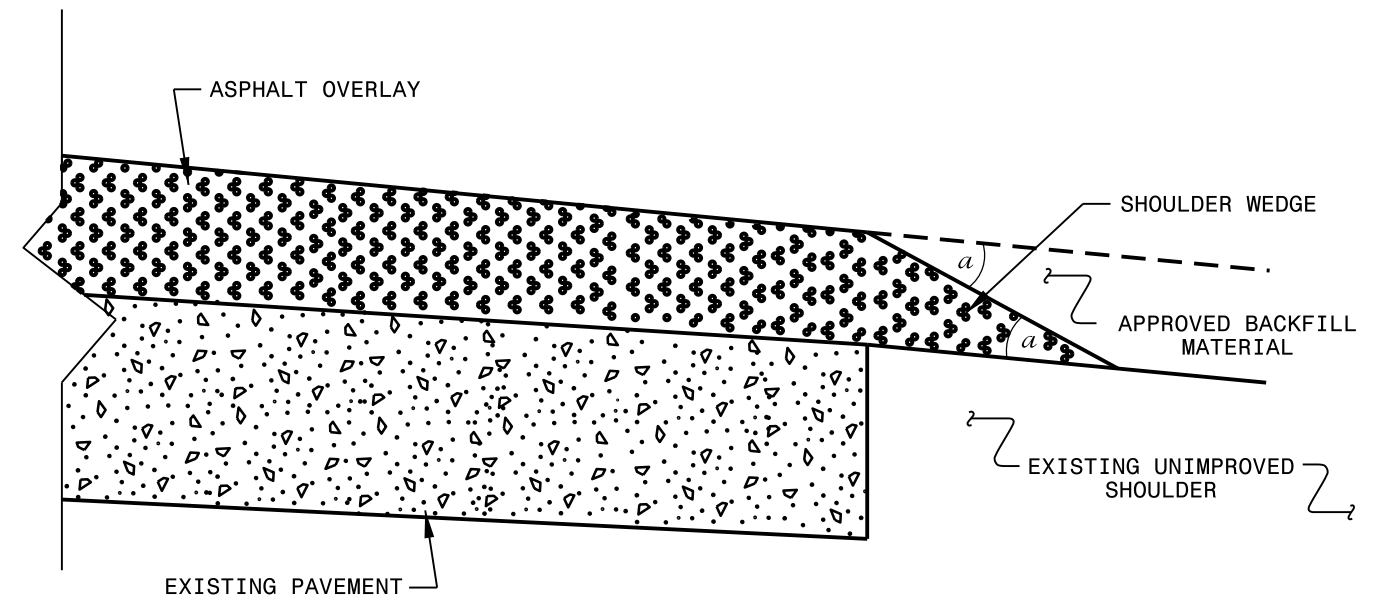

SHOULDER WEDGE DETAIL

(Resurfacing Projects w/ NO Widening)

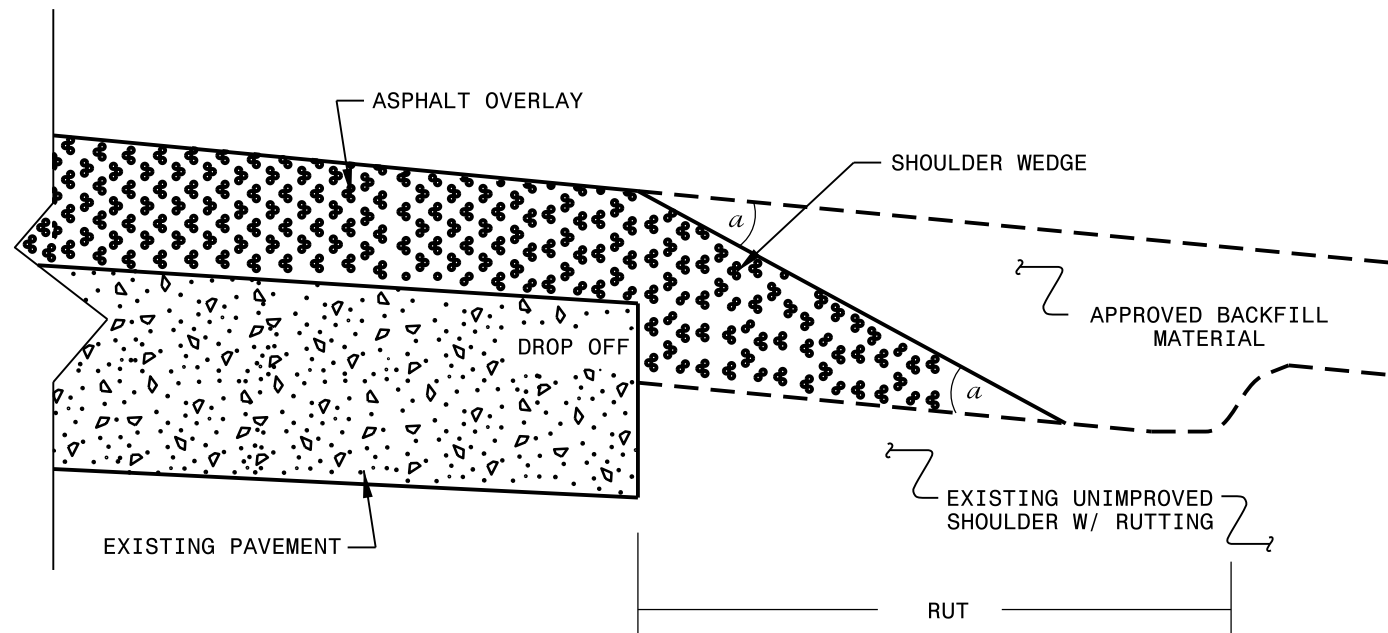

SHOULDER WEDGE DETAIL

(Resurfacing Adjacent to Rutted Shoulder)

- SHOULDER WEDGE ANGLE = 30°

CONTRACT STANDARDS AND DEVELOPMENT UNIT
Office 919-707-6950 FAX 919-250-4119

SHOULDER WEDGE DETAILS

ORIGINAL BY: T.SPELL DATE: 7-19-11
 MODIFIED BY: DATE: 10/16/12
 CHECKED BY: DATE:
 FILE SPEC.: s:\usr\details\stand\shoulderwedgedetail.dgn