


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09_05/24

See Sheet 1A For Index of Sheets
See Sheet 1B For Conventional Symbols



STATE OF NORTH CAROLINA
DIVISION OF HIGHWAYS

JOHNSTON COUNTY

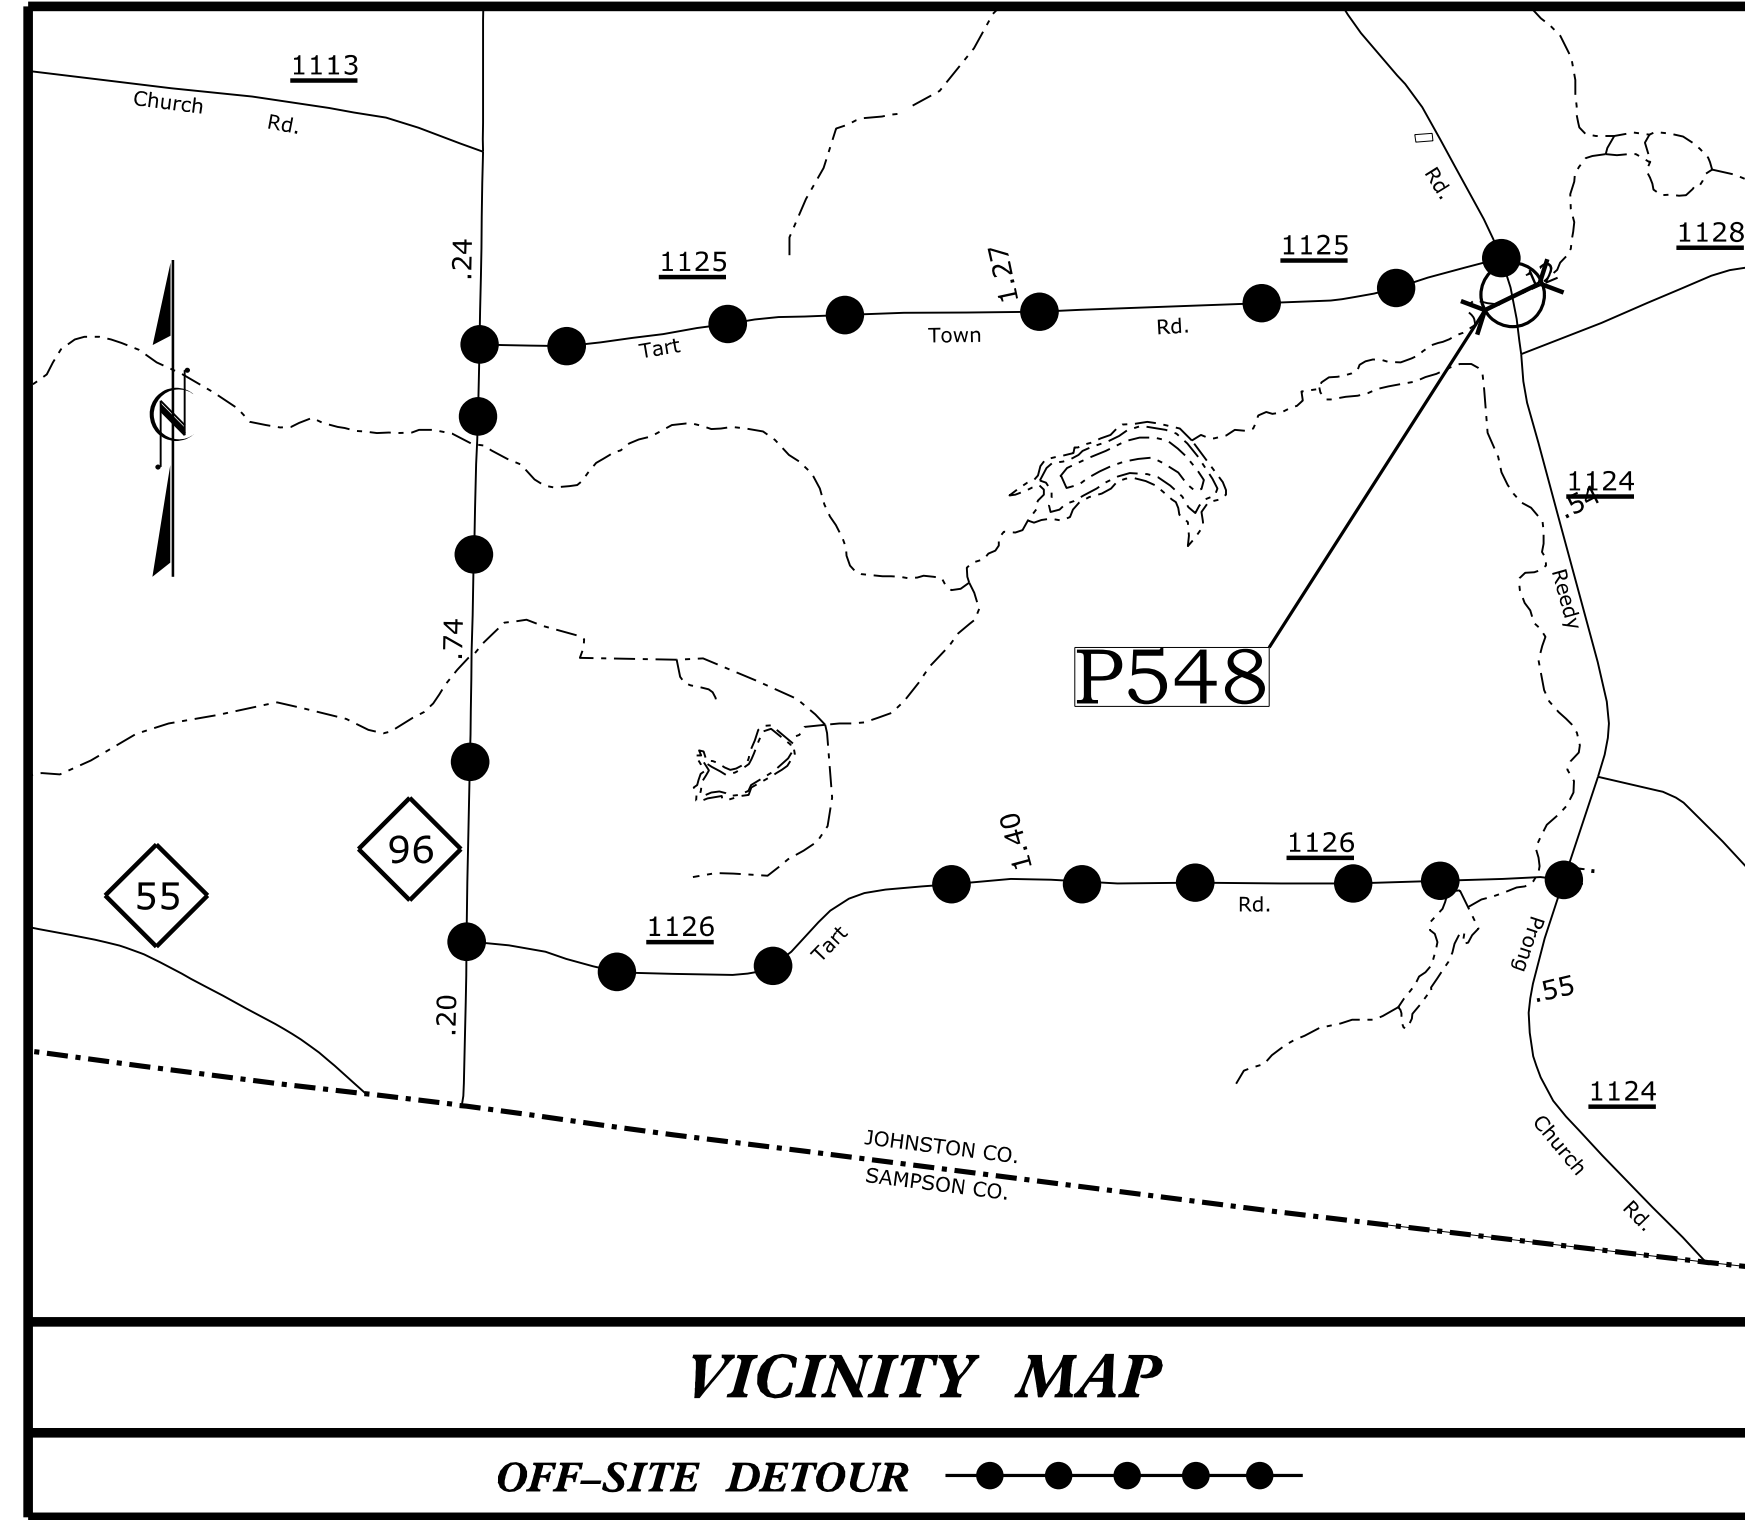**LOCATION: PIPE NO. 500548 OVER REEDY PRONG
ON SR 1124 (REEDY PRONG CHURCH RD.)**

TYPE OF WORK: GRADING, DRAINAGE, & PAVING

STATE	STATE PROJECT REFERENCE NO.	SHEET NO.	TOTAL SHEETS
N.C.	BP4.R028	1	
STATE PROJ. NO.	F.A. PROJ. NO.	DESCRIPTION	
BP4.R028.1		PE	
BP4.R028.2		ROW, UTIL.	
BP4.R028.3		CONST.	


WETHERILL ENGINEERING

1223 Jones Franklin Rd.
Raleigh, N.C. 27605
License No. F-0377
Bus: 919 851 8077
Fax: 919 851 8107

TRANSPORTATION PLANNING/DESIGN - BRIDGE/STRUCTURE DESIGN
CIVIL/SITE DESIGN - GIS/GPS - CONSTRUCTION OBSERVATION

PIPE NO. 500548


FINAL PLANS

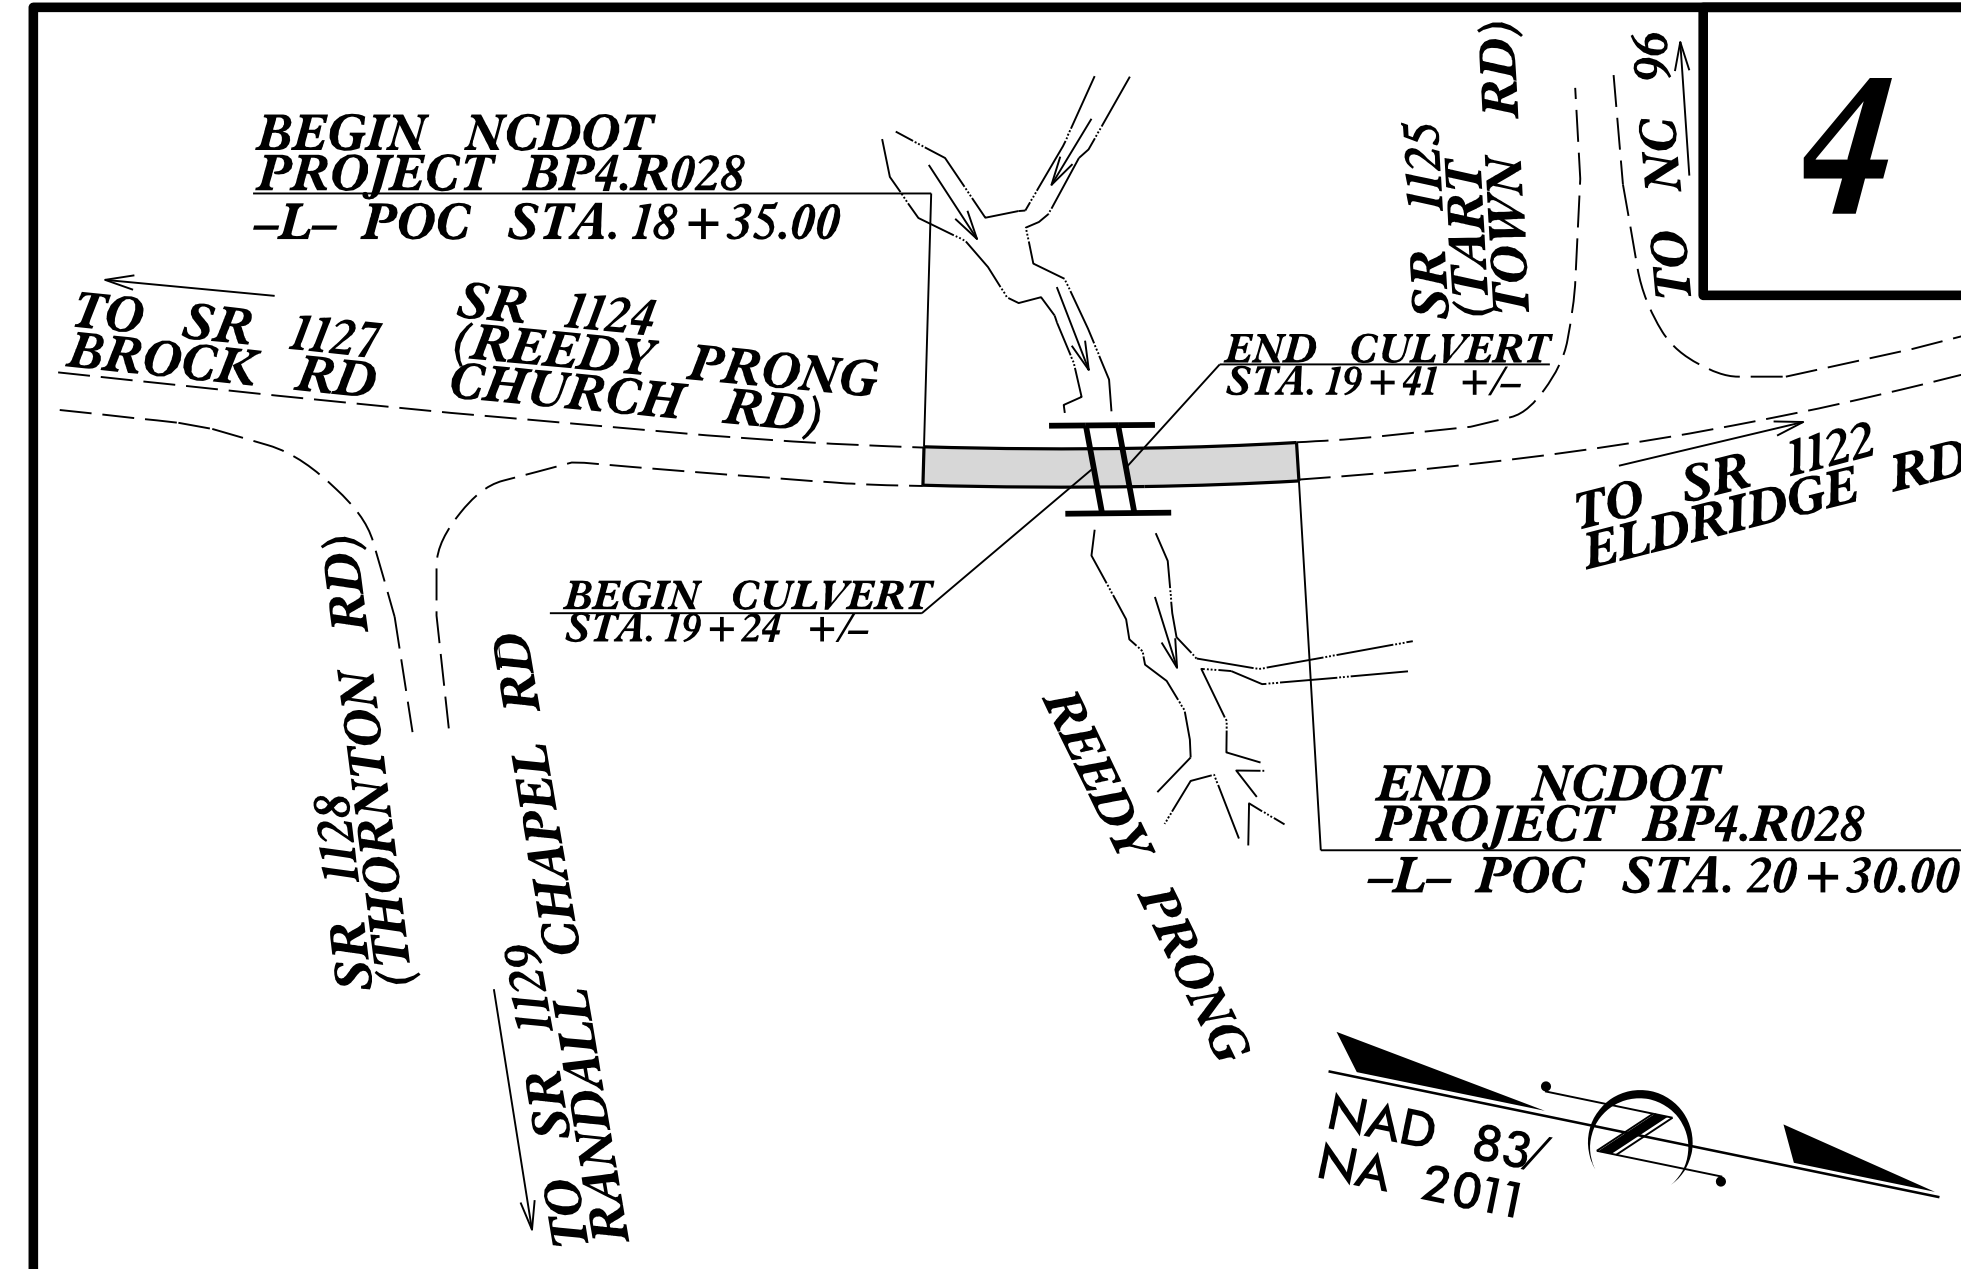

PROJECT: BP4.R028

CONTRACT: DD00449

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UNLESS ALL SIGNATURES COMPLETED

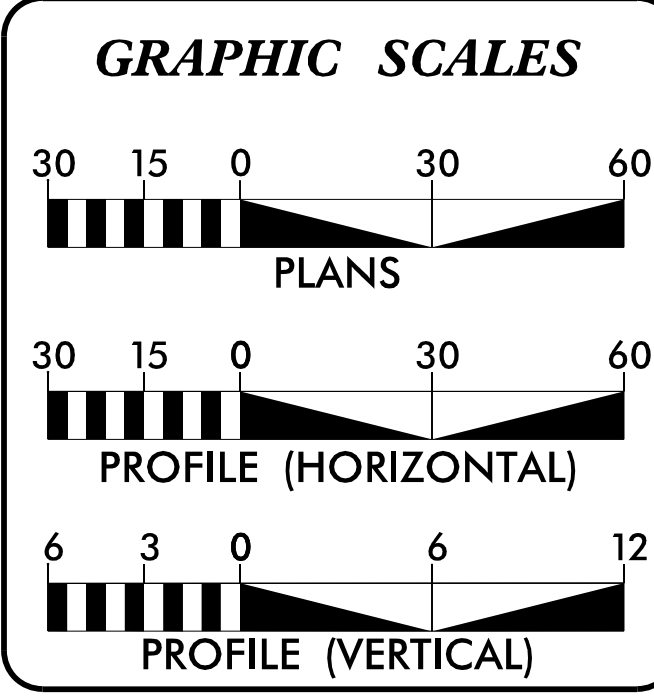

DESIGN DATA

ADT 2019 = 200

T = 6 % *

V = 55 MPH

* (TTST = 3% + DUAL = 3%)

FUNC CLASS = LOCAL

SUBREGIONAL TIER

PROJECT LENGTH

LENGTH ROADWAY PROJECT BP4.R028 =	0.037 MILES
TOTAL LENGTH PROJECT BP4.R028 =	0.037 MILES

NCDOT CONTACT: RACHEL C. EVANS, PE
DIVISION 4 PROJECT ENGINEER

Prepared for:
DIVISION OF HIGHWAYS
DIVISION FOUR
509 Ward Boulevard, Wilson NC, 27895

2024 STANDARD SPECIFICATIONS

RIGHT OF WAY DATE: MARCH 31, 2022

LETTING DATE: FEBRUARY 27, 2024

EDWARD G. WETHERILL, PE
PROJECT ENGINEER

GREG S. PURVIS, PE
PROJECT DESIGN ENGINEER

HYDRAULICS ENGINEER


SEAL 15833

Jerry L. Lindsey, P.E. 1/2/2024


ROADWAY DESIGN ENGINEER

SEAL 022999

Greg S. Purvis, P.E. 1/2/2024

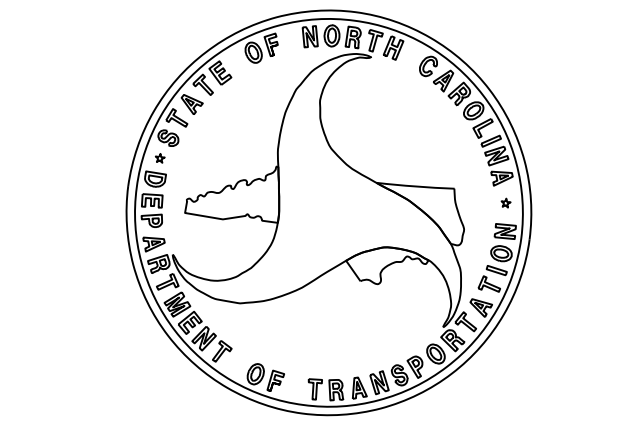

1/27/2024 1:27:00 PM I:\Projects\BP4.R028.RDY_TSH.Ltdgn USER:JKRosado

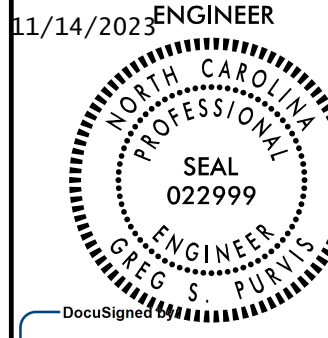PROJECT REFERENCE NO.	SHEET NO.
BP4.R028	1A
RW SHEET NO.	
ROADWAY DESIGN 11/14/2023 ENGINEER 	

GENERAL NOTES

2024 ROADWAY ENGLISH STANDARD DRAWINGS

GENERAL NOTES: 2024 SPECIFICATIONS
 EFFECTIVE: 01-16-2024
 REVISED:

EFF. 01-16-2024
 REV.

GRADING AND SURFACING OR RESURFACING AND WIDENING:

THE GRADE LINES SHOWN DENOTE THE FINISHED ELEVATION OF THE PROPOSED SURFACING AT GRADE POINTS SHOWN ON THE TYPICAL SECTIONS. WHERE NO GRADE LINES ARE SHOWN, THE PROFILES SHOWN DENOTE THE TOP ELEVATION OF THE EXISTING PAVEMENT ALONG THE CENTER LINE OF SURVEY ON WHICH THE PROPOSED RESURFACING WILL BE PLACED. GRADE LINES MAY BE ADJUSTED BY THE ENGINEER IN ORDER TO SECURE A PROPER TIE-IN.

CLEARING:

CLEARING ON THIS PROJECT SHALL BE PERFORMED TO THE LIMITS ESTABLISHED BY METHOD II.

SUPERELEVATION:

ALL CURVES ON THIS PROJECT SHALL BE SUPERELEVATED IN ACCORDANCE WITH STD. NO. 225.04 USING THE RATE OF SUPERELEVATION AND RUNOFF SHOWN ON THE PLANS. SUPERELEVATION IS TO BE REVOLVED ABOUT THE GRADE POINTS SHOWN ON THE TYPICAL SECTIONS.

SHOULDER CONSTRUCTION:

ASPHALT, EARTH, AND CONCRETE SHOULDER CONSTRUCTION ON THE HIGH SIDE OF SUPERELEVATED CURVES SHALL BE IN ACCORDANCE WITH STD. NO. 560.01

TEMPORARY SHORING:

SHORING REQUIRED FOR THE MAINTENANCE OF TRAFFIC WILL BE PAID FOR AS "EXTRA WORK" IN ACCORDANCE WITH SECTION 104-7.

SUBSURFACE PLANS:

NO SUBSURFACE PLANS ARE AVAILABLE ON THIS PROJECT. THE CONTRACTOR SHOULD MAKE HIS OWN INVESTIGATION AS TO THE SUBSURFACE CONDITIONS.

UTILITIES:

UTILITY OWNERS ON THIS PROJECT ARE
 CenturyLink (Telephone/Fiber Optic), Johnston County Public Utilities (Water/Sewer),
 South River Electrical Membership Corporation (Power), Piedmont Natural Gas (Gas)
 ANY RELOCATION OF EXISTING UTILITIES WILL BE ACCOMPLISHED BY OTHERS, EXCEPT AS SHOWN ON THE PLANS.

2024 ROADWAY ENGLISH STANDARD DRAWINGS

The following Roadway Standards as appear in "Roadway Standard Drawings" Contracts Standards and Development Unit - N. C. Department of Transportation - Raleigh, N. C., Dated January 16, 2024 are applicable to this project and by reference hereby are considered a part of these plans:

STD.NO.	TITLE
DIVISION 2 - EARTHWORK	
200.02	Method of Clearing - Method II
225.01	Guide for Grading Subgrade - Interstate and Freeway
225.04	Method of Obtaining Superelevation - Two Lane Pavement
DIVISION 3 - PIPE CULVERTS	
300.01	Method of Pipe Installation
DIVISION 5 - SUBGRADE, BASES AND SHOULDERS	
560.01	Method of Shoulder Construction - High Side of Superelevated Curve - Method I

INDEX OF SHEETS

SHEET NUMBER	SHEET
1	TITLE SHEET
1A	INDEX OF SHEETS, GENERAL NOTES, AND LIST OF STANDARD DRAWINGS
1B	CONVENTIONAL SYMBOLS
2A-1	TYPICAL SECTIONS, PAVEMENT SCHEDULE, & MISCELLANEOUS DETAILS
2D-1	DRAINAGE DETAILS
3B-1	EARTHWORK SUMMARY AND PAVEMENT REMOVAL SUMMARY
4	PLAN AND PROFILE SHEET
RW01 THRU RW04	RIGHT OF WAY SHEETS, SURVEY CONTROL SHEETS, PROPOSED ALIGNMENT CONTROL SHEET AND PROPOSED EASEMENT CONTROL SHEET
TMP-1 THRU TMP-4	TRANSPORTATION MANAGEMENT PLAN
PMP-1 THRU PMP-2	PAVEMENT MARKING PLAN
EC-1 THRU EC-6	EROSION CONTROL PLANS
X-1	CROSS SECTION SUMMARY SHEET
X-2 THRU X-4	CROSS SECTIONS

**DOCUMENT NOT CONSIDERED FINAL
 UNLESS ALL SIGNATURES COMPLETED**

STATE OF NORTH CAROLINA, DIVISION OF HIGHWAYS CONVENTIONAL PLAN SHEET SYMBOLS

Note: Not to Scale

BOUNDARIES AND PROPERTY:

State Line	-----
County Line	-----
Township Line	-----
City Line	-----
Reservation Line	-----
Property Line	-----
Existing Iron Pin (EIP)	○
Computed Property Corner	×
Existing Concrete Monument (ECM)	□
Parcel/Sequence Number	(23)
Existing Fence Line	-x-x-x-
Proposed Woven Wire Fence	○
Proposed Chain Link Fence	□
Proposed Barbed Wire Fence	◇
Existing Wetland Boundary	-WLB-
Proposed Wetland Boundary	-WLB-
Existing Endangered Animal Boundary	-EAB-
Existing Endangered Plant Boundary	-EPB-
Existing Historic Property Boundary	-HPB-
Known Contamination Area: Soil	-S-S-
Potential Contamination Area: Soil	-S-S-
Known Contamination Area: Water	-W-W-
Potential Contamination Area: Water	-W-W-
Contaminated Site: Known or Potential	☠ ?

BUILDINGS AND OTHER CULTURE:

Gas Pump Vent or U/G Tank Cap	○
Sign	○
Well	○
Small Mine	×
Foundation	□
Area Outline	□
Cemetery	□
Building	□
School	□
Church	□
Dam	□

HYDROLOGY:

Stream or Body of Water	-----
Hydro, Pool or Reservoir	-----
Jurisdictional Stream	-JS-
Buffer Zone 1	-BZ 1-
Buffer Zone 2	-BZ 2-
Flow Arrow	←
Disappearing Stream	→
Spring	○
Wetland	↓
Proposed Lateral, Tail, Head Ditch	→
False Sump	▽

RAILROADS:

Standard Gauge	-----
RR Signal Milepost	○
Switch	□
RR Abandoned	-----
RR Dismantled	-----

RIGHT OF WAY & PROJECT CONTROL:

Primary Horiz Control Point	○
Primary Horiz and Vert Control Point	●
Secondary Horiz and Vert Control Point	◆
Vertical Benchmark	⊕
Existing Right of Way Monument	△
Proposed Right of Way Monument (Rebar and Cap)	▲
Proposed Right of Way Monument (Concrete)	⊙
Existing Permanent Easement Monument	◇
Proposed Permanent Easement Monument (Rebar and Cap)	◆
Existing C/A Monument	△
Proposed C/A Monument (Rebar and Cap)	▲
Proposed C/A Monument (Concrete)	⊙
Existing Right of Way Line	-----
Proposed Right of Way Line	-----
Existing Control of Access Line	-----
Proposed Control of Access Line	-----
Proposed ROW and CA Line	-----
Existing Easement Line	-----
Proposed Temporary Construction Easement	-----
Proposed Temporary Drainage Easement	-----
Proposed Permanent Drainage Easement	-----
Proposed Permanent Drainage/Utility Easement	-----
Proposed Permanent Utility Easement	-----
Proposed Temporary Utility Easement	-----
Proposed Aerial Utility Easement	-----

ROADS AND RELATED FEATURES:

Existing Edge of Pavement	-----
Existing Curb	-----
Proposed Slope Stakes Cut	-C-
Proposed Slope Stakes Fill	-F-
Proposed Curb Ramp	○
Existing Metal Guardrail	-----
Proposed Guardrail	-----
Existing Cable Guiderail	-----
Proposed Cable Guiderail	-----
Equality Symbol	⊕
Pavement Removal	⊗
VEGETATION:	
Single Tree	○
Single Shrub	○
Hedge	-----

Woods Line	-----
Orchard	-----
Vineyard	-----

EXISTING STRUCTURES:

MAJOR:	
Bridge, Tunnel or Box Culvert	-----
Bridge Wing Wall, Head Wall and End Wall	-----
MINOR:	
Head and End Wall	-----
Pipe Culvert	-----
Footbridge	-----
Drainage Box: Catch Basin, DI or JB	-----
Paved Ditch Gutter	-----
Storm Sewer Manhole	○
Storm Sewer	-----

UTILITIES:

* SUE - Subsurface Utility Engineering
LOS - Level of Service - A,B,C or D (Accuracy)

POWER:	
Existing Power Pole	●
Proposed Power Pole	○
Existing Joint Use Pole	●
Proposed Joint Use Pole	○
Power Manhole	⊙
Power Line Tower	⊗
Power Transformer	⊗
U/G Power Cable Hand Hole	⊕
H-Frame Pole	●
U/G Power Line Test Hole (SUE - LOS A)*	⊕
U/G Power Line (SUE - LOS B)*	-----
U/G Power Line (SUE - LOS C)*	-----
U/G Power Line (SUE - LOS D)*	-----

TELEPHONE:

Existing Telephone Pole	●
Proposed Telephone Pole	○
Telephone Manhole	⊙
Telephone Pedestal	⊕
Telephone Cell Tower	⊕
U/G Telephone Cable Hand Hole	⊕
U/G Telephone Test Hole (SUE - LOS A)*	⊕
U/G Telephone Cable (SUE - LOS B)*	-----
U/G Telephone Cable (SUE - LOS C)*	-----
U/G Telephone Cable (SUE - LOS D)*	-----
U/G Telephone Conduit (SUE - LOS B)*	-----
U/G Telephone Conduit (SUE - LOS C)*	-----
U/G Telephone Conduit (SUE - LOS D)*	-----
U/G Fiber Optics Cable (SUE - LOS B)*	-----
U/G Fiber Optics Cable (SUE - LOS C)*	-----
U/G Fiber Optics Cable (SUE - LOS D)*	-----

WATER:

Water Manhole	⊕
Water Meter	○
Water Valve	⊗
Water Hydrant	⊕
U/G Water Line Test Hole (SUE - LOS A)*	⊕
U/G Water Line (SUE - LOS B)*	-----
U/G Water Line (SUE - LOS C)*	-----
U/G Water Line (SUE - LOS D)*	-----
Above Ground Water Line	-----

TV:

TV Pedestal	⊕
TV Tower	⊗
U/G TV Cable Hand Hole	⊕
U/G TV Test Hole (SUE - LOS A)*	⊕
U/G TV Cable (SUE - LOS B)*	-----
U/G TV Cable (SUE - LOS C)*	-----
U/G TV Cable (SUE - LOS D)*	-----
U/G Fiber Optic Cable (SUE - LOS B)*	-----
U/G Fiber Optic Cable (SUE - LOS C)*	-----
U/G Fiber Optic Cable (SUE - LOS D)*	-----

GAS:

Gas Valve	◇
Gas Meter	⊕
U/G Gas Line Test Hole (SUE - LOS A)*	⊕
U/G Gas Line (SUE - LOS B)*	-----
U/G Gas Line (SUE - LOS C)*	-----
U/G Gas Line (SUE - LOS D)*	-----
Above Ground Gas Line	-----

SANITARY SEWER:


Sanitary Sewer Manhole	⊕
Sanitary Sewer Cleanout	⊕
U/G Sanitary Sewer Line	-----
Above Ground Sanitary Sewer	-----
SS Force Main Line Test Hole (SUE - LOS A)*	⊕
SS Force Main Line (SUE - LOS B)*	-----
SS Force Main Line (SUE - LOS C)*	-----
SS Force Main Line (SUE - LOS D)*	-----

MISCELLANEOUS:

Utility Pole	●
Utility Pole with Base	□
Utility Located Object	○
Utility Traffic Signal Box	⊕
Utility Unknown U/G Line (SUE - LOS B)*	-----
U/G Tank; Water, Gas, Oil	□
Underground Storage Tank, Approx. Loc.	⊕
A/G Tank; Water, Gas, Oil	□
Geoenvironmental Boring	⊕
Abandoned According to Utility Records	AATUR
End of Information	E.O.I.


PAVEMENT SCHEDULE	
C1	PROP. APPROX. 2½" ASPHALT CONCRETE SURFACE COURSE, TYPE S9.5B, AT AN AVERAGE RATE OF 137.5 LBS. PER SQ. YD. IN EACH OF TWO LAYERS.
C2	PROP. VAR. DEPTH ASPHALT CONCRETE SURFACE COURSE, TYPE S9.5B, AT AN AVERAGE RATE OF 110 LBS. PER SQ. YD. PER 1" DEPTH. TO BE PLACED IN LAYERS NOT TO EXCEED 1½" IN DEPTH.
E1	PROP. APPROX. 4" ASPHALT CONCRETE BASE COURSE, TYPE B25.0C, AT AN AVERAGE RATE OF 456 LBS. PER SQ. YD.
E2	PROP. VAR. DEPTH ASPHALT CONCRETE BASE COURSE, TYPE B25.0C, AT AN AVERAGE RATE OF 114 LBS. PER SQ. YD. PER 1" DEPTH. TO BE PLACED IN LAYERS NOT LESS THAN 3" IN DEPTH OR GREATER THAN 5½" IN DEPTH.
T	EARTH MATERIAL.
U	EXISTING PAVEMENT.
V	MILLING BITUMINOUS PAVEMENT. (SEE MILLING DETAIL)
W	VARIABLE DEPTH ASPHALT PAVEMENT (SEE WEDGING DETAIL)

NOTE: PAVEMENT EDGE SLOPES ARE 1:1 UNLESS SHOWN OTHERWISE.

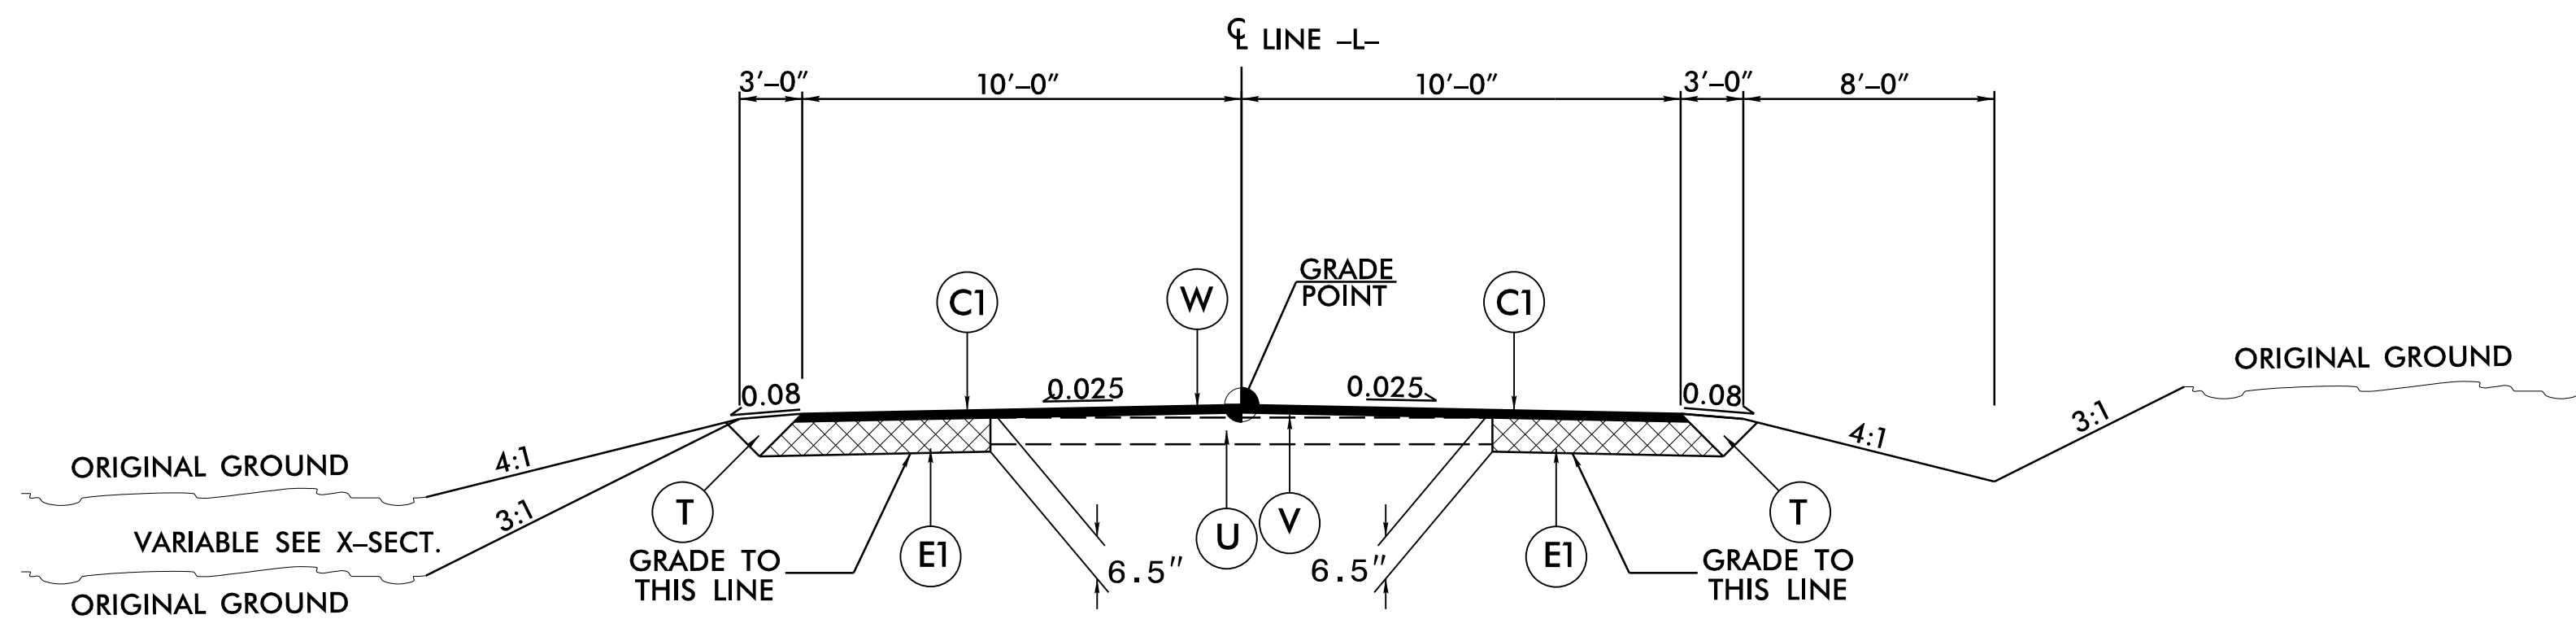


TYPICAL SECTION NO. 1

USE TYPICAL SECTION NO. 1 AS FOLLOWS:
 -L- STA. 18+35.00 TO -L- STA. 18+90.00
 -L- STA. 19+71.00 TO -L- STA. 20+30.00

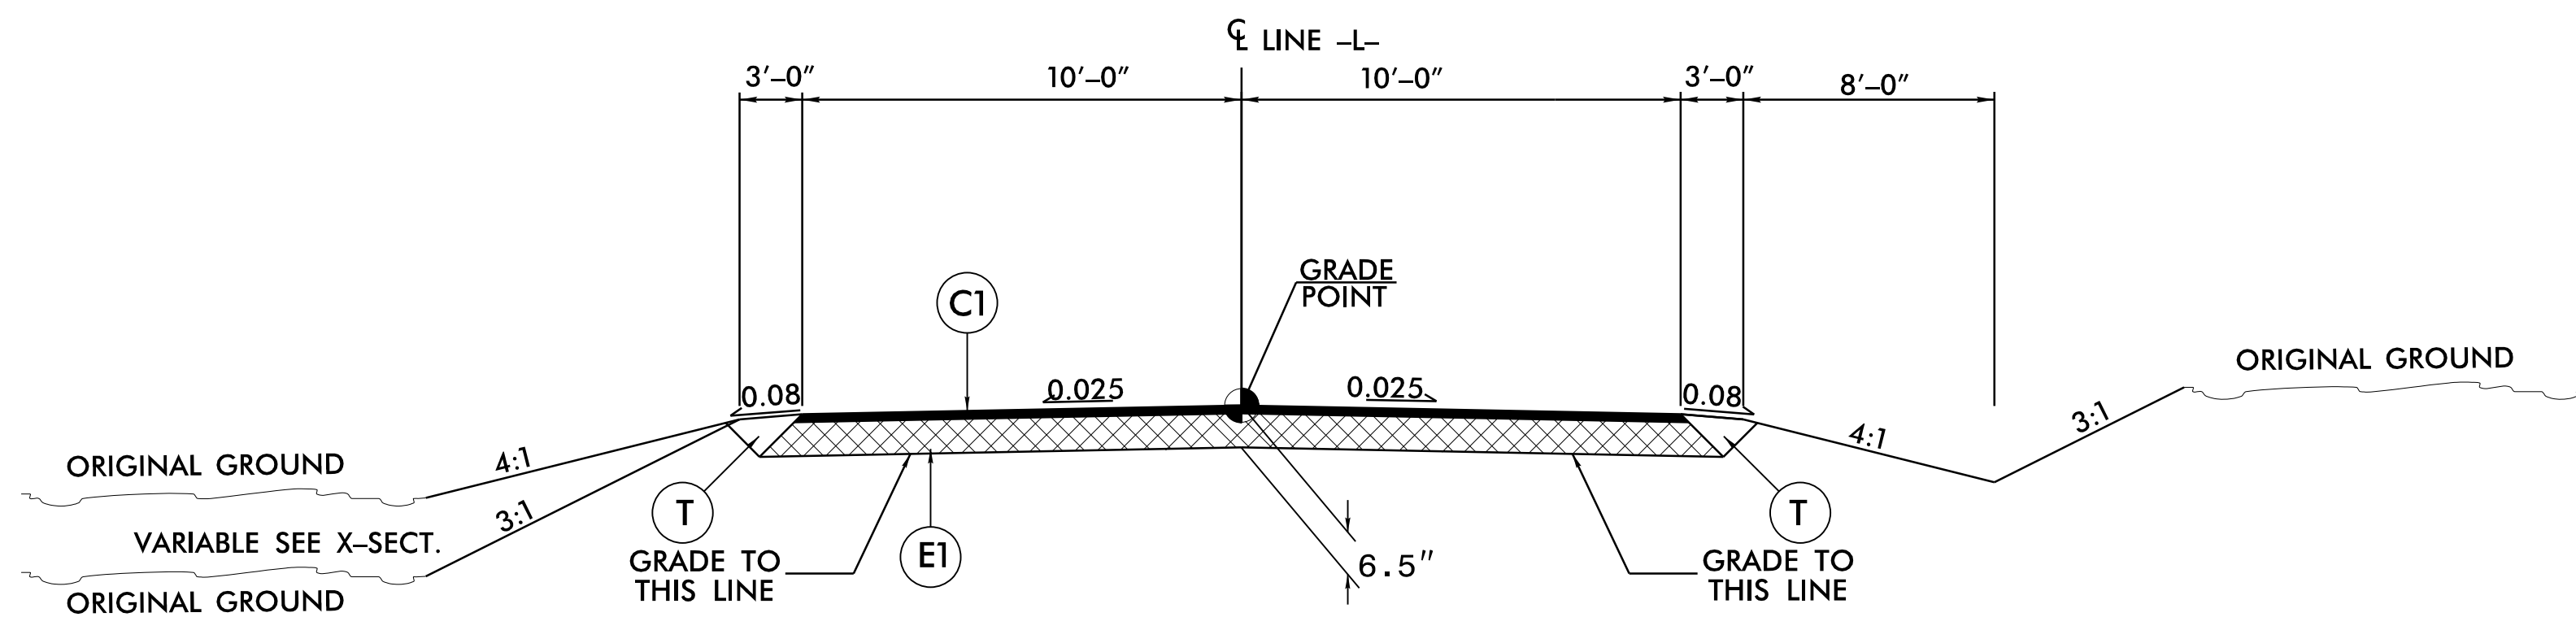


TYPICAL SECTION NO. 2

USE TYPICAL SECTION NO. 2 AS FOLLOWS:
 -L- STA. 18+90.00 TO -L- STA. 19+71.00

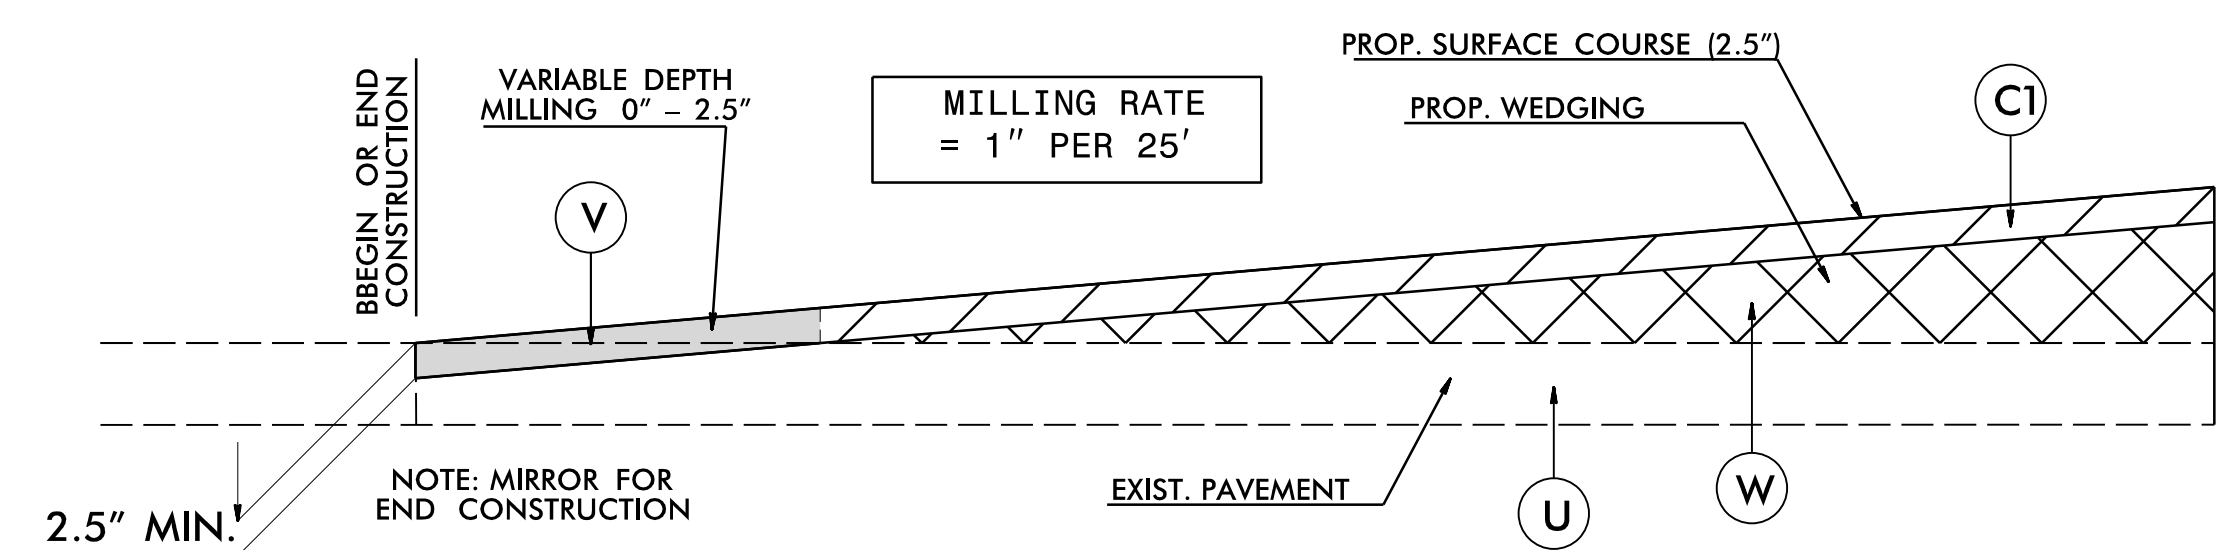

INCIDENTAL MILLING DETAIL

-L- STA. 18+35.00 TO -L- STA. 18+90.00
 -L- STA. 19+71.00 TO -L- STA. 20+30.00

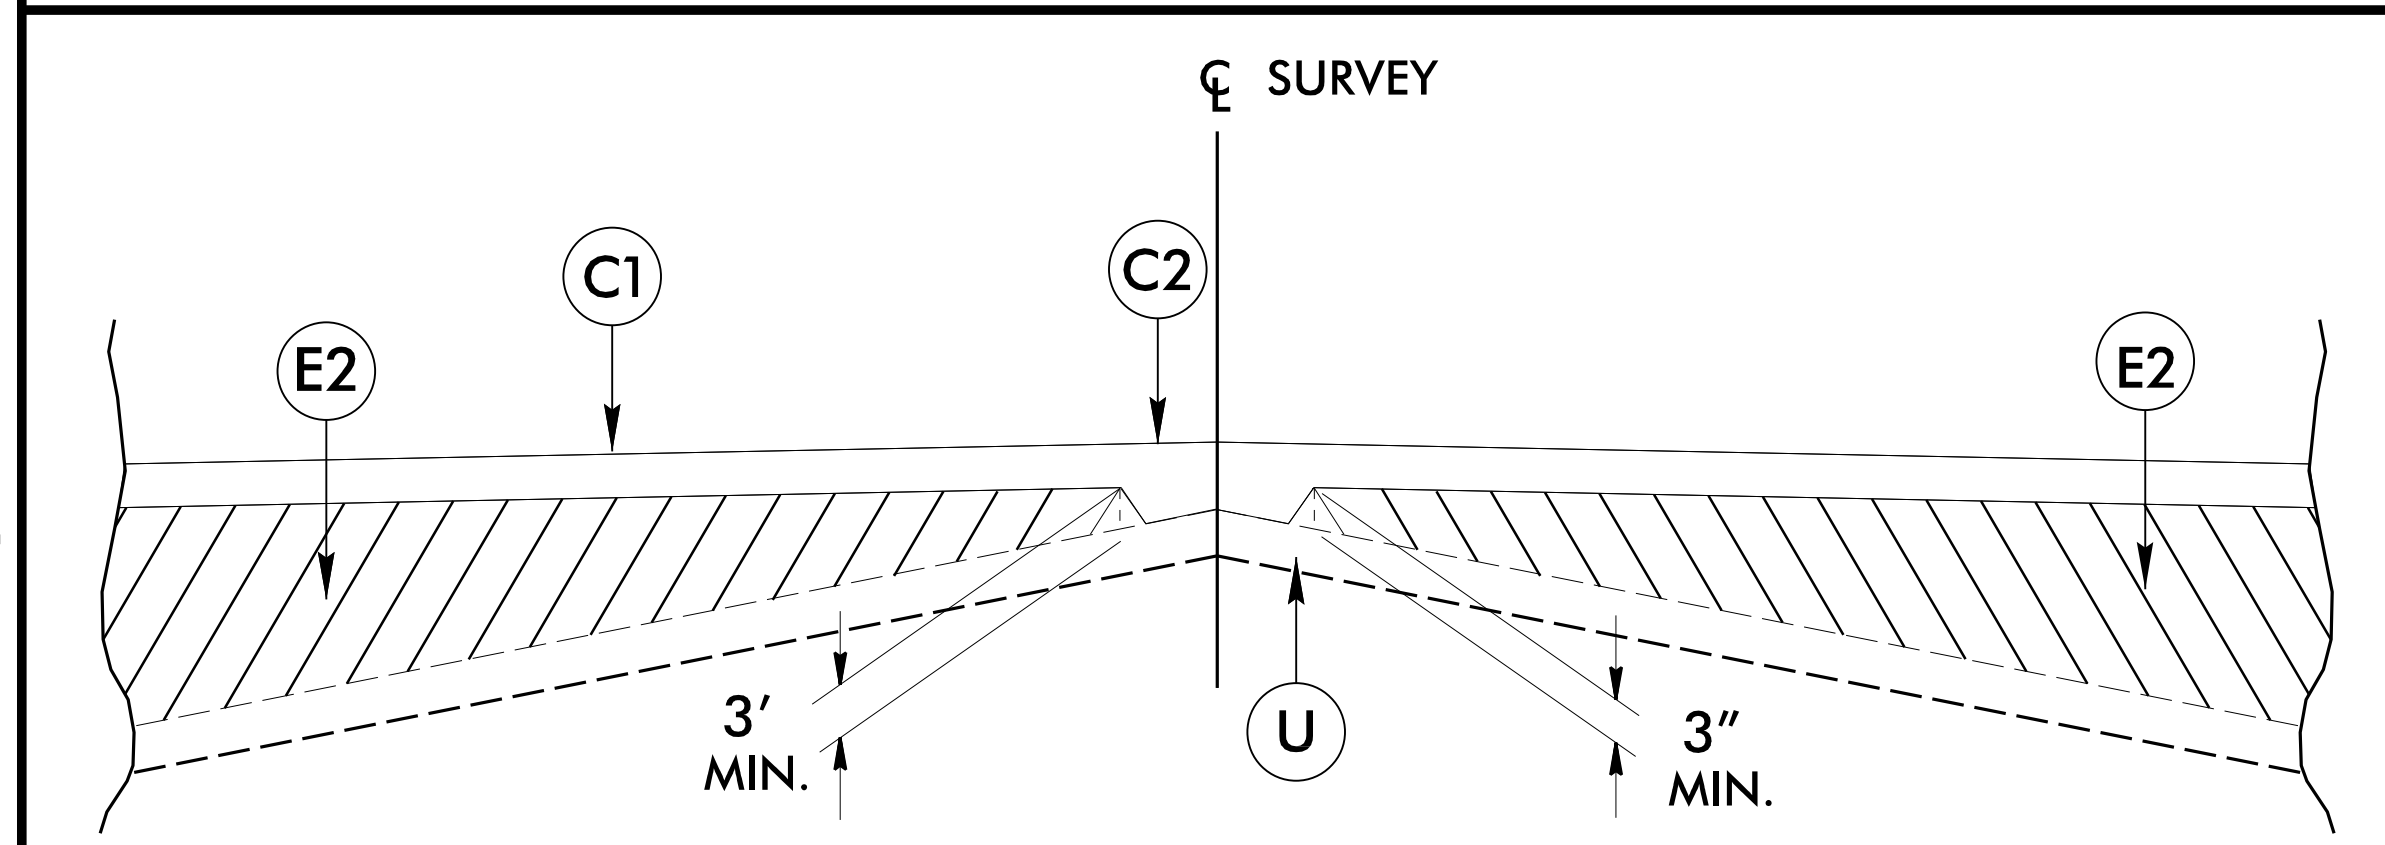

W: Detail Showing Method of Wedging

PROJECT REFERENCE NO. BP4.R028	SHEET NO. 2A-1
ROADWAY DESIGN ENGINEER 11/14/2023 	PAVEMENT DESIGN ENGINEER 11/14/2023
 TRANSPORTATION PLANNING/DESIGN - BRIDGE/STRUCTURE DESIGN CIVIL/SITE DESIGN - GIS/GPS - CONSTRUCTION OBSERVATION 1223 Jones Franklin Rd. Raleigh, N.C. 27606 License No. F-0377 Bus: 919 851 8077 Fax: 919 851 8107	
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11/14/2023 11:56:11 AM BP4.R028.RDY_TYP_2A-1.dgn

12/06/07


COMPUTED BY: JAR	DATE: 11/04/2022
CHECKED BY: GSP	DATE: 11/11/2022

STATE OF NORTH CAROLINA
DIVISION OF HIGHWAYS

PIPE #500548

PROJECT REFERENCE NO. <i>BP4.R028</i>	SHEET NO. <i>3B-1</i>
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TRANSPORTATION PLANNING/DESIGN - BRIDGE/STRUCTURE DESIGN
CIVIL/SITE DESIGN - GIS/GPS - CONSTRUCTION OBSERVATION

SUMMARY OF EARTHWORK



STATION	STATION	UNCL. EXCAV.	EMBANK. + %	BORROW	WASTE
-L- STA. 18+35.00	-L- STA. 20+30.00	35	250	215	
SUBTOTALS:		35	250	215	
PROJECT SUBTOTALS:		35	250	215	
LOSS DUE TO CLEARING & GRUBBING				11	
GRAND TOTALS:		35	250	225	
SAY:		75		250	

Note: Approximate quantities only.

PAVEMENT REMOVAL SUMMARY

SURVEY LINE	STATION	STATION	LOCATION LT/RT/CL	YD ²
-L-	18+90	19+71	CL	165.19
TOTAL:				165.19
SAY:				170




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1223 Jones Franklin Rd.
Raleigh, N.C. 27606
License No. F-6377
Bus: 919 851 8077
Fax: 919 851 8107

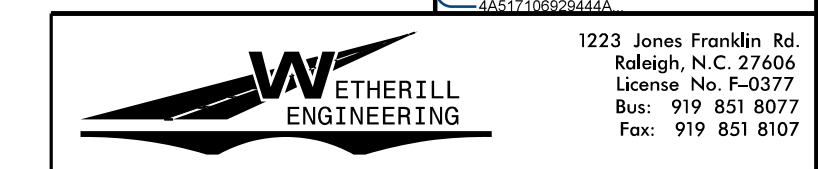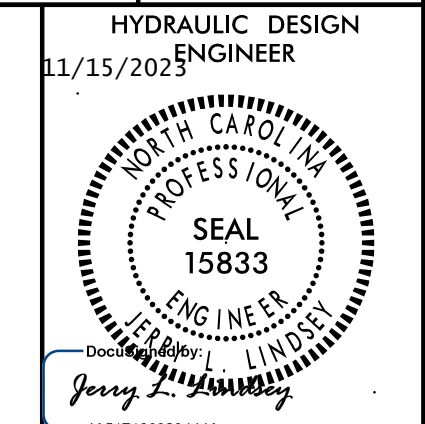TRANSPORTATION PLANNING/DESIGN - BRIDGE/STRUCTURE DESIGN
CIVIL/SITE DESIGN - GIS/GPS - CONSTRUCTION OBSERVATION

CULVERT DETAILS





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CULVERT HEADWALL DETAILS

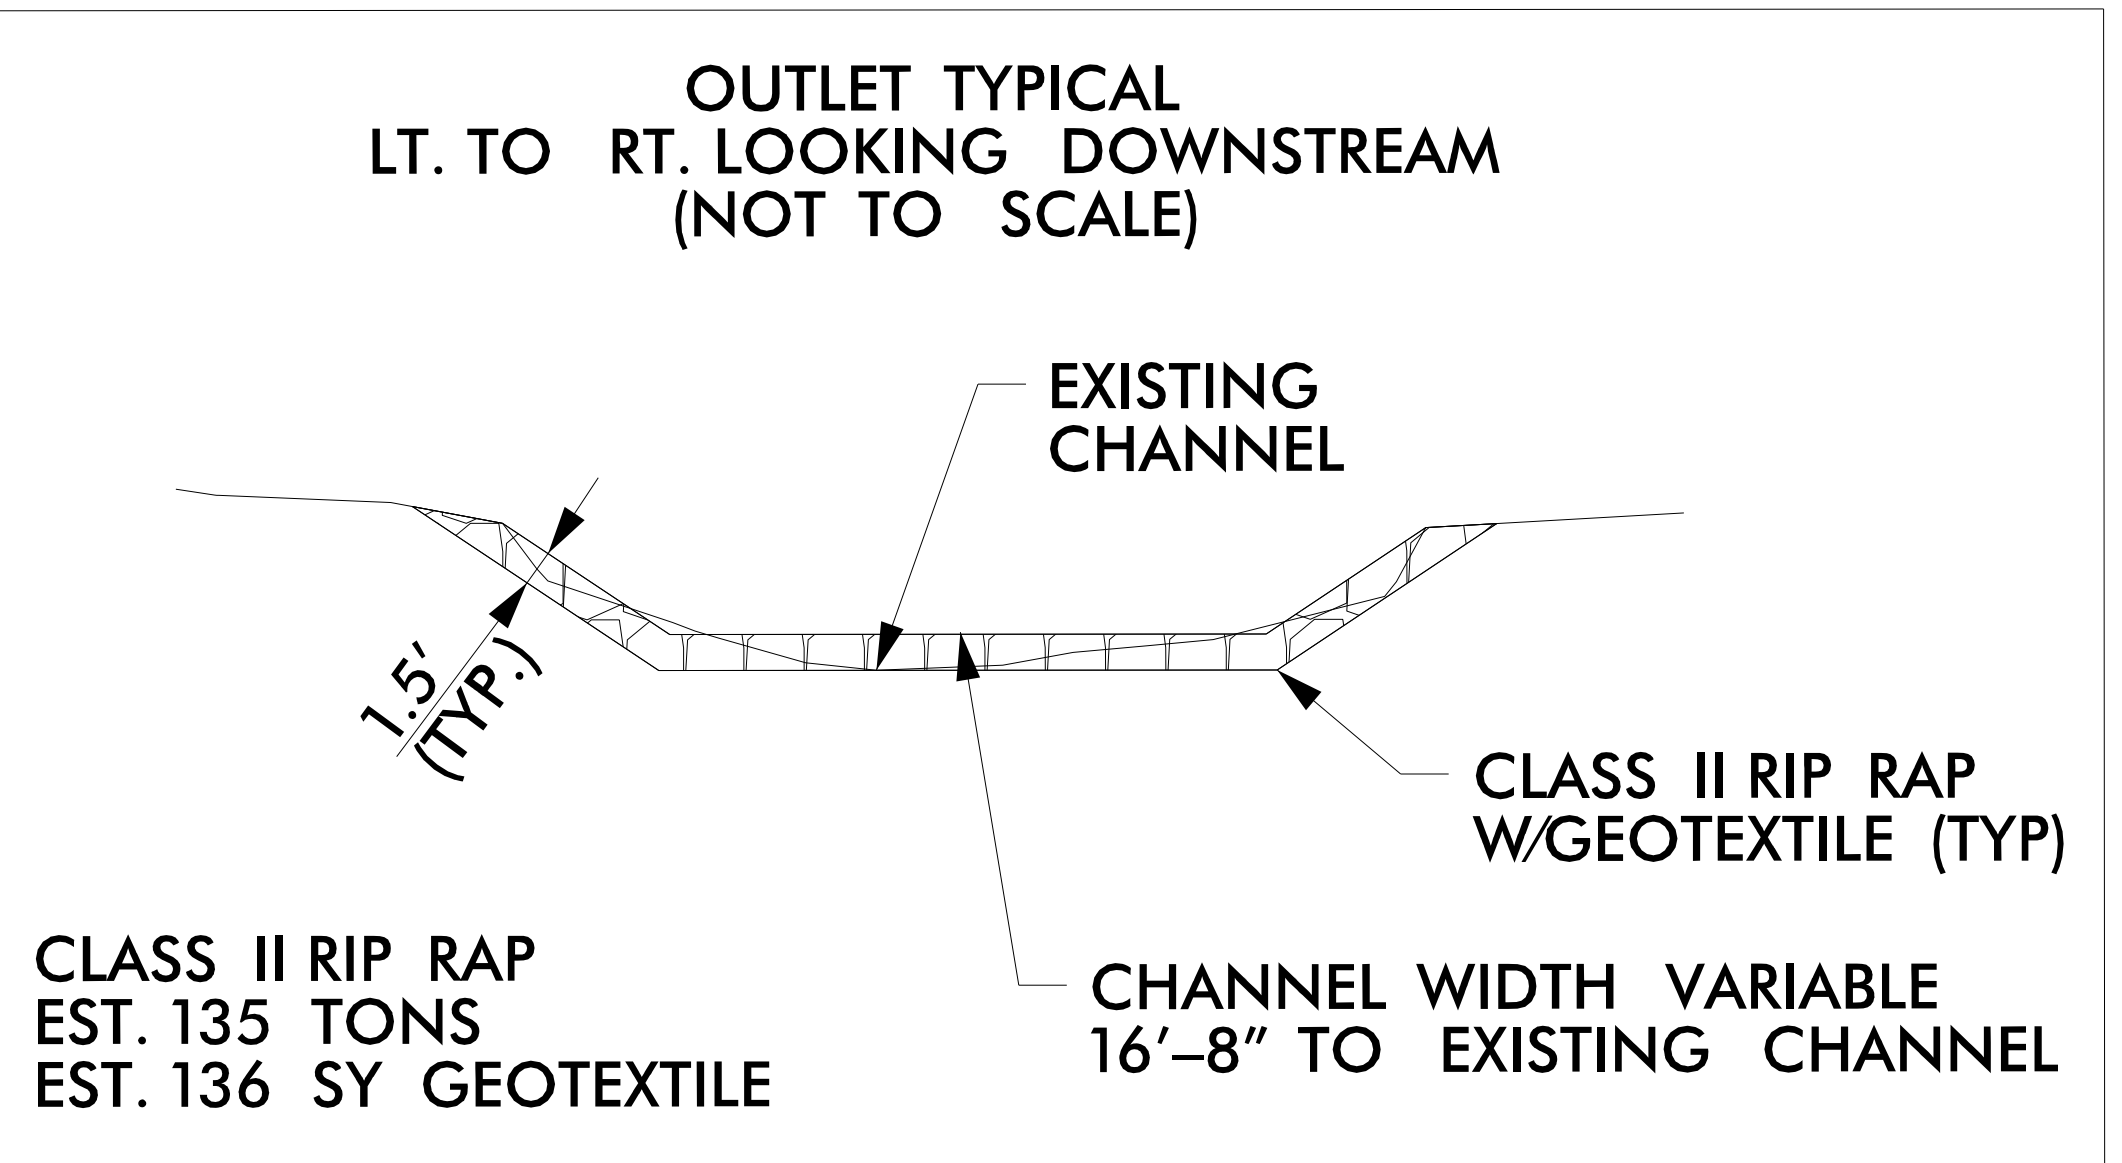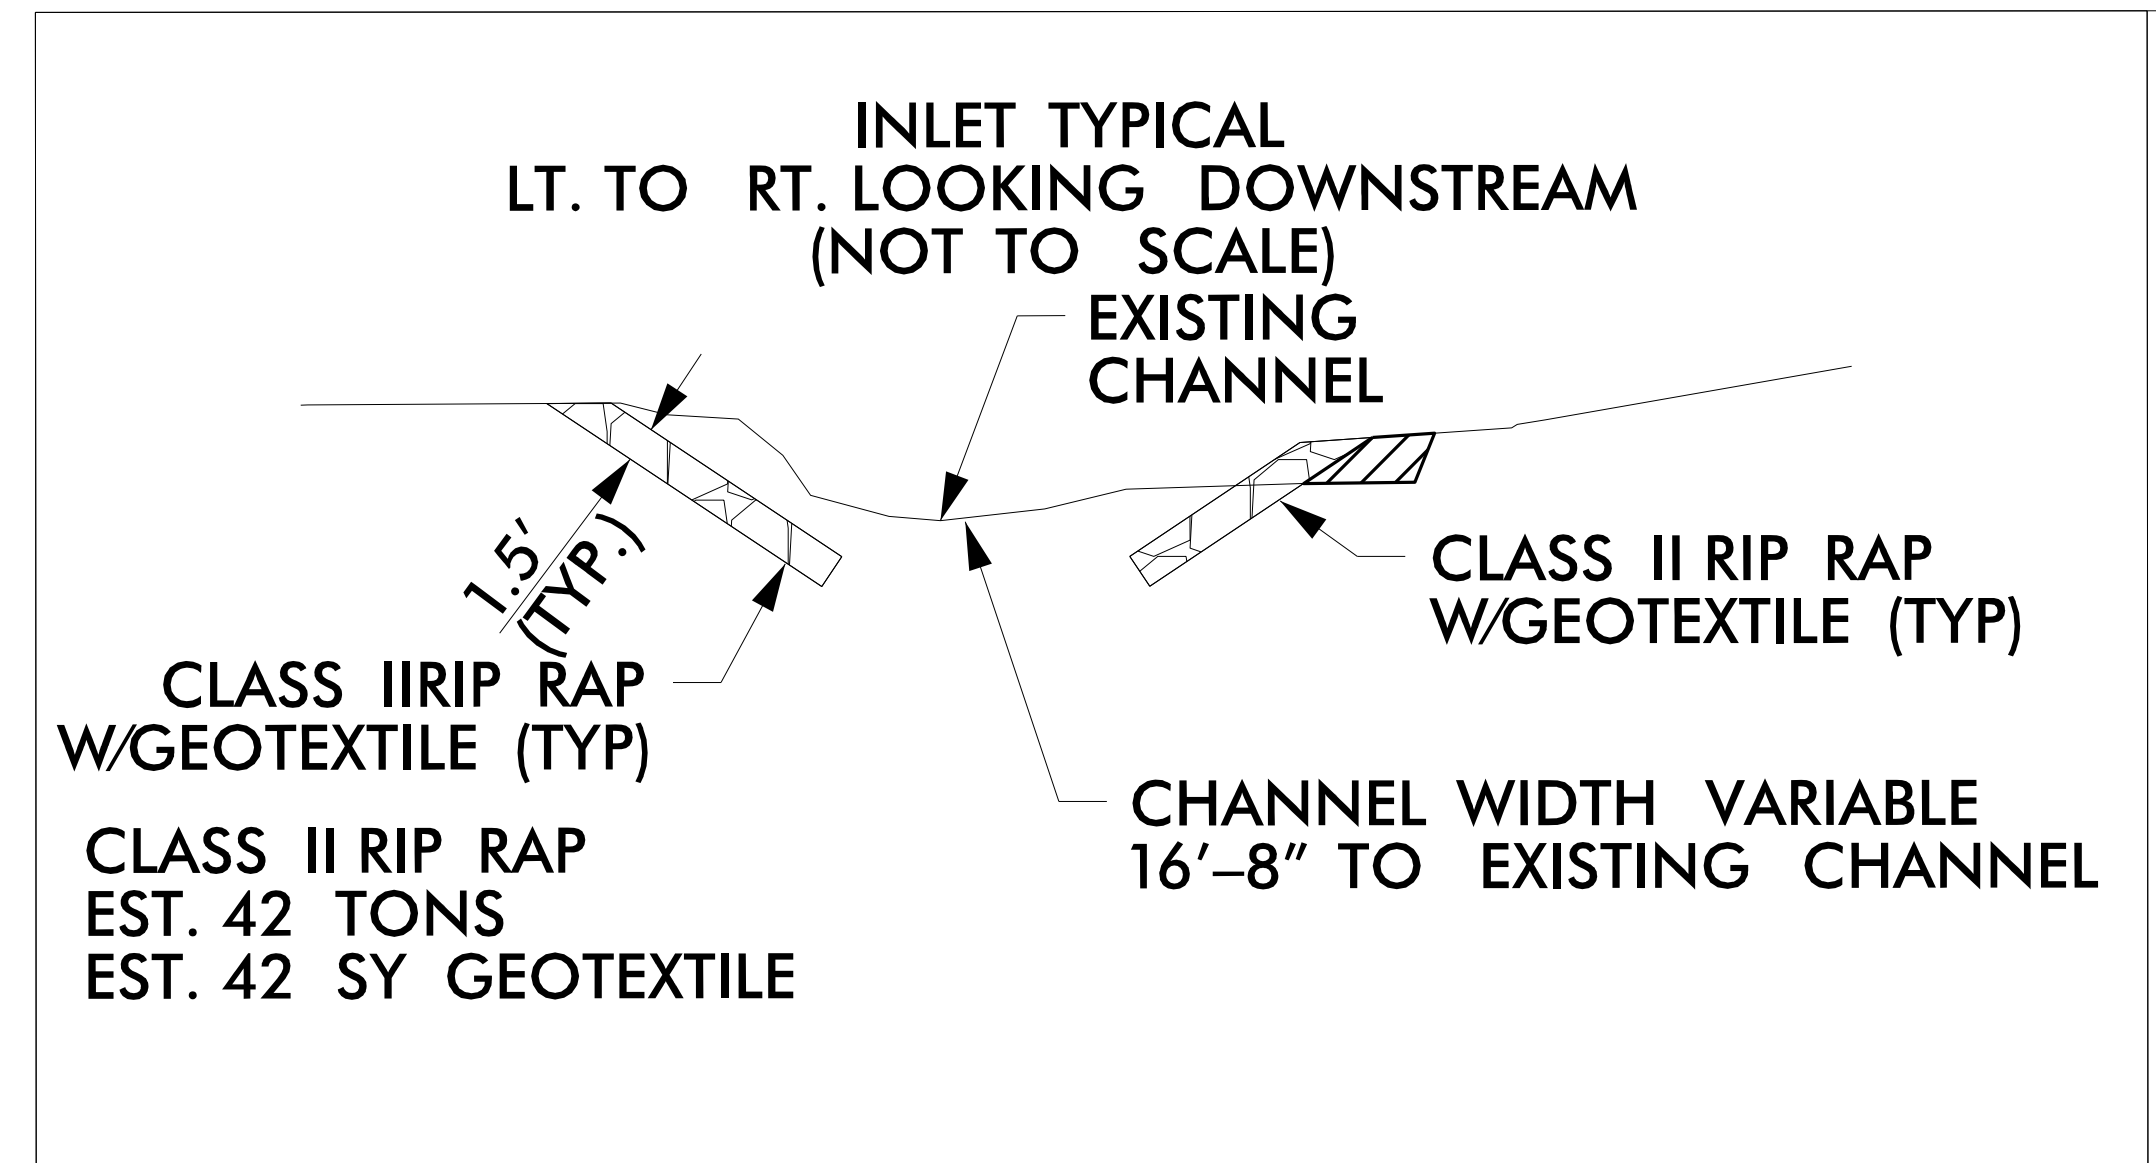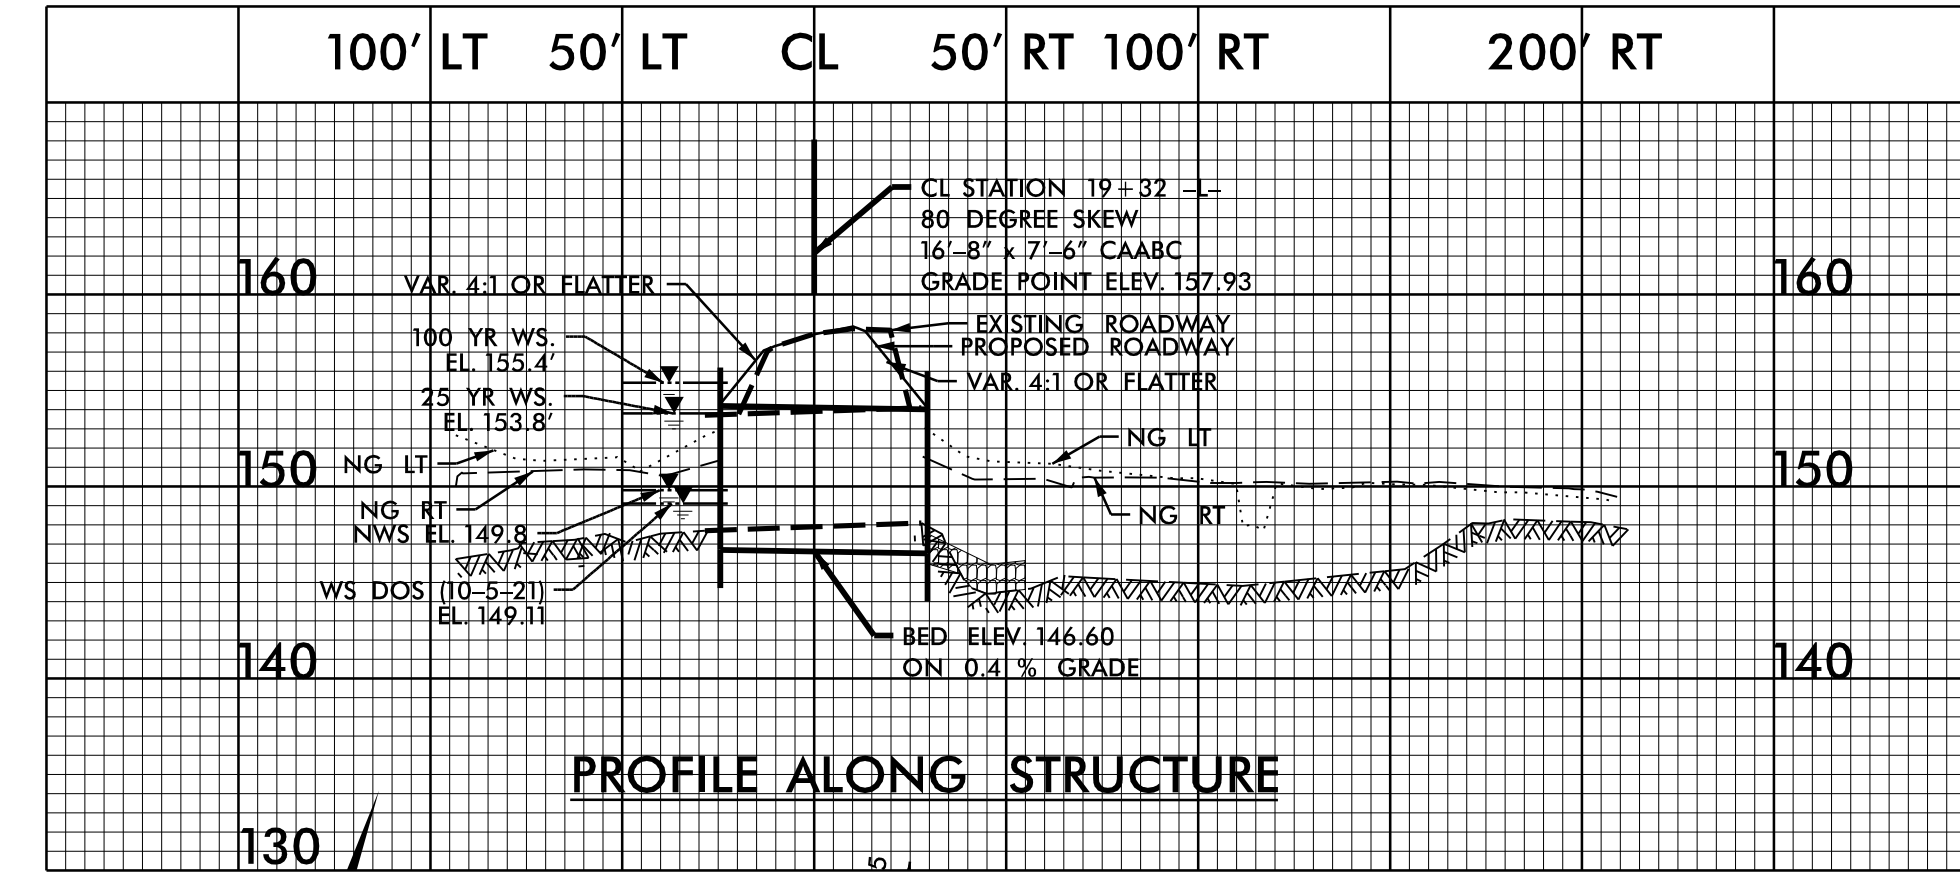WETHERILL ENGINEERING
 1223 Jones Franklin Rd.
 Raleigh, N.C. 27606
 License No. F-6377
 Bus: 919 851 8077
 Fax: 919 851 8107

TRANSPORTATION PLANNING/DESIGN - BRIDGE/STRUCTURE DESIGN
 CIVIL/SITE DESIGN - GIS/GPS - CONSTRUCTION OBSERVATION

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 11/14/2023 10:56:11 AM
 USER: jhessard



8/17/19

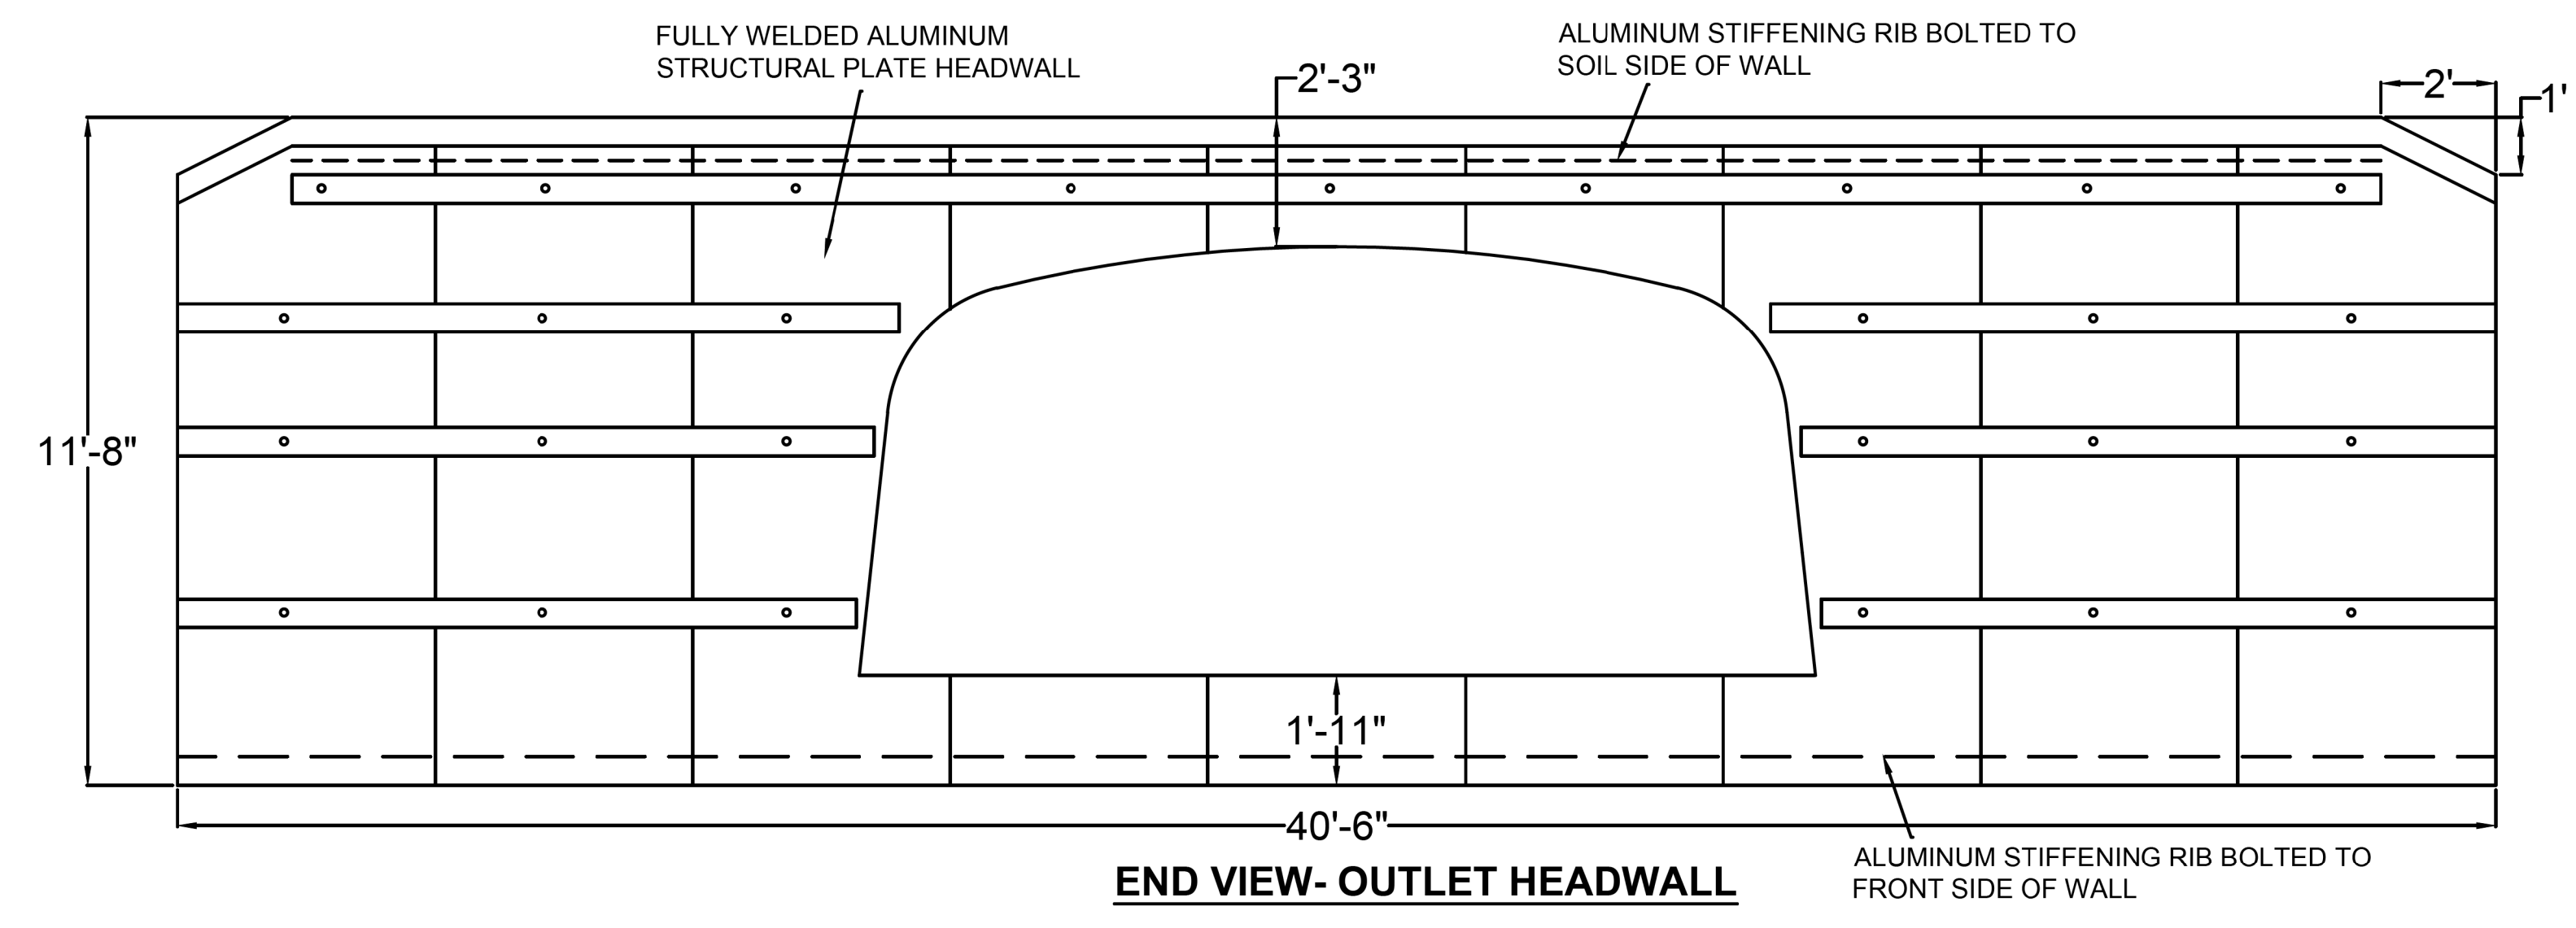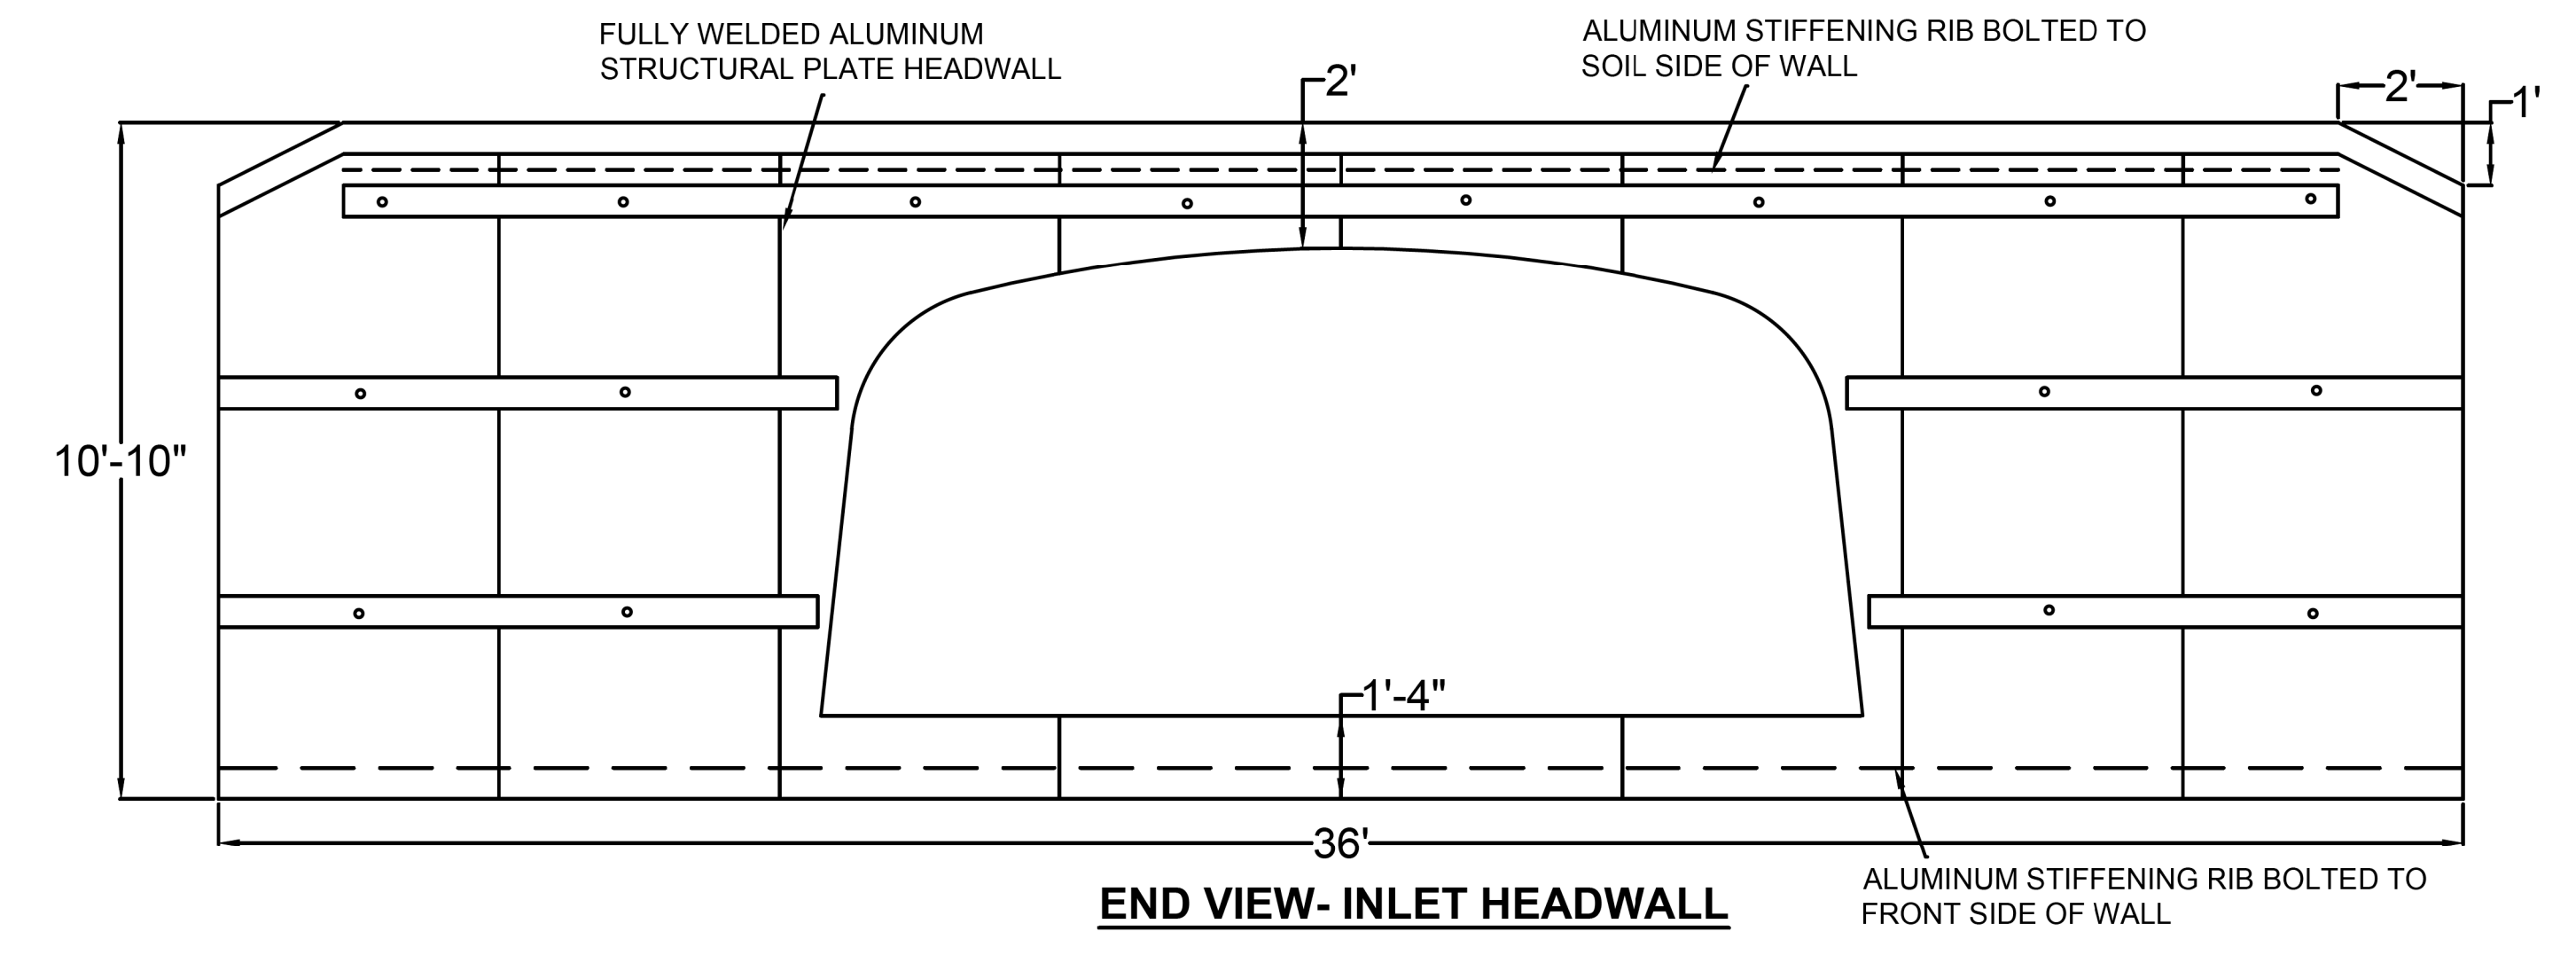PI Sta 17+93.45
 $\Delta = 6' 47'' 19.7''$ (LT)
 $D = 2' 10'' 00.0''$
 $L = 313.33'$
 $T = 156.85'$
 $R = 2,644.42'$
 SE=SEE PLANS

PI Sta 21+80.54
 $\Delta = 14' 27'' 13.8''$ (LT)
 $D = 3' 09'' 02.2''$
 $L = 458.76'$
 $T = 230.61'$
 $R = 1,818.57'$
 SE=SEE PLANS

BEGIN NCDOT PROJECT BP4.R028
-L- POC STA. 18+35.00

PIPE NO. 500548	PROJECT REFERENCE NO.	SHEET NO.
	BP4.R028	4
FINAL PLANS	R/W SHEET NO.	
DOCUMENT NOT CONSIDERED FINAL UNLESS ALL SIGNATURES COMPLETED	ROADWAY DESIGN ENGINEER	HYDRAULICS ENGINEER
	11/14/2023	11/15/2023
1223 Jones Franklin Rd. Raleigh, N.C. 27606 License No. F-0377 Bus: 919 851 8077 Fax: 919 851 8107 TRANSPORTATION PLANNING/DESIGN - BRIDGE/STRUCTURE DESIGN CIVIL/SITE DESIGN - GIS/GPS - CONSTRUCTION OBSERVATION		

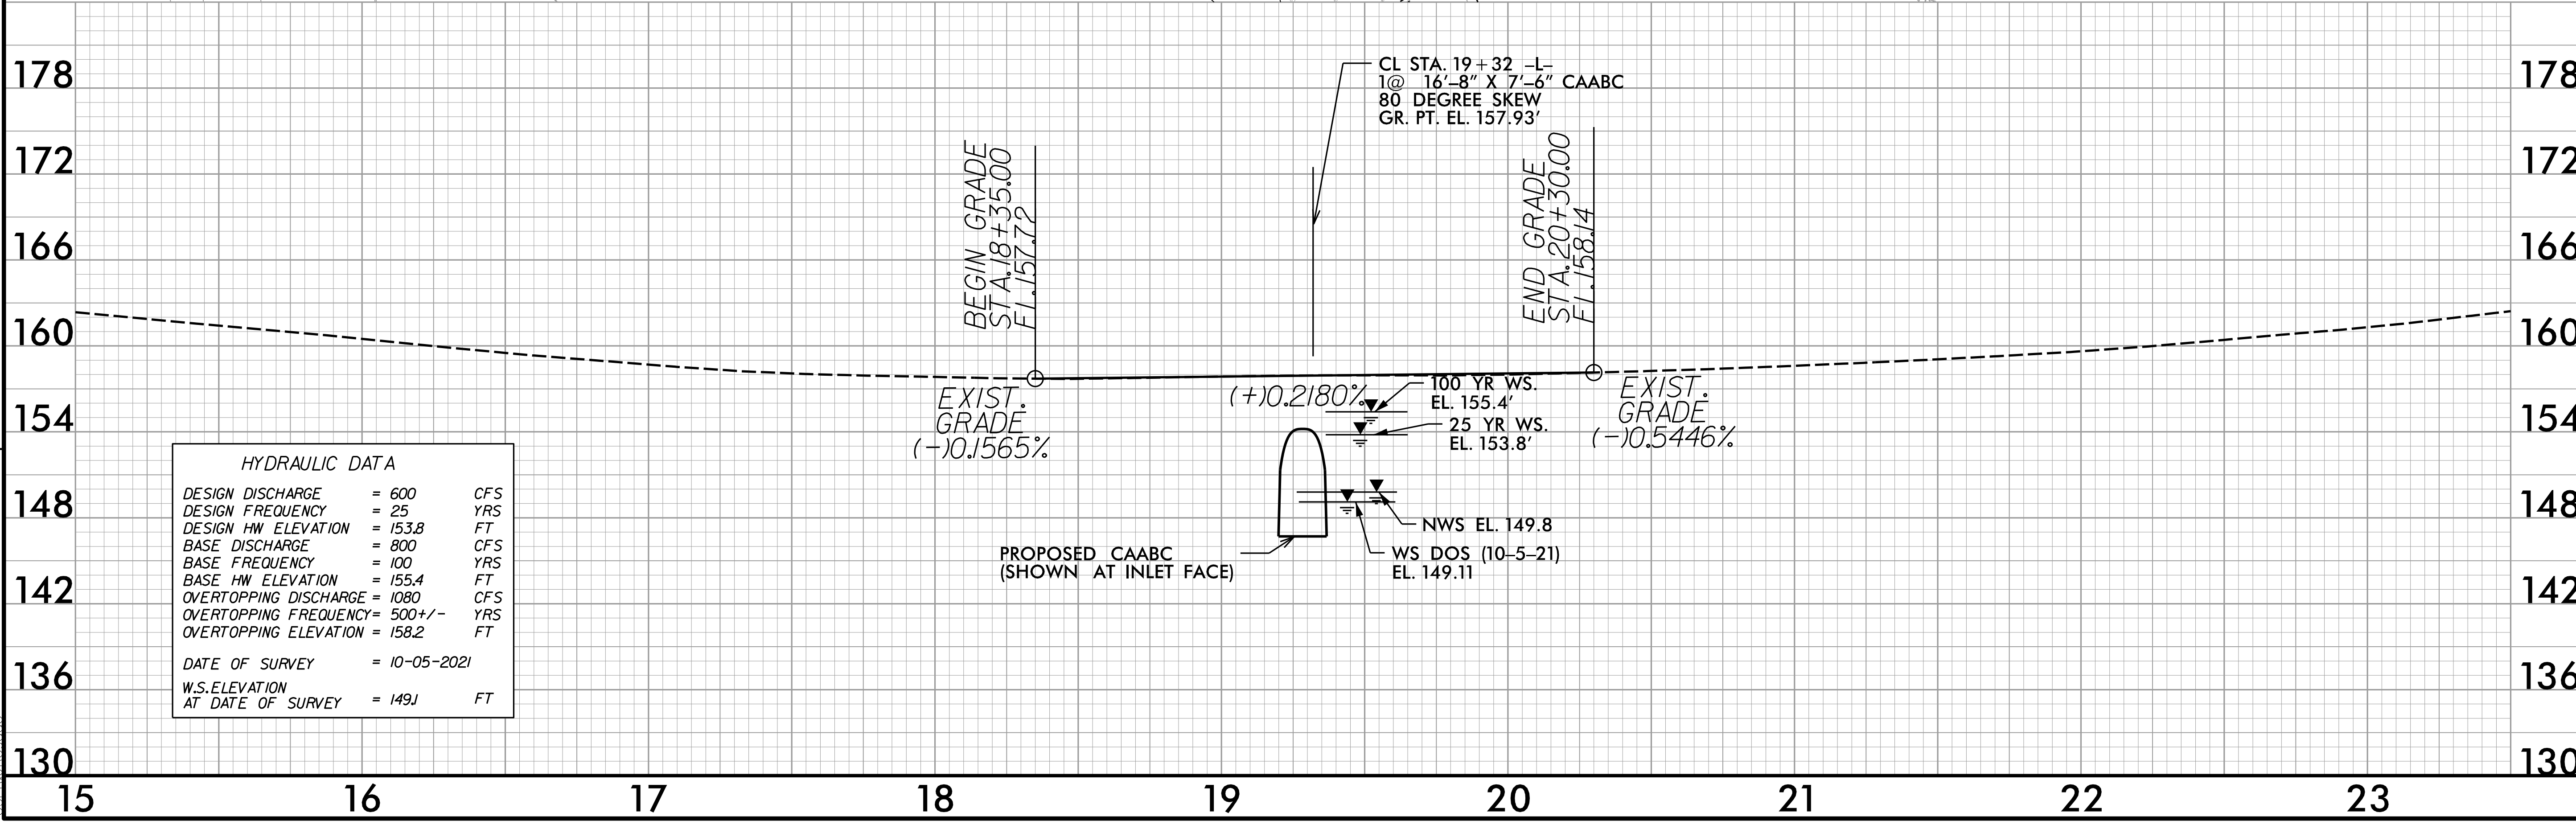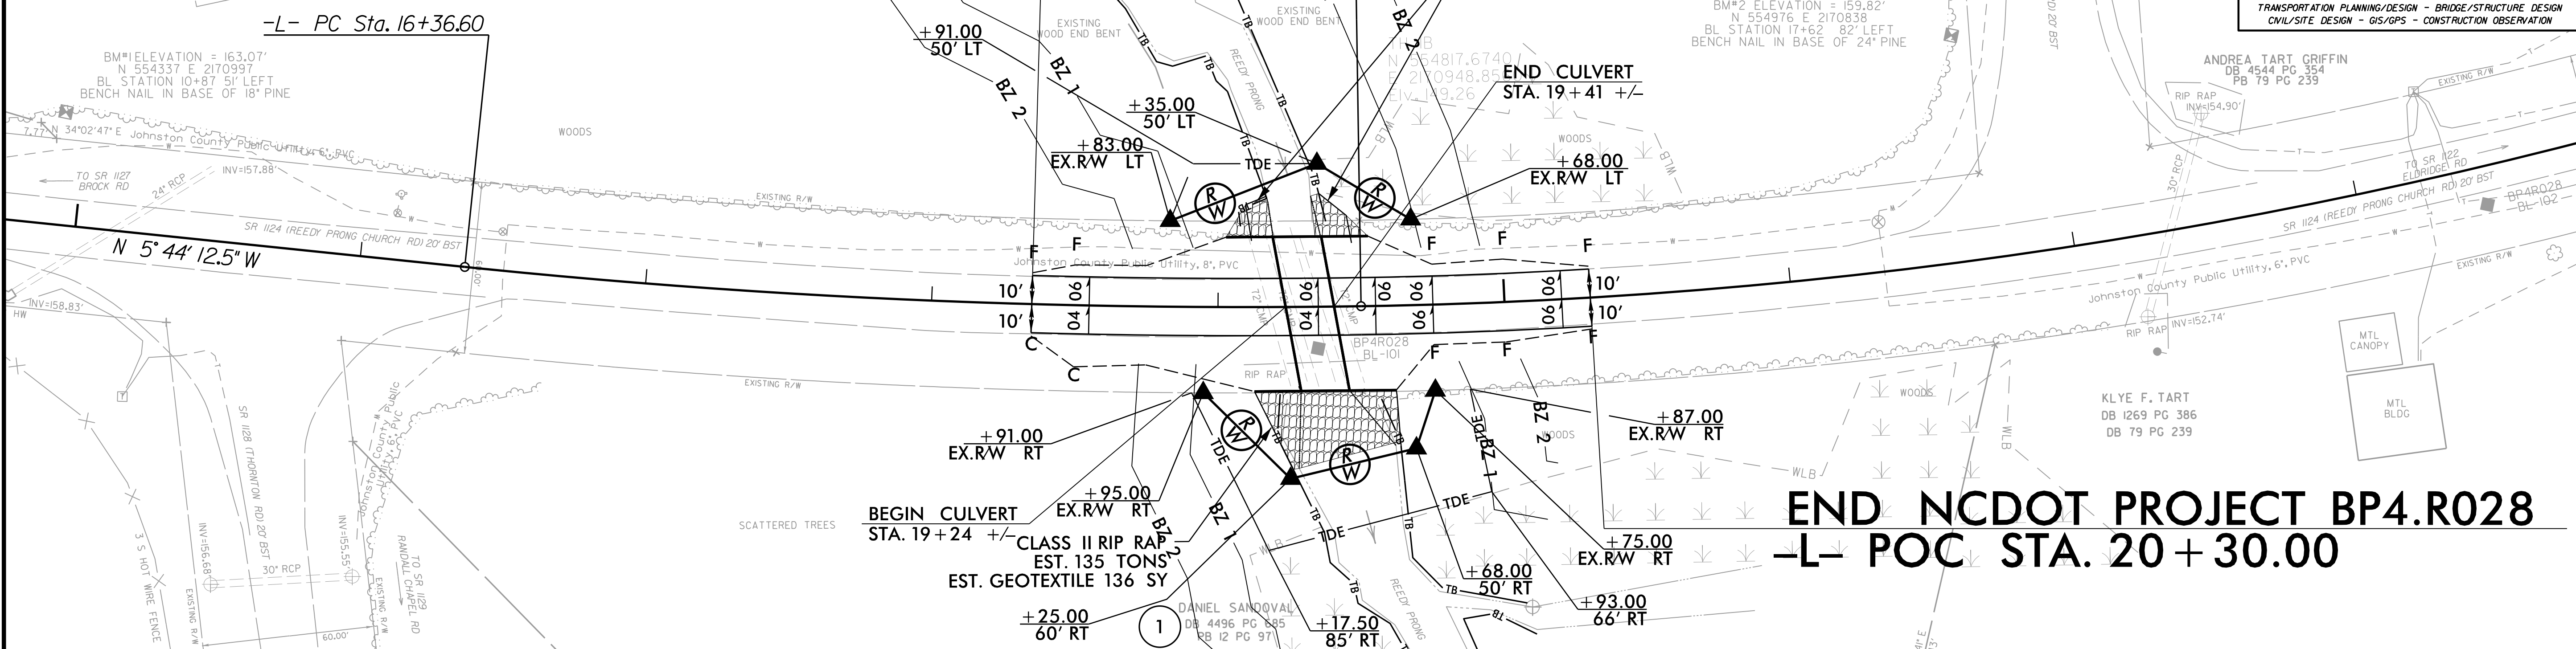

HYDRAULIC DATA		
DESIGN DISCHARGE	= 600	CFS
DESIGN FREQUENCY	= 25	YRS
DESIGN HW ELEVATION	= 153.8	FT
BASE DISCHARGE	= 800	CFS
BASE FREQUENCY	= 100	YRS
BASE HW ELEVATION	= 155.4	FT
OVERTOPPING DISCHARGE	= 1080	CFS
OVERTOPPING FREQUENCY	= 500 +/-	YRS
OVERTOPPING ELEVATION	= 158.2	FT
DATE OF SURVEY	= 10-05-2021	
W.S. ELEVATION AT DATE OF SURVEY	= 149J	FT

REVISIONS

11/14/2023
 P:\Projects\BP4.R028_R0Y_PSH_4.dgn
 JSE:R028.dwg

STATE	STATE PROJECT REFERENCE NO.	SHEET NO.	TOTAL SHEETS
N.C.	BP4.R028.1	RW01	4

STATE OF NORTH CAROLINA
DIVISION OF HIGHWAYS



SURVEY CONTROL, EXISTING CENTERLINES,
RIGHT OF WAY, EASEMENTS AND PROPERTY TIES

JOHNSTON COUNTY

09/06/99

TIP PROJECT: BP4.R028

24-MAY-2022 09:16 P:\2021\NCDOT_Location_and_Surveys\Div 4 3-Bridge RW Staking-April2022\80-Drawings\BP4.R028\FOR REVIEW\bp4_r028_ls_rw01.dgn amoire AT RAL-WS094

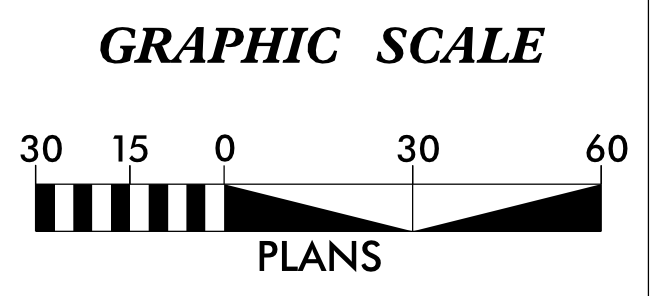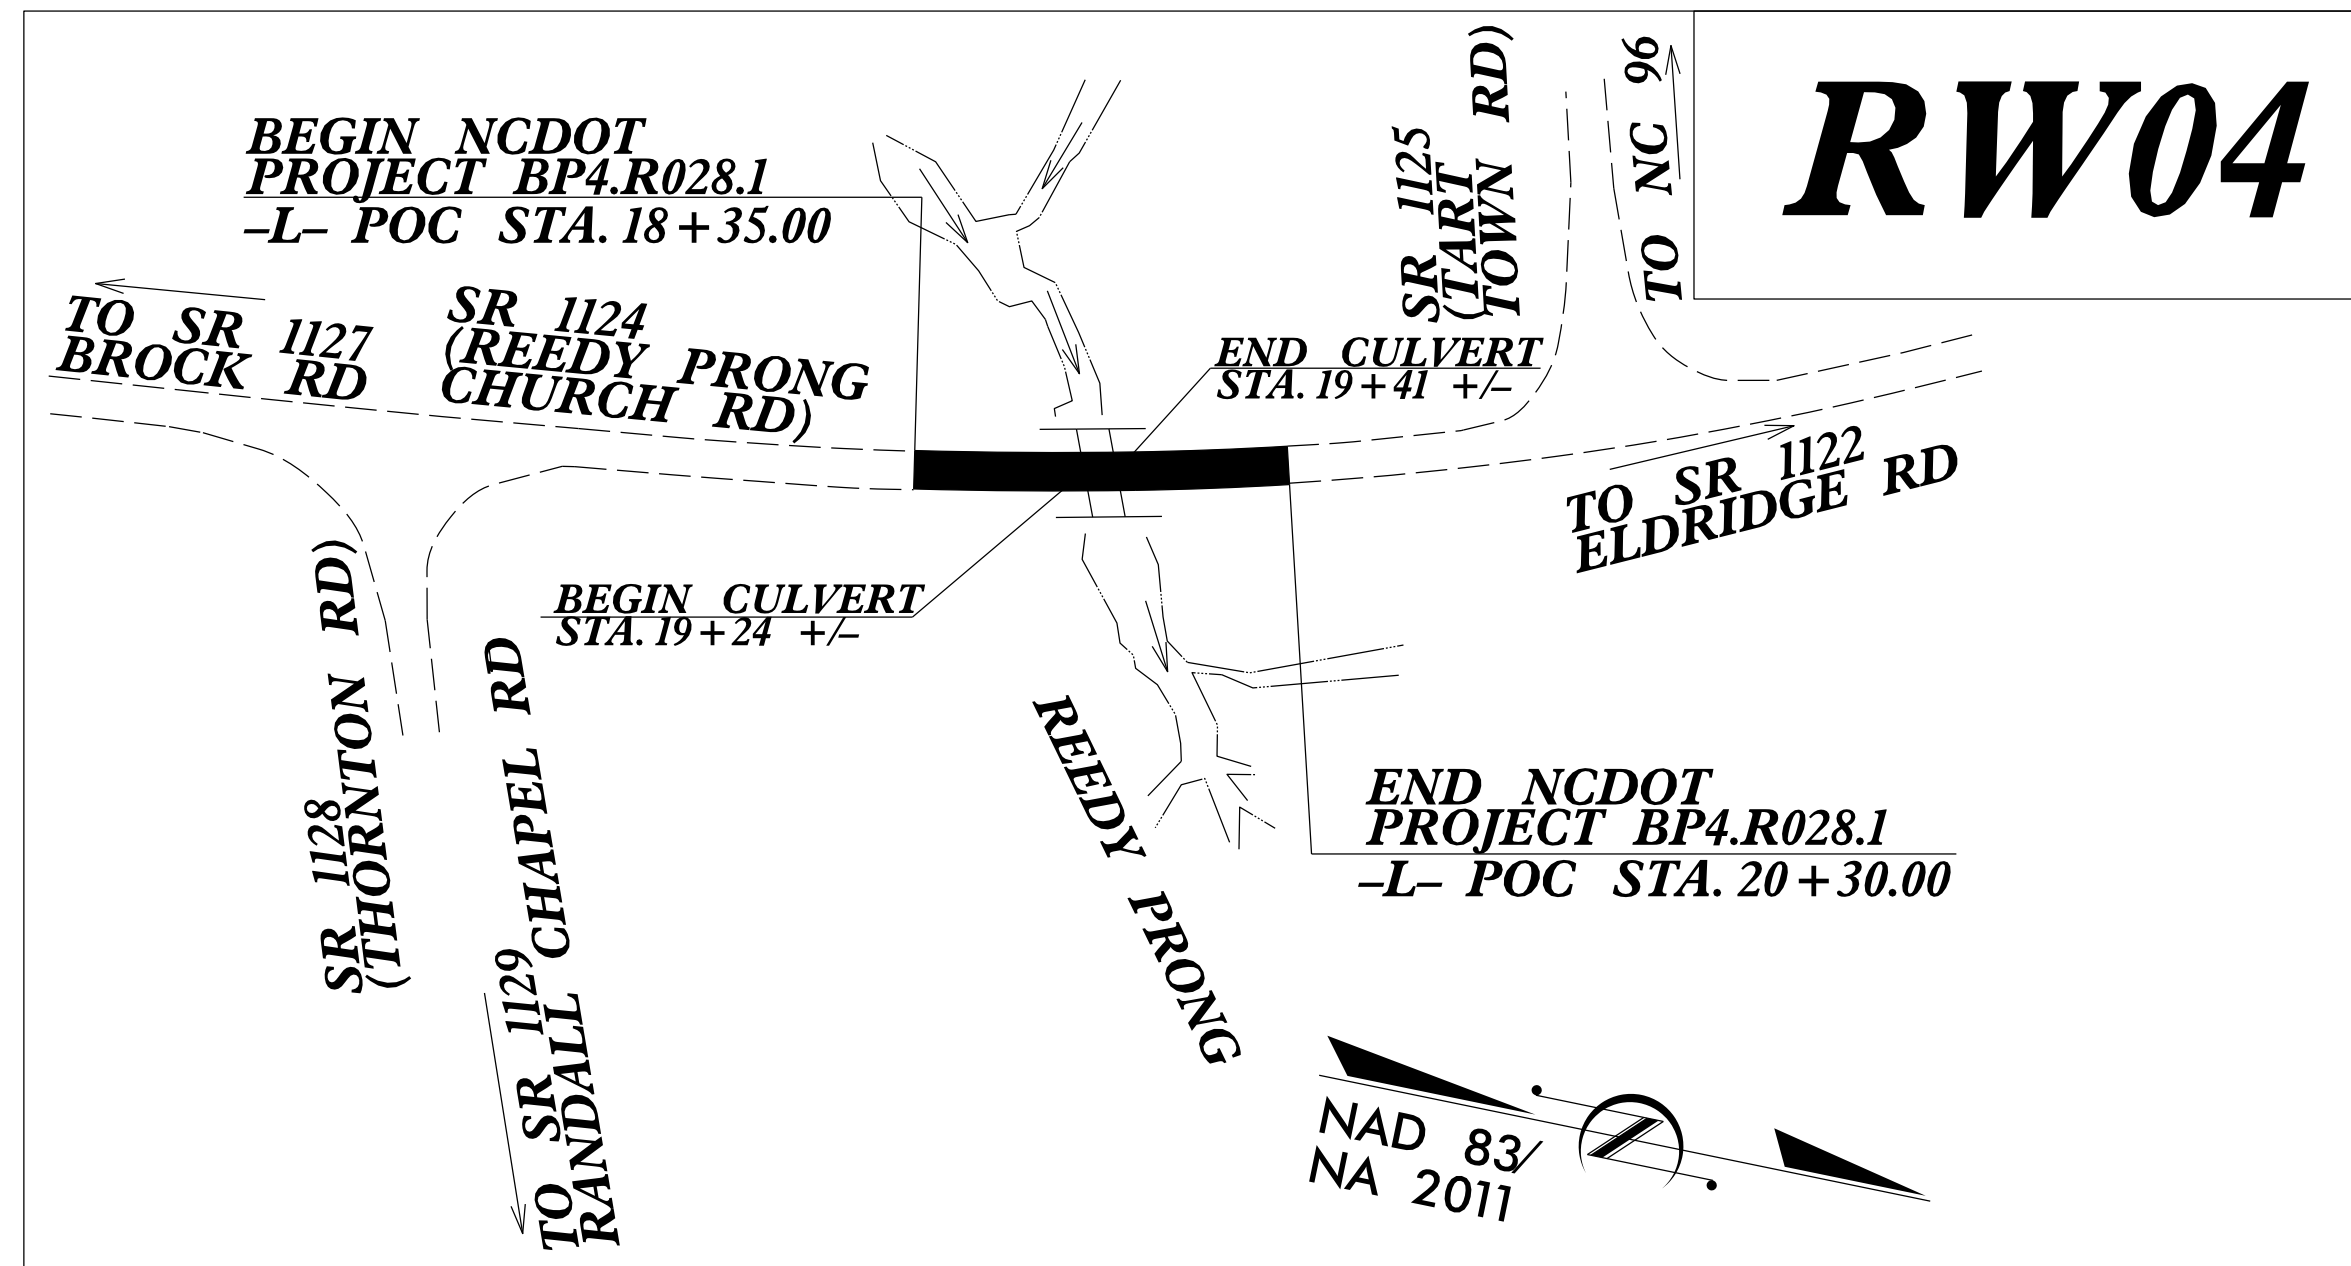

DATUM DESCRIPTION

THE LOCALIZED COORDINATE SYSTEM DEVELOPED FOR THIS PROJECT IS BASED ON THE STATE PLANE COORDINATES ESTABLISHED BY NCDOT FOR MONUMENT "BP4-R028-2" WITH NAD 83/NSRS 2011 STATE PLANE GRID COORDINATES OF NORTHING: 554,304.637(ft) EASTING: 2,171,053.693(ft) ELEVATION: 162.73(ft)

THE AVERAGE COMBINED GRID FACTOR USED ON THIS PROJECT (GROUND TO GRID) IS: 0.99987023

THE N.C. LAMBERT GRID BEARING AND LOCALIZED HORIZONTAL GROUND DISTANCE FROM "BP4-R028-2" TO -L- STATION 10+00.00 IS S 08-14'31.6" E 453.16(ft)

ALL LINEAR DIMENSIONS ARE LOCALIZED HORIZONTAL DISTANCES VERTICAL DATUM USED IS NAVD 88

Prepared in the Office of:



1223 Jones Franklin Rd.
Raleigh, N.C. 27606
License No. F-0377
Bus: 919 851 8077
Fax: 919 851 8107

TRANSPORTATION PLANNING/DESIGN - BRIDGE/STRUCTURE DESIGN
CIVIL/SITE DESIGN - GIS/GPS - CONSTRUCTION OBSERVATION

2018 STANDARD SPECIFICATIONS

RIGHT OF WAY DATE:
03/31/2022


LETTING DATE:
03/14/2023

PROFESSIONAL LAND SURVEYOR




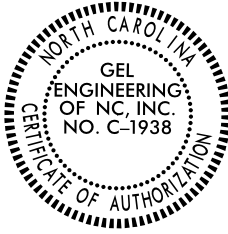

DocuSigned by:
Anthony K. Alford
22BA29B2F0BA44E...

Date:
5/24/2022

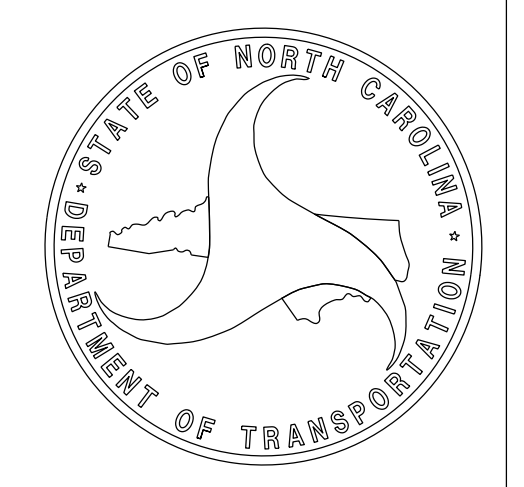

SURVEY CONTROL SHEET

W/ EXISTING CENTERLINE ALIGNMENTS PRIOR TO CONSTRUCTION

PROJECT REFERENCE NO.	SHEET NO.
BP4-R028	RW02C-1
Location and Surveys	
 GEL SOLUTIONS <small>an Affiliate of THE GEL GROUP, INC.</small> 2700 SUMNER BLVD. SUITE 106 RALEIGH, NC 27616 (919) 544-1100 WWW.GEL-SOLUTIONS.COM	
 	
DOCUMENT NOT CONSIDERED FINAL UNLESS ALL SIGNATURES COMPLETED	


I, PARKS H. ICENHOUR JR., PLS, certify that the Project Control was (performed/verified) under my supervision from an actual GPS survey made under my supervision and the following information was used to perform the survey:

Class of survey: AA
 Type of GPS field procedure: (RTN)
 Dates of survey: March 23rd 2021
 Datum/Epoch: NAD 1983/2011 (CONUS)
 Published/Fixed-control used: (Control Utilized)
 Localized around: BP4R028-2
 Northing: 554304.6370
 Easting: 2171053.6930
 Combined grid factor: 0.99987023
 Geoid model: GEOID 18 (CONUS)
 Units: US SURVEY FEET

"I also certify that the baseline control for this project was completed under my direct and responsible charge from an actual survey made under my supervision; that all horizontal closures had a minimum ratio of precision of 1:20,000 (Class AA) and vertical accuracy to Class A. Field work was performed from March 23rd 2021 to April 1st 2021, and all coordinates are based on NAD 83 /2011 and all elevations are based on NAVD 88; That this survey was performed to meet the requirements of 21NCAC 56.1600 as applicable.

This 18th day of April, 2021.

Professional Land Surveyor L-3996

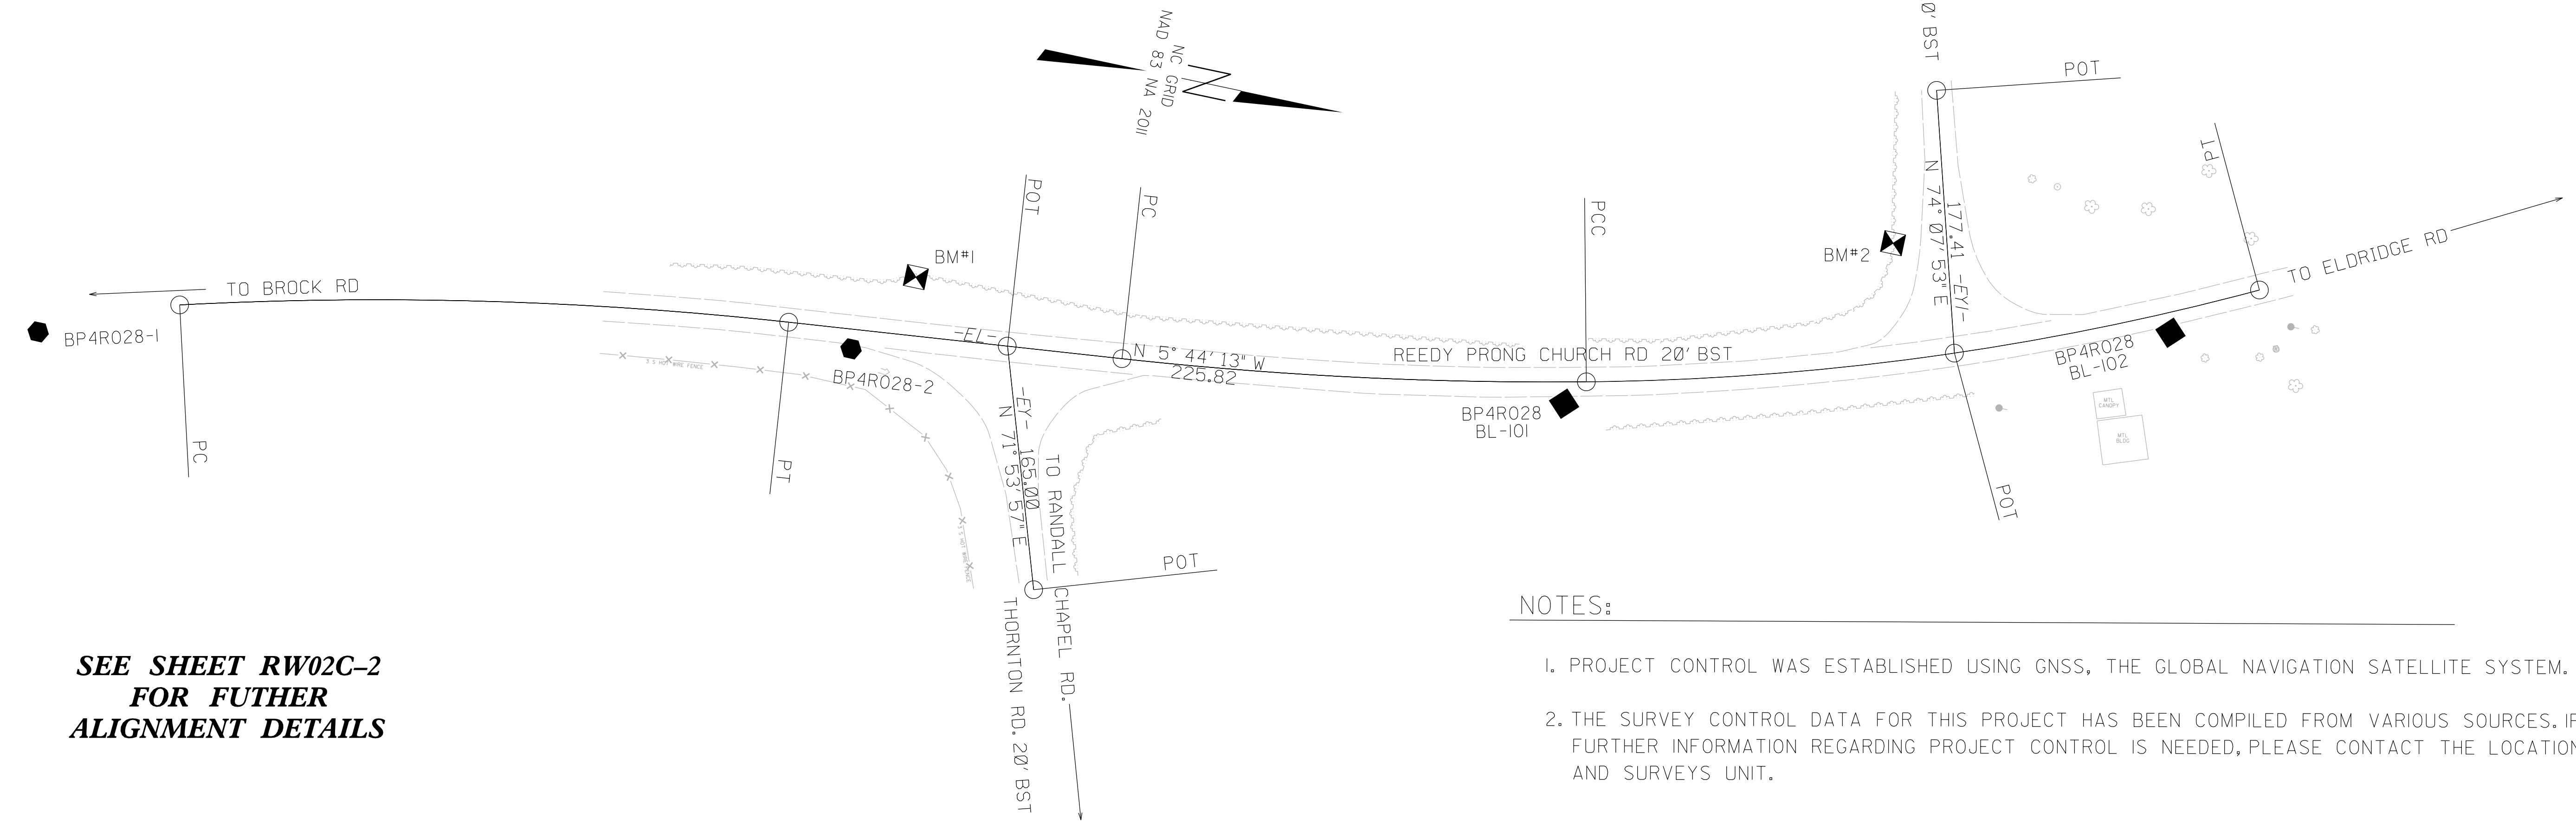


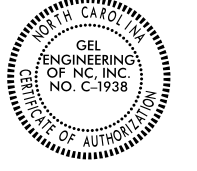

**SEE SHEET RW02C-2
FOR FUTHER
ALIGNMENT DETAILS**

NOTES:

1. PROJECT CONTROL WAS ESTABLISHED USING GNSS, THE GLOBAL NAVIGATION SATELLITE SYSTEM.
2. THE SURVEY CONTROL DATA FOR THIS PROJECT HAS BEEN COMPILED FROM VARIOUS SOURCES. IF FURTHER INFORMATION REGARDING PROJECT CONTROL IS NEEDED, PLEASE CONTACT THE LOCATION AND SURVEYS UNIT.

SURVEY CONTROL SHEET

W/ EXISTING CENTERLINE ALIGNMENTS PRIOR TO CONSTRUCTION

PROJECT REFERENCE NO. BP4-R028	SHEET NO. RW02C-2
Location and Surveys	
 <small>an Affiliate of THE GEL GROUP, INC. 2700 SUMNER BLVD. SUITE 106 RALEIGH, NC 27616 (919) 544-1100 WWW.GEL-SOLUTIONS.COM</small>	
 	
DOCUMENT NOT CONSIDERED FINAL UNLESS ALL SIGNATURES COMPLETED	

BL	POINT	DESC.	NORTH	EAST	ELEVATION
1		BP4R028-1	553766.6945	2171156.1897	172.00
2		BP4R028-2	554304.6370	2171053.6930	162.73
101		BP4R028 BL 101	554782.0420	2170990.0870	158.11
102		BP4R028 BL 102	555171.6430	2170858.4980	162.09

***** BM1 ELEVATION = 163.07 N 554337 E 2170997 BL STATION 10+87.00 51 LEFT BENCH NAIL SET IN BASE OF 18" PINE *****	***** BM2 ELEVATION = 159.82 N 554976 E 2170838 BL STATION 17+62.00 82 LEFT BENCH NAIL SET IN BASE OF 24" PINE *****
---	---

I, PARKS H. ICENHOUR JR., PLS, certify that the Project Control was (performed/verified) under my supervision from an actual GPS survey made under my supervision and the following information was used to perform the survey:

Class of survey: AA
 Type of GPS field procedure: (RTN)
 Dates of survey: March 23rd 2021
 Datum/Epoch: NAD 1983/2011 (CONUS)
 Published/Fixed-control used: (Control Utilized)
 Localized around: BP4R028-2
 Northing: 554304.6370
 Easting: 2171053.6930
 Combined grid factor: 0.99987023
 Geoid model: GEOID 18 (CONUS)
 Units: US SURVEY FEET

"I also certify that the baseline control for this project was completed under my direct and responsible charge from an actual survey made under my supervision; that all horizontal closures had a minimum ratio of precision of 1:20,000 (Class AA) and vertical accuracy to Class A. Field work was performed from March 23rd 2021 to April 1st 2021, and all coordinates are based on NAD 83 /2011 and all elevations are based on NAVD 88; That this survey was performed to meet the requirements of 21NCAC 56.1600 as applicable.

This 18th day of April, 2021.

Professional Land Surveyor L-3996

EL									
POINT	N	E	BEARING	DIST	DELTA	D	L	T	R
PC	553856.158	2171118.656							
CURVE			N 10°21'29.0" W	410.33	09°14'33.0"(RT)	02°15'00.0"	410.78	205.84	2546.48
PT	554259.803	2171044.879							
LINE			N 05°44'12.5" W	225.82					
PC	554484.495	2171022.306							
CURVE			N 09°07'52.4" W	313.15	06°47'19.7"(LT)	02°10'00.0"	313.33	156.85	2644.42
PCC	554793.674	2170972.611							
CURVE			N 19°45'09.1" W	457.55	14°27'13.8"(LT)	03°09'02.2"	458.76	230.61	1818.57
PT	555224.300	2170817.978							

EY				
POINT	N	E	BEARING	DIST
POT	554407.366	2171030.054		
LINE			N 71°53'56.8" E	165.00
POT	554458.631	2171186.890		

EY1				
POINT	N	E	BEARING	DIST
POT	554983.668	2170731.555		
LINE			N 74°07'53.2" E	177.41
POT	555032.178	2170902.206		

NOTES:

1. PROJECT CONTROL WAS ESTABLISHED USING GNSS, THE GLOBAL NAVIGATION SATELLITE SYSTEM.
2. THE SURVEY CONTROL DATA FOR THIS PROJECT HAS BEEN COMPILED FROM VARIOUS SOURCES. IF FURTHER INFORMATION REGARDING PROJECT CONTROL IS NEEDED, PLEASE CONTACT THE LOCATION AND SURVEYS UNIT.



REVISIONS

6/2/19

REVISIONS

24 MAY 2022 09:17
P:\2021\NCDOT\Location and Surveys\Div 4 3-Bridge RW Staking\Apr112022\80-Drawings\BP4.R028\FOR REVIEW\bp4_r028d-1.dgn
AT RAL-WS094
enore

PROPOSED ALIGNMENT CONTROL SHEET

PROJECT REFERENCE NO. BP4.R028	SHEET NO. RW02D-1
Location and Surveys	
	
<small>1223 Jones Franklin Rd. Raleigh, N.C. 27606 License No. F-6377 Bus: 919 851 8077 Fax: 919 851 8107</small>	
<small>TRANSPORTATION PLANNING/DESIGN - BRIDGE/STRUCTURE DESIGN CIVIL/SITE DESIGN - GIS/GPS - CONSTRUCTION OBSERVATION</small>	
PROJECT SURVEYOR 	
DOCUMENT NOT CONSIDERED FINAL UNLESS ALL SIGNATURES COMPLETED	

I, Anthony K. Alford, PLS, certify that the data compiled came from available surveys/mapping performed by others and provided to me by NCDOT and do not certify to the accuracy or quality of the individual data sources.

This 24th day of May, 2022.

DocuSigned by:
Anthony K. Alford
22BA2982F0BA44E

Professional Land Surveyor L-4372



		L	
TYPE	STATION	NORTH	EAST
PC	10+00.00	553856.1580	2171118.6564
PT	14+10.78	554259.8032	2171044.8790
PC	16+36.60	554484.4953	2171022.3059
PCC	19+49.93	554793.6736	2170972.6108
PT	24+08.69	555224.3004	2170817.9784

NOTES:

1. PROJECT CONTROL WAS ESTABLISHED USING GNSS, THE GLOBAL NAVIGATION SATELLITE SYSTEM.
2. THE PROPOSED ALIGNMENT CONTROL DATA FOR THIS PROJECT HAS BEEN COMPILED FROM VARIOUS SOURCES. IF FURTHER INFORMATION REGARDING PROJECT CONTROL IS NEEDED, PLEASE CONTACT THE LOCATION AND SURVEYS UNIT.


6/2/19

RIGHT OF WAY CONTROL SHEET

PROJECT REFERENCE NO. BP4.R028	SHEET NO. RW03E-1
Location and Surveys	
	
<small>1223 Jones Franklin Rd. Raleigh, N.C. 27606 License No. F-0377 Bus: 919 851 8077 Fax: 919 851 8107</small>	
<small>TRANSPORTATION PLANNING/DESIGN - BRIDGE/STRUCTURE DESIGN CIVIL/SITE DESIGN - GIS/GPS - CONSTRUCTION OBSERVATION</small>	
PROJECT SURVEYOR	
	
DOCUMENT NOT CONSIDERED FINAL UNLESS ALL SIGNATURES COMPLETED	

I, Anthony K. Alford, certify that the right of way and permanent easement monumentation for this project shown herein was completed under my direct and responsible charge from an actual survey made under my supervision; that all horizontal closures had a minimum ratio of precision of 1:10,000 (Class A). Field work was performed from 05/23/2022 to 05/23/2022, and all coordinates are based on NAD83/2011; That this survey was performed to meet the requirements of 21NCAC 56.1600 as applicable.

This 24th day of May, 2022.

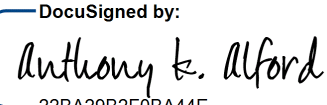DocuSigned by:

22BA29B2F0BA44E
 Professional Land Surveyor L-4372

ROW MARKER IRON PIN AND CAP-E



ALIGN	STATION	OFFSET	NORTH	EAST
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L	18+95.00	30.00	554745.8272	2171013.3809
L	19+25.00	60.00	554781.7712	2171036.5948
L	19+35.00	-50.00	554768.5213	2170926.9373
L	19+68.00	-30.00	554804.4963	2170939.3845
L	19+68.00	50.00	554822.6215	2171017.3042
L	19+75.00	30.00	554825.0176	2170996.1988

NOTES:


1. IF FURTHER INFORMATION REGARDING PROJECT CONTROL IS NEEDED PLEASE CONTACT THE LOCATION AND SURVEYS UNIT.
2. PROJECT CONTROL WAS ESTABLISHED USING GNSS, THE GLOBAL NAVIGATION SATELLITE SYSTEM.
3. RIGHT OF WAY MONUMENTATION ESTABLISHED 05/23/2022 TO 05/23/2022 .


REVISIONS

24 MAY 2022 09:18
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 AT RAL-WS094
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PROJECT REFERENCE NO.	SHEET NO.
BP4.R028	RW04
Location and Surveys	
	
1223 Jones Franklin Rd. Raleigh, N.C. 27606 License No. F-0377 Bus: 919 851 8077 Fax: 919 851 8107	
<small>TRANSPORTATION PLANNING/DESIGN - BRIDGE/STRUCTURE DESIGN CIVIL/SITE DESIGN - GIS/GPS - CONSTRUCTION OBSERVATION</small>	
PROJECT SURVEYOR 	
DOCUMENT NOT CONSIDERED FINAL UNLESS ALL SIGNATURES COMPLETED	


I, Anthony K. Alford, certify that the right of way and permanent easement monumentation for this project shown herein was completed under my direct and responsible charge from an actual survey made under my supervision; that all horizontal closures had a minimum ratio of precision of 1:10,000 (Class A). Field work was performed from 05/23/2022 to 05/23/2022, and all coordinates are based on NAD83/2011; That this survey was performed to meet the requirements of 21NCAC 56.1600 as applicable.

This 24th day of May, 2022.
 DocuSigned by:

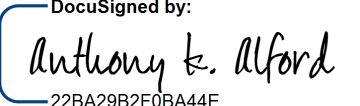 22BA29B2F0BA44E...
 Professional Land Surveyor L-4372

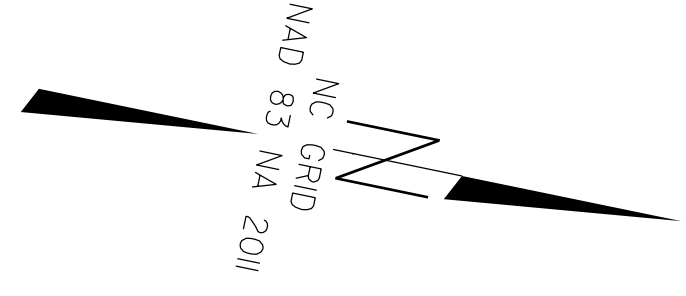

**BEGIN NCDOT
 PROJECT BP4.R028.1
 -L- POC STA. 18 + 35.00**

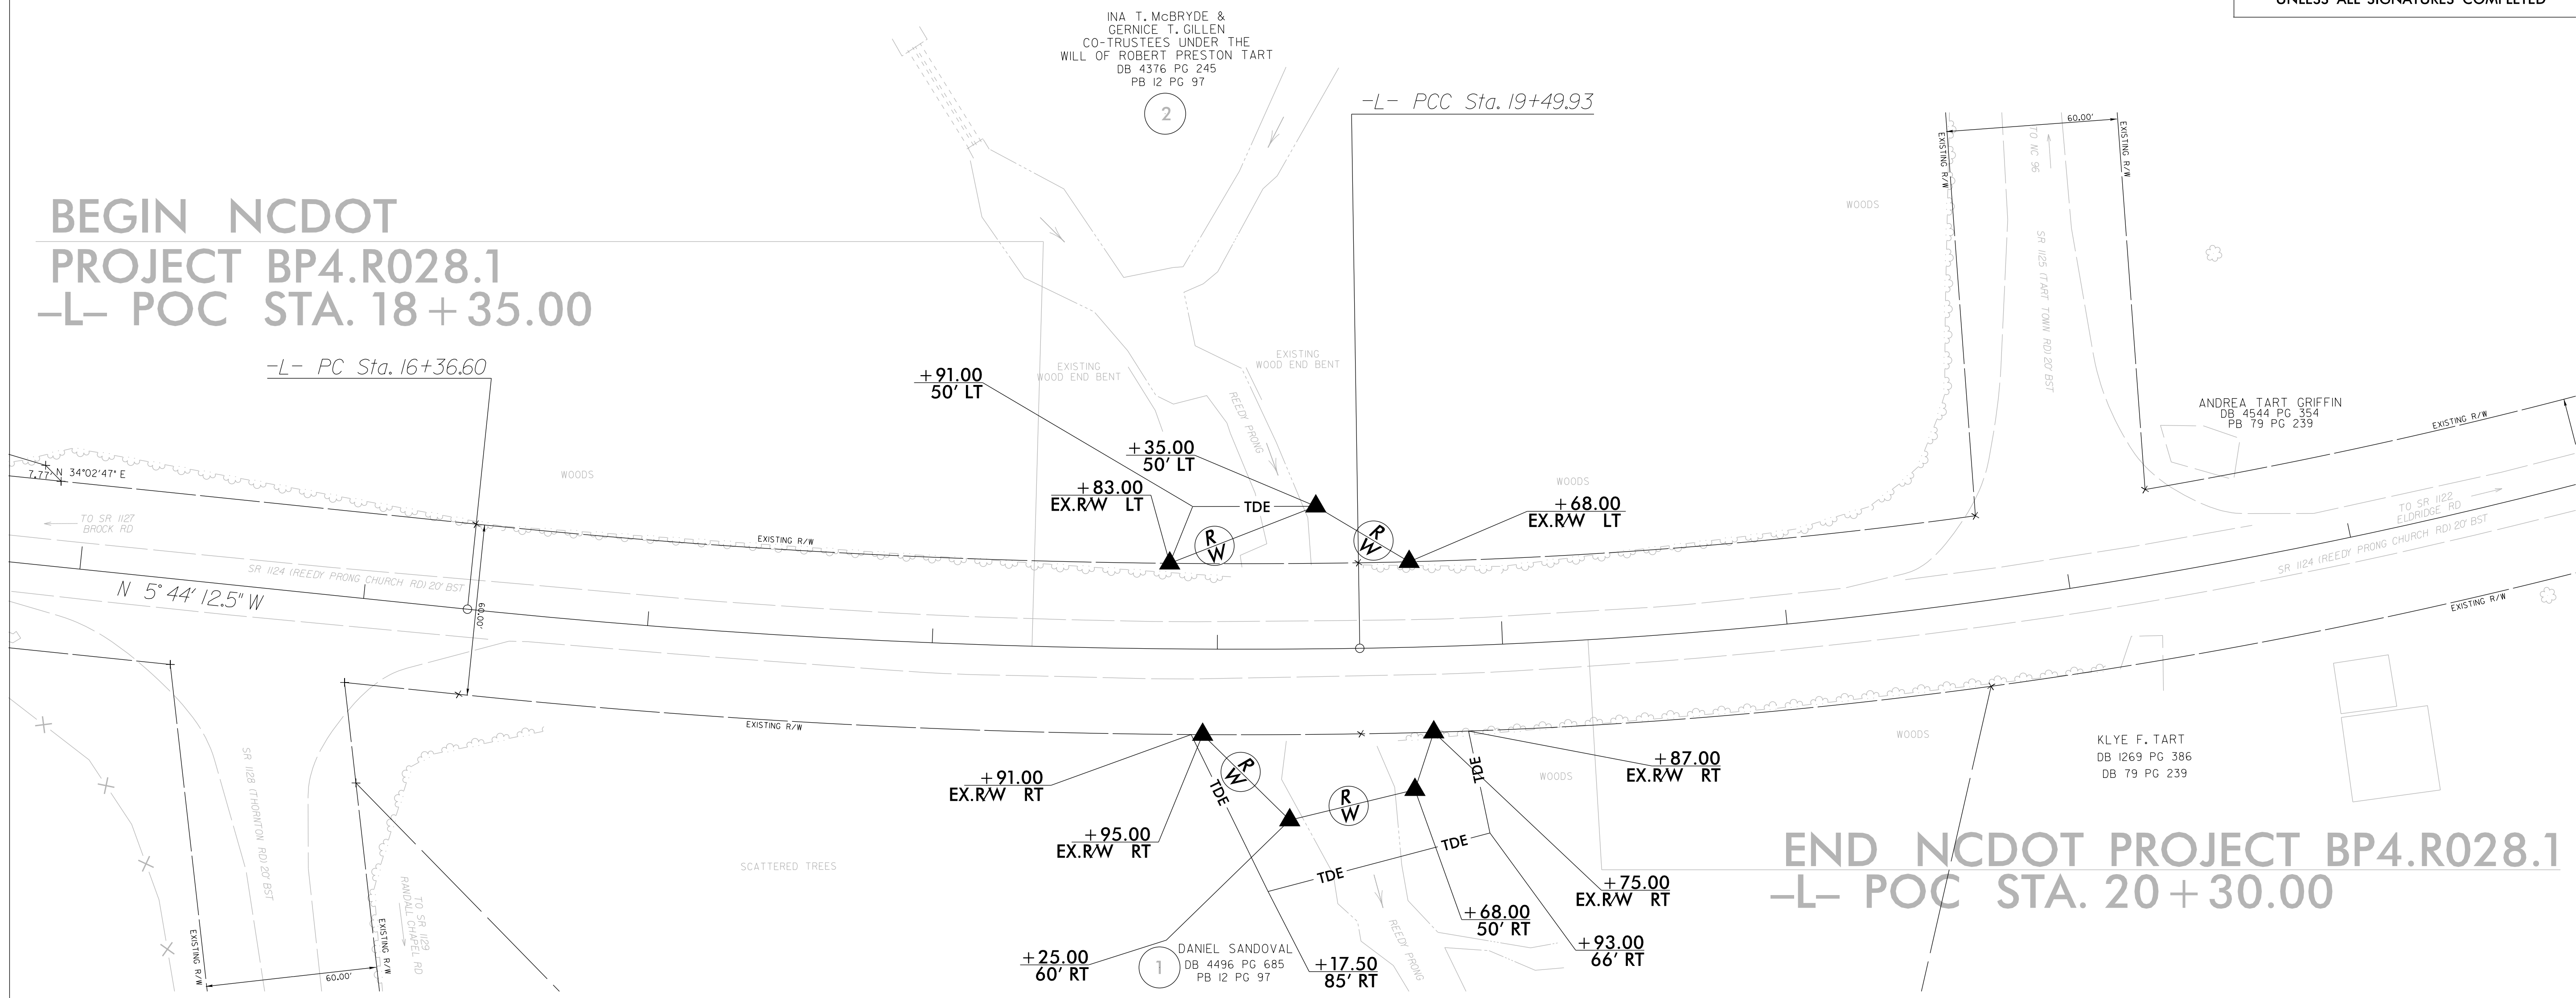**END NCDOT PROJECT BP4.R028.1
 -L- POC STA. 20 + 30.00**



REVISIONS

24 MAY 2022 09:29
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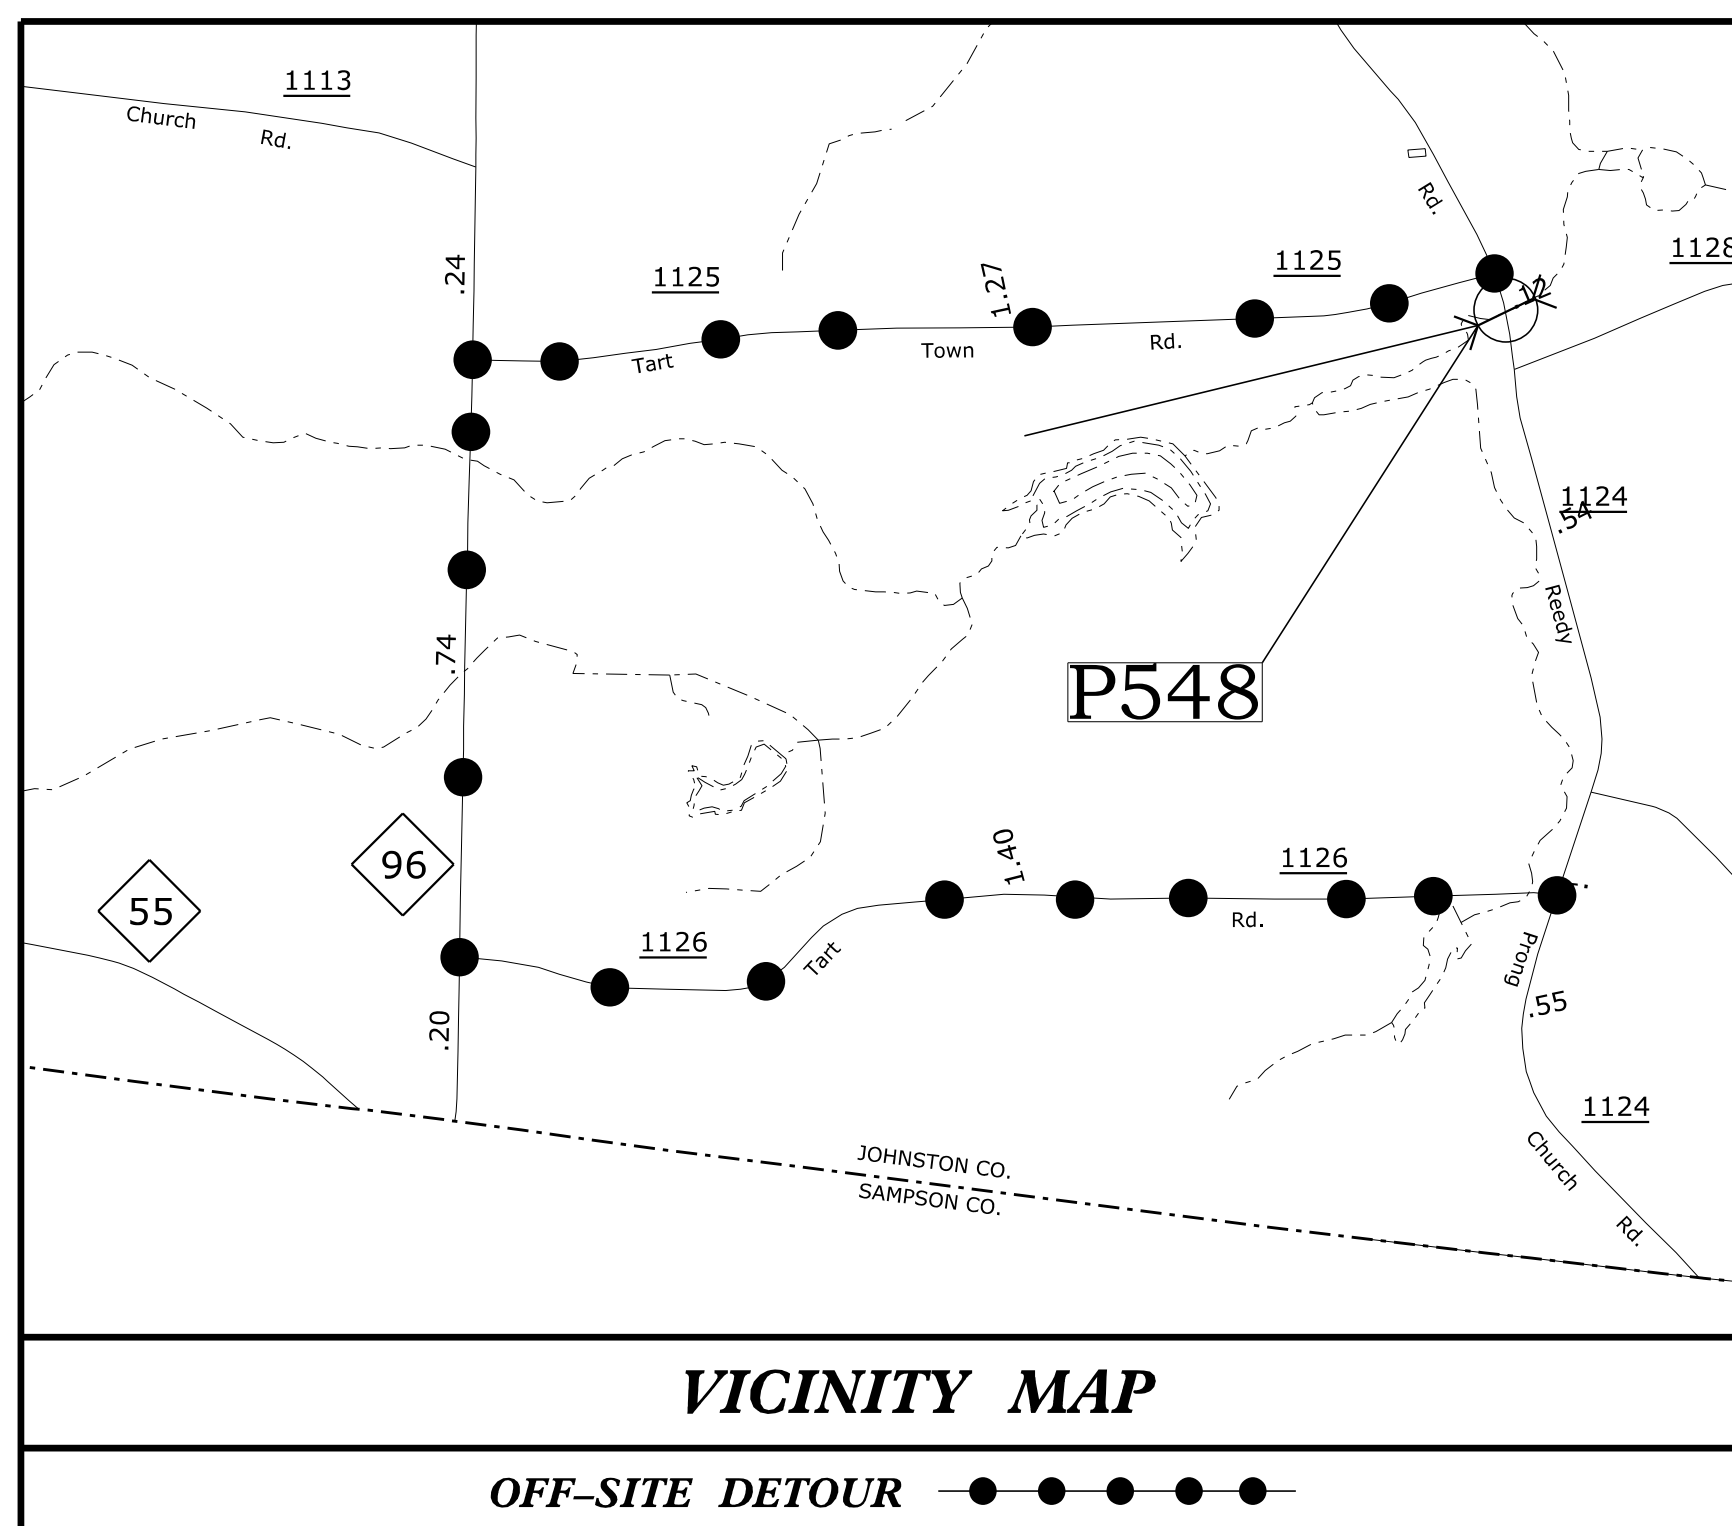
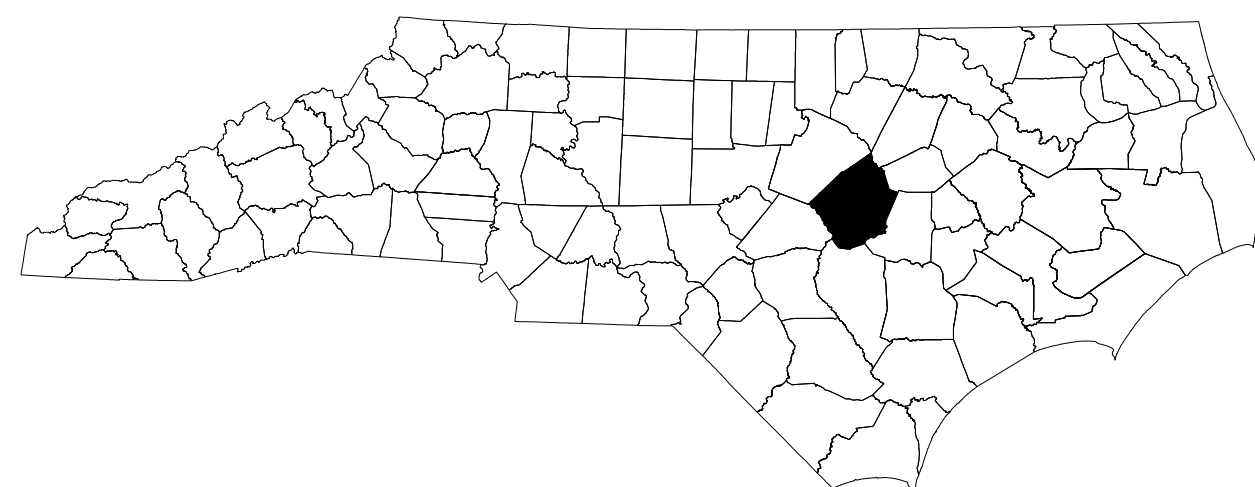
NOTES:

1. IF FURTHER INFORMATION REGARDING PROJECT CONTROL IS NEEDED PLEASE CONTACT THE LOCATION AND SURVEYS UNIT.
2. PROJECT CONTROL WAS ESTABLISHED USING GNSS, THE GLOBAL NAVIGATION SATELLITE SYSTEM.
3. RIGHT OF WAY MONUMENTATION ESTABLISHED 05/23/2022 TO 05/23/2022 .

STATE OF NORTH CAROLINA
DIVISION OF HIGHWAYS

TRANSPORTATION MANAGEMENT PLAN

JOHNSTON COUNTY



**LOCATION: PIPE NO. 500548 OVER REEDY PRONG
ON SR 1124 (REEDY PRONG CHURCH RD.)**

TYPE OF WORK: GRADING, DRAINAGE, & PAVING

INDEX OF SHEETS


SHEET NO.	TITLE
TMP-01	TITLE SHEET, VICINITY MAP, AND INDEX OF SHEETS
TMP-01A	LIST OF APPLICABLE ROADWAY STANDARD DRAWINGS, AND LEGEND
TMP-01B	SIGN AND DEVICE LEGEND
TMP-02	TRANSPORTATION OPERATIONS PLAN: (MANAGEMENT STRATEGIES AND GENERAL NOTES) AND PHASING
TMP-03	SPECIAL SIGN DESIGN
TMP-04	OFFSITE DETOUR

SHEET NO.
TMP-01

BP4.R028

TIP PROJECT:

**DOCUMENT NOT CONSIDERED FINAL
UNLESS ALL SIGNATURES COMPLETED**

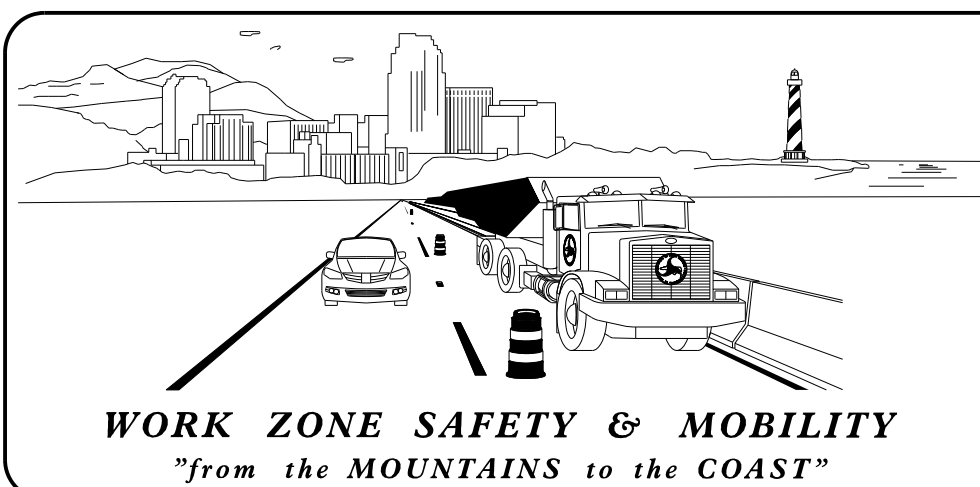


PLANS PREPARED BY:
GREG PURVIS, P.E.


D. ALLEN HAYES, E.I.

NCDOT CONTACTS:
D. A. PARKER, P.E.
PROJECT ENGINEER

SPENCER JENNINGS
PROJECT DESIGN ENGINEER

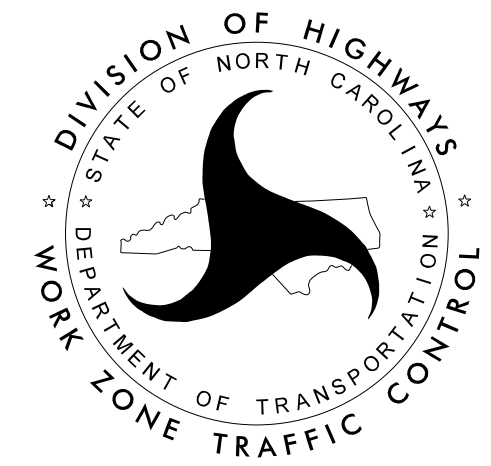


PIPE NO. 500548

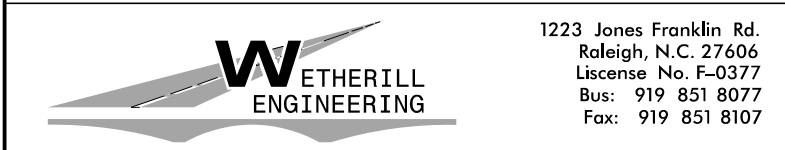

TRANSPORTATION PLANNING/DESIGN - BRIDGE/STRUCTURE DESIGN
CIVIL/SITE DESIGN - GIS/GPS - CONSTRUCTION OBSERVATION

APPROVED: *Greg S. Purvis*
DATE: 10/3/2022

SEAL

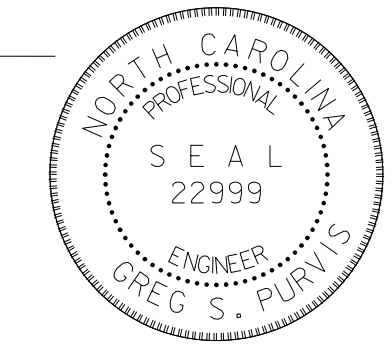

10/3/2022
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User: AHayes


ROADWAY STANDARD DRAWINGS

THE FOLLOWING ROADWAY STANDARDS AS SHOWN IN "ROADWAY STANDARD DRAWINGS" - N.C. DEPARTMENT OF TRANSPORTATION - RALEIGH, N.C., DATED JANUARY 2024 ARE APPLICABLE TO THIS PROJECT AND BY REFERENCE HEREBY ARE CONSIDERED A PART OF THESE PLANS:


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1110.01	STATIONARY WORK ZONE SIGNS
1145.01	BARRICADES

LEGEND


GENERAL

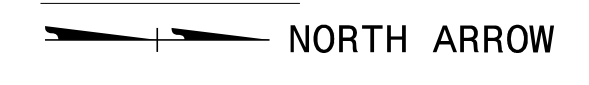

TRAFFIC CONTROL DEVICES

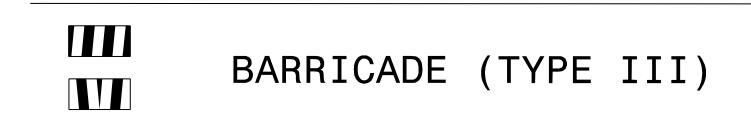


TEMPORARY SIGNING

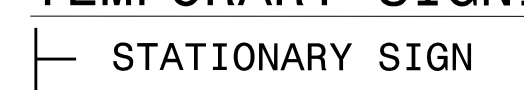


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User: AHayes


PIPE NO. 500548

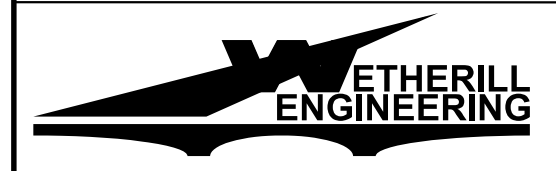


1223 Jones Franklin Rd.
Raleigh, N.C. 27606
License No. F-0377
Bus: 919 851 8077
Fax: 919 851 8107

TRANSPORTATION PLANNING/DESIGN - BRIDGE/STRUCTURE DESIGN
CIVIL/SITE DESIGN - GIS/GPS - CONSTRUCTION OBSERVATION

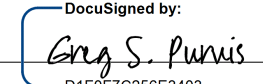APPROVED: 
DATE: 11/16/2023

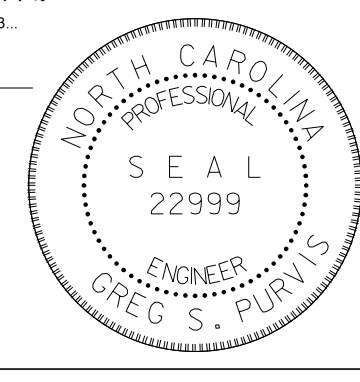

**DOCUMENT NOT CONSIDERED FINAL
UNLESS ALL SIGNATURES COMPLETED**

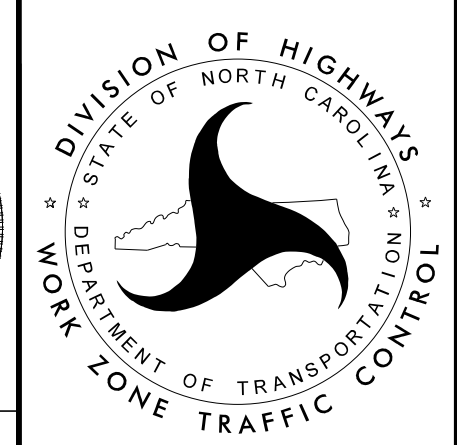

**LIST OF APPLICABLE
ROADWAY STANDARD
DRAWINGS, AND LEGEND**

10/3/2022
P:\2022\118\01_BP4_R028\Traffic\Traffic Design\Pre-Let\Plan\WZTC_BP4_R028_TMP_OIB_SDL.dgn
User: AHayes

X BARRICADES
-WITH MOUNTED SIGNING

X SIGNING
-STATIONARY MOUNTED


PIPE NO. 500548

1223 Jones Franklin Rd.
Raleigh, N.C. 27606
License No. F-0377
Bus: 919 851 8077
Fax: 919 851 8107

TRANSPORTATION PLANNING/DESIGN - BRIDGE/STRUCTURE DESIGN
CIVIL/SITE DESIGN - GIS/GPS - CONSTRUCTION OBSERVATION

APPROVED:
DATE: 10/3/2022

**DOCUMENT NOT CONSIDERED FINAL
UNLESS ALL SIGNATURES COMPLETED**

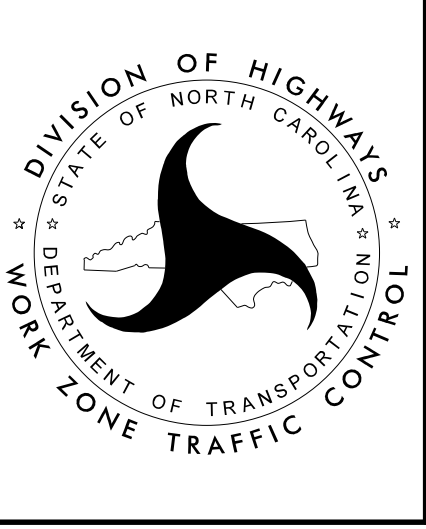

SIGN AND DEVICE LEGEND

PROJ. REFERENCE NO.	SHEET NO.
BP4.R028	TMP-02

GENERAL NOTES

CHANGES MAY BE REQUIRED WHEN PHYSICAL DIMENSIONS IN THE DETAIL DRAWINGS, STANDARD DETAILS, AND ROADWAY DETAILS ARE NOT ATTAINABLE TO MEET FIELD CONDITIONS OR RESULT IN DUPLICATE OR UNDESIRED OVERLAPPING OF DEVICES. MODIFICATION MAY INCLUDE: MOVING, SUPPLEMENTING, COVERING, OR REMOVAL OF DEVICES AS DIRECTED BY THE ENGINEER.

THE FOLLOWING GENERAL NOTES APPLY AT ALL TIMES FOR THE DURATION OF THE CONSTRUCTION PROJECT EXCEPT WHEN OTHERWISE NOTED IN THE PLAN OR DIRECTED BY THE ENGINEER.

TRAFFIC PATTERN ALTERATIONS

- A) NOTIFY THE ENGINEER THIRTY (30) CALENDAR DAYS PRIOR TO ANY TRAFFIC PATTERN ALTERATION.

SIGNING

- B) PROVIDE SIGNING AND DEVICES REQUIRED TO CLOSE THE ROAD ACCORDING TO THE ROADWAY STANDARD DRAWINGS AND TRAFFIC CONTROL PLANS.

AND

PROVIDE SIGNING REQUIRED FOR THE OFF-SITE DETOUR ROUTE AS SHOWN IN THE TRAFFIC CONTROL PLANS.

- C) COVER OR REMOVE ALL SIGNS AND DEVICES REQUIRED TO CLOSE THE ROAD WHEN ROAD CLOSURE IS NOT IN OPERATION.

AND

COVER OR REMOVE ALL SIGNS REQUIRED FOR THE OFF-SITE DETOUR WHEN THE DETOUR IS NOT IN OPERATION.

- D) ENSURE ALL NECESSARY SIGNING IS IN PLACE PRIOR TO ALTERING ANY TRAFFIC PATTERN.

TRAFFIC CONTROL DEVICES

- E) PLACE TYPE III BARRICADES, WITH "ROAD CLOSED" SIGN R11-2 ATTACHED, OF SUFFICIENT LENGTH TO CLOSE ENTIRE ROADWAY.

MANAGEMENT STRATEGIES

THE FOLLOWING LISTED WORK ZONE STRATEGIES ARE RECOMMENDED FOR INCLUSION WITHIN THIS TRANSPORTATION MANAGEMENT PLAN (TMP).

RECOMMENDED STRATEGIES:

TRAFFIC MANAGEMENT STRATEGIES:
 ONE-LANE, TWO WAY OPERATION (FLAGGING)
 OFF-SITE DETOURS

LOCAL NOTES

- 1) IN ORDER TO HAVE TIME TO ADEQUATELY REROUTE SCHOOL BUSESSES, JOHNSTON COUNTY SCHOOLS WILL BE CONTACTED AT (919) 934-6031 AT LEAST ONE MONTH PRIOR TO ROAD CLOSURE.
- 2) JOHNSTON COUNTY EMERGENCY MANAGEMENT WILL BE CONTACTED AT (919) 989-5050 LEAST ONE MONTH PRIOR TO ROAD CLOSURE TO MAKE THE NECESSARY TEMPORARY REASSIGNMENTS TO PRIMARY RESPONSE UNITS.

PHASING


- STEP 1) INSTALL ALL OFFSITE DETOUR SIGNING AND ROAD CLOSURE SIGNING. COVER SIGNS USING AN APPROVED METHOD PER THE DISCRETION OF THE ENGINEER. INSTALL SIGN ASSEMBLY "I" EVERY 0.90 MILES ON SR 1125 (TART TOWN RD) AND SR 1126 (TART RD), STARTING FROM THE BEGINNING OF EACH DIRECTION OF EACH LEG OF THE OFF-SITE DETOUR.
[SEE SHEETS TMP-01B & 04]
- STEP 2) WHEN READY TO CLOSE THE ROADWAY, UNCOVER THE DETOUR AND ROAD CLOSURE SIGNING, CLOSE -L- (SR 1124), AND DETOUR TRAFFIC.
[SEE SHEETS TMP-01B & 04]
- STEP 3) AWAY FROM TRAFFIC, REMOVE EXISTING BRIDGE, AND CONSTRUCT PROPOSED -L- STRUCTURE AND APPROACHES FROM THE BEGIN PROJECT LIMITS TO THE END PROJECT LIMITS UP TO AND INCLUDING THE FINAL LIFT OF SURFACE COURSE, AND FINAL PAVEMENT MARKINGS.
[SEE ROADWAY PLANS AND FINAL PAVEMENT MARKING PLAN]
- STEP 4) OPEN -L- TO THE FINAL TRAFFIC PATTERN, AND REMOVE ALL ROAD CLOSURE SIGNING, OFFSITE DETOUR SIGNING, TEMPORARY TRANSPORTATION MANAGEMENT DEVICES.
[SEE SHEET TMP-04 FOR SIGN LOCATIONS]


10/12/2022
 P:\2021\2118\01_BP4.R028\Traffic\Traffic Design\Pre-Let\Plan\WZTC_BP4.R028_TMP_02_GN&P.dgn
 User: AHayes

PIPE NO. 500548


WETHERILL ENGINEERING
 1223 Jones Franklin Rd.
 Raleigh, N.C. 27606
 License No. F-0377
 Bus: 919 851 8077
 Fax: 919 851 8107

TRANSPORTATION PLANNING/DESIGN - BRIDGE/STRUCTURE DESIGN
 CIVIL/SITE DESIGN - GIS/GPS - CONSTRUCTION OBSERVATION

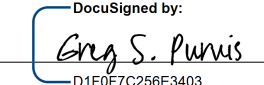APPROVED: 
 DATE: 10/12/2022

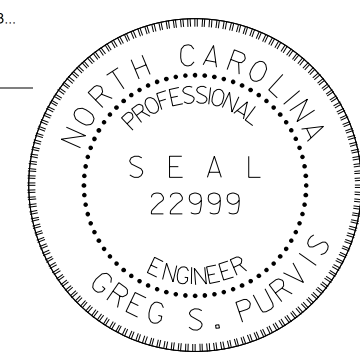

**DOCUMENT NOT CONSIDERED FINAL
 UNLESS ALL SIGNATURES COMPLETED**

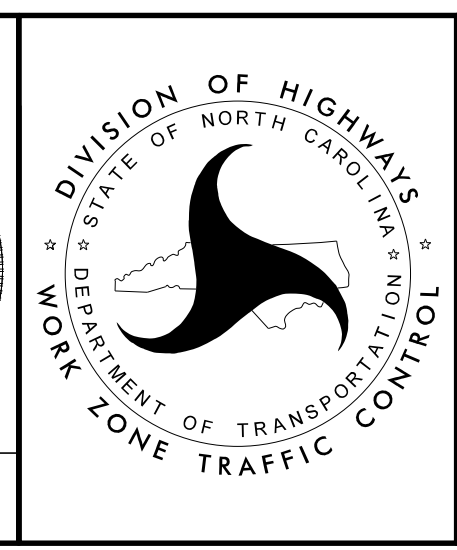

**TRANSPORTATION OPERATIONS
 PLAN: (MANAGEMENT
 STRATEGIES AND GENERAL
 NOTES) AND PHASING**

<p>SIGN NUMBER: name TYPE: STATIONARY QUANTITY: SEE PLANS SIGN WIDTH: 3'-6" HEIGHT: 4'-0" TOTAL AREA: 14.0 Sq.Ft. BORDER TYPE: INSET RECESS: 0.38" WIDTH: 0.63" RADII: 1.5" NO. Z BARS: 2 LENGTH: 34.0</p>	<p>BACKG COLOR: Fluorescent Orange COPY COLOR: Black</p> <table border="1"> <tr> <th>SYMBOL</th> <th>X</th> <th>Y</th> <th>WID</th> <th>HT</th> </tr> <tr><td> </td><td> </td><td> </td><td> </td><td> </td></tr> <tr><td> </td><td> </td><td> </td><td> </td><td> </td></tr> <tr><td> </td><td> </td><td> </td><td> </td><td> </td></tr> <tr><td> </td><td> </td><td> </td><td> </td><td> </td></tr> <tr><td> </td><td> </td><td> </td><td> </td><td> </td></tr> <tr><td> </td><td> </td><td> </td><td> </td><td> </td></tr> <tr><td> </td><td> </td><td> </td><td> </td><td> </td></tr> <tr><td> </td><td> </td><td> </td><td> </td><td> </td></tr> <tr><td> </td><td> </td><td> </td><td> </td><td> </td></tr> </table> <p>MAT'L: 0.080" (2.0 mm) ALUMINUM</p>	SYMBOL	X	Y	WID	HT																																														<p>DESIGN BY: DAH PROJECT ID: BP4.R028</p> <p>CHECKED BY: WEI LOCATION: OFFSITE DETOUR</p> <p>Sep 22, 2022 DIV: 4</p>
SYMBOL	X	Y	WID	HT																																																

Spacing Factor is 1 unless specified otherwise





LETTER POSITIONS



Letter locations are panel edge to lower left corner

	R	E	E	D	Y																	Series/Size Text Length	
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																						20.5	
																							C 2000
	9.8	14.3	18.6	23.3	27.9																	21.5	
																							C 2000
	7.4	12	16.7	21.4	25.6	30.2																26.1	
																							C 2000
	12.2	16.5	20.7	25.4																		16.6	

FILENAME: BP4.R028_REF_BSSD NORTH CAROLINA D.O.T. SIGN DETAIL

10/3/2022
 P:\2021\2118\01_BP4.R028\Traffic\Traffic Design\Pre-Let\Plan\WZTC\BP4.R028.TMP_03_SSD.dgn
 User: AHayes
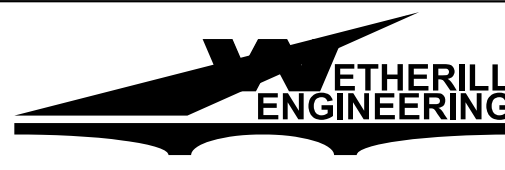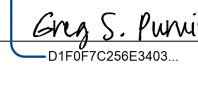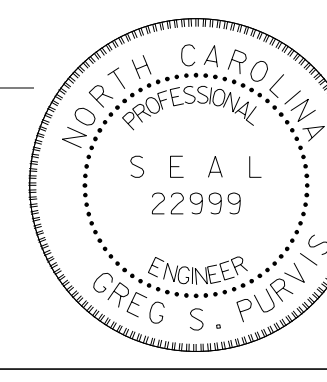
<p style="text-align: center;">PIPE NO. 500548</p>  <p style="font-size: small;"> 1223 Jones Franklin Rd. Raleigh, N.C. 27606 License No. F-0377 Bus: 919 851 8077 Fax: 919 851 8107 </p> <p style="font-size: x-small;"> TRANSPORTATION PLANNING/DESIGN - BRIDGE/STRUCTURE DESIGN CIVIL/SITE DESIGN - GIS/GPS - CONSTRUCTION OBSERVATION </p>	<p>APPROVED: </p> <p>DATE: 10/3/2022</p> 	 <p style="font-size: small;"> DIVISION OF HIGHWAYS DEPARTMENT OF TRANSPORTATION WORK ZONE TRAFFIC CONTROL </p>	<p>SPECIAL SIGN DESIGN</p>
<p>DOCUMENT NOT CONSIDERED FINAL UNLESS ALL SIGNATURES COMPLETED</p>			

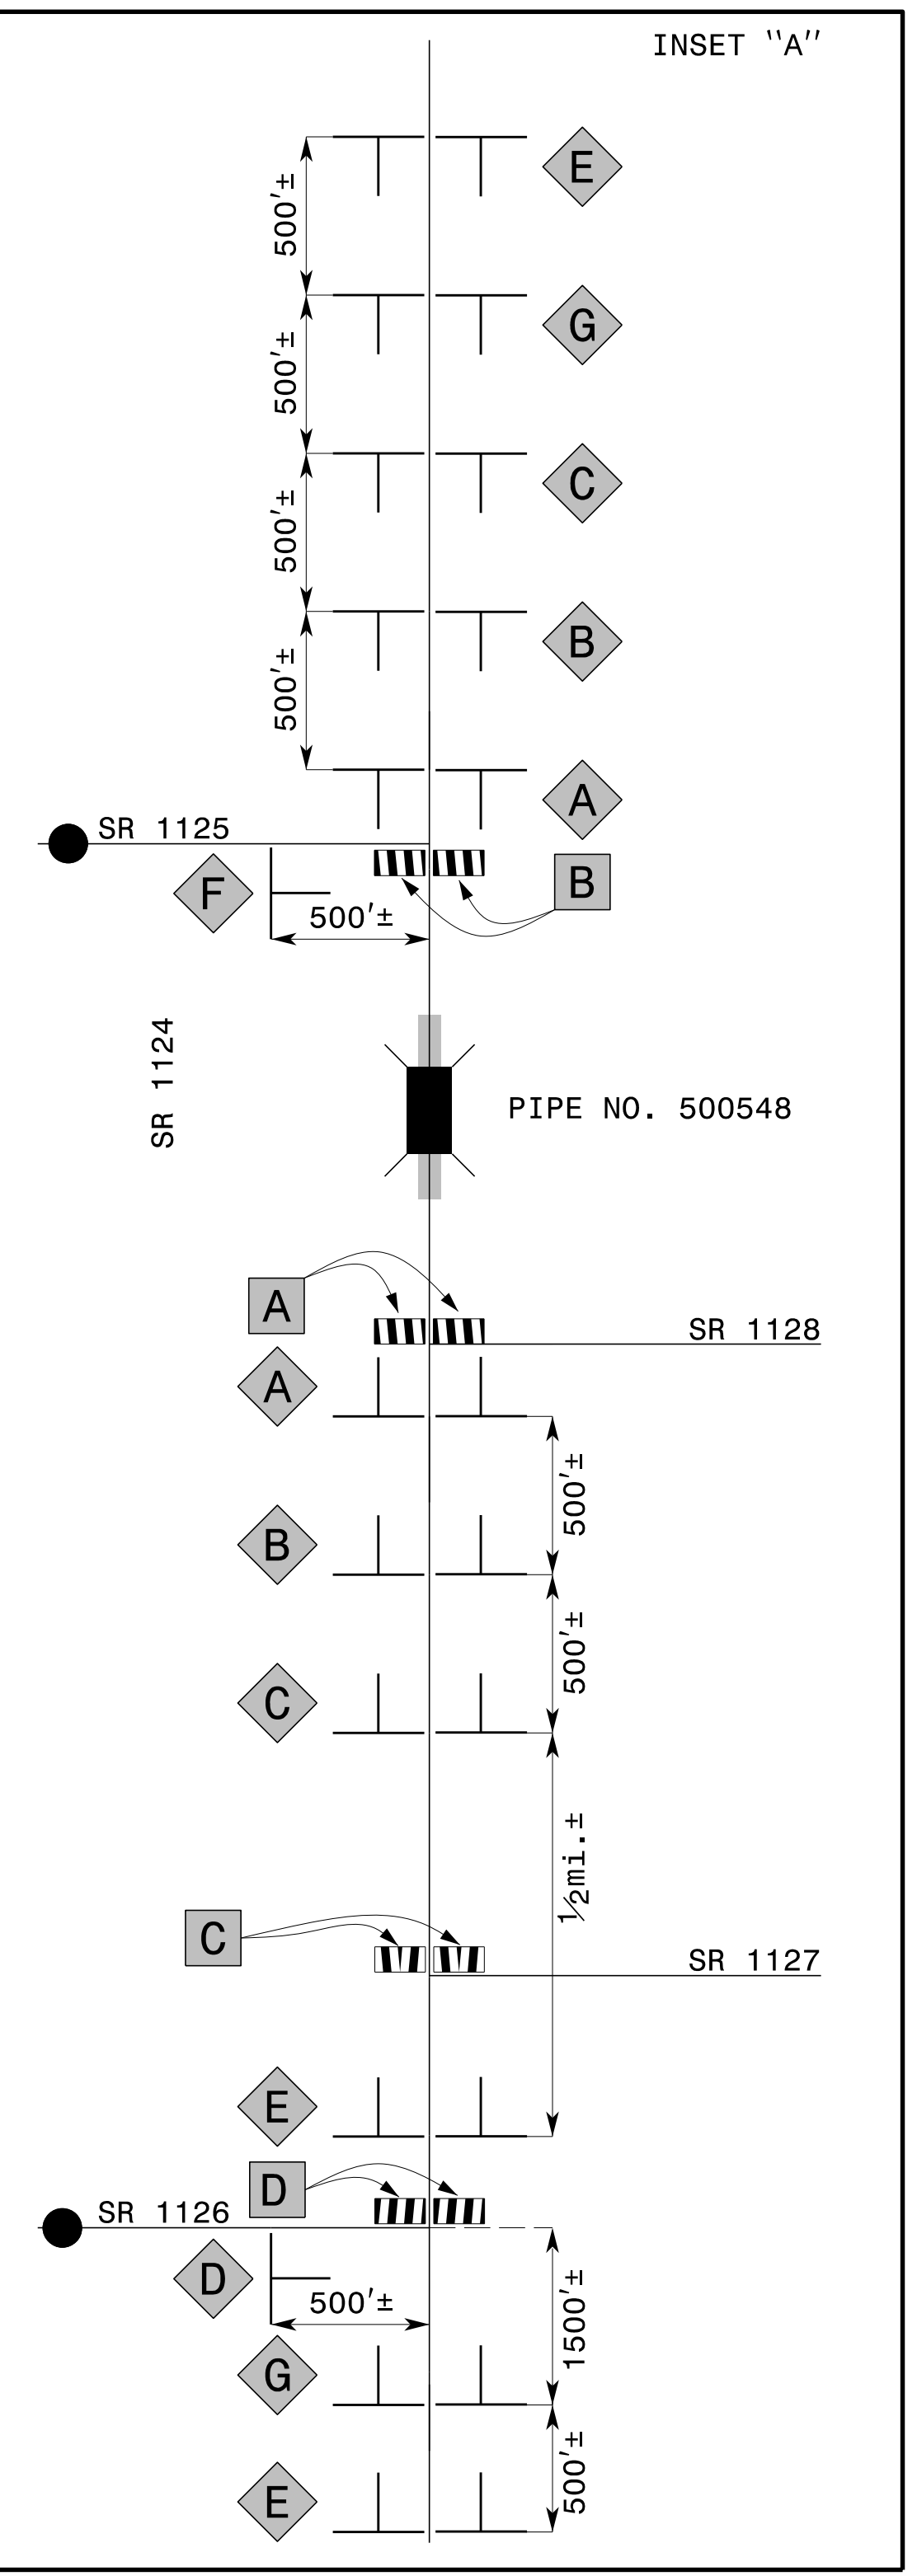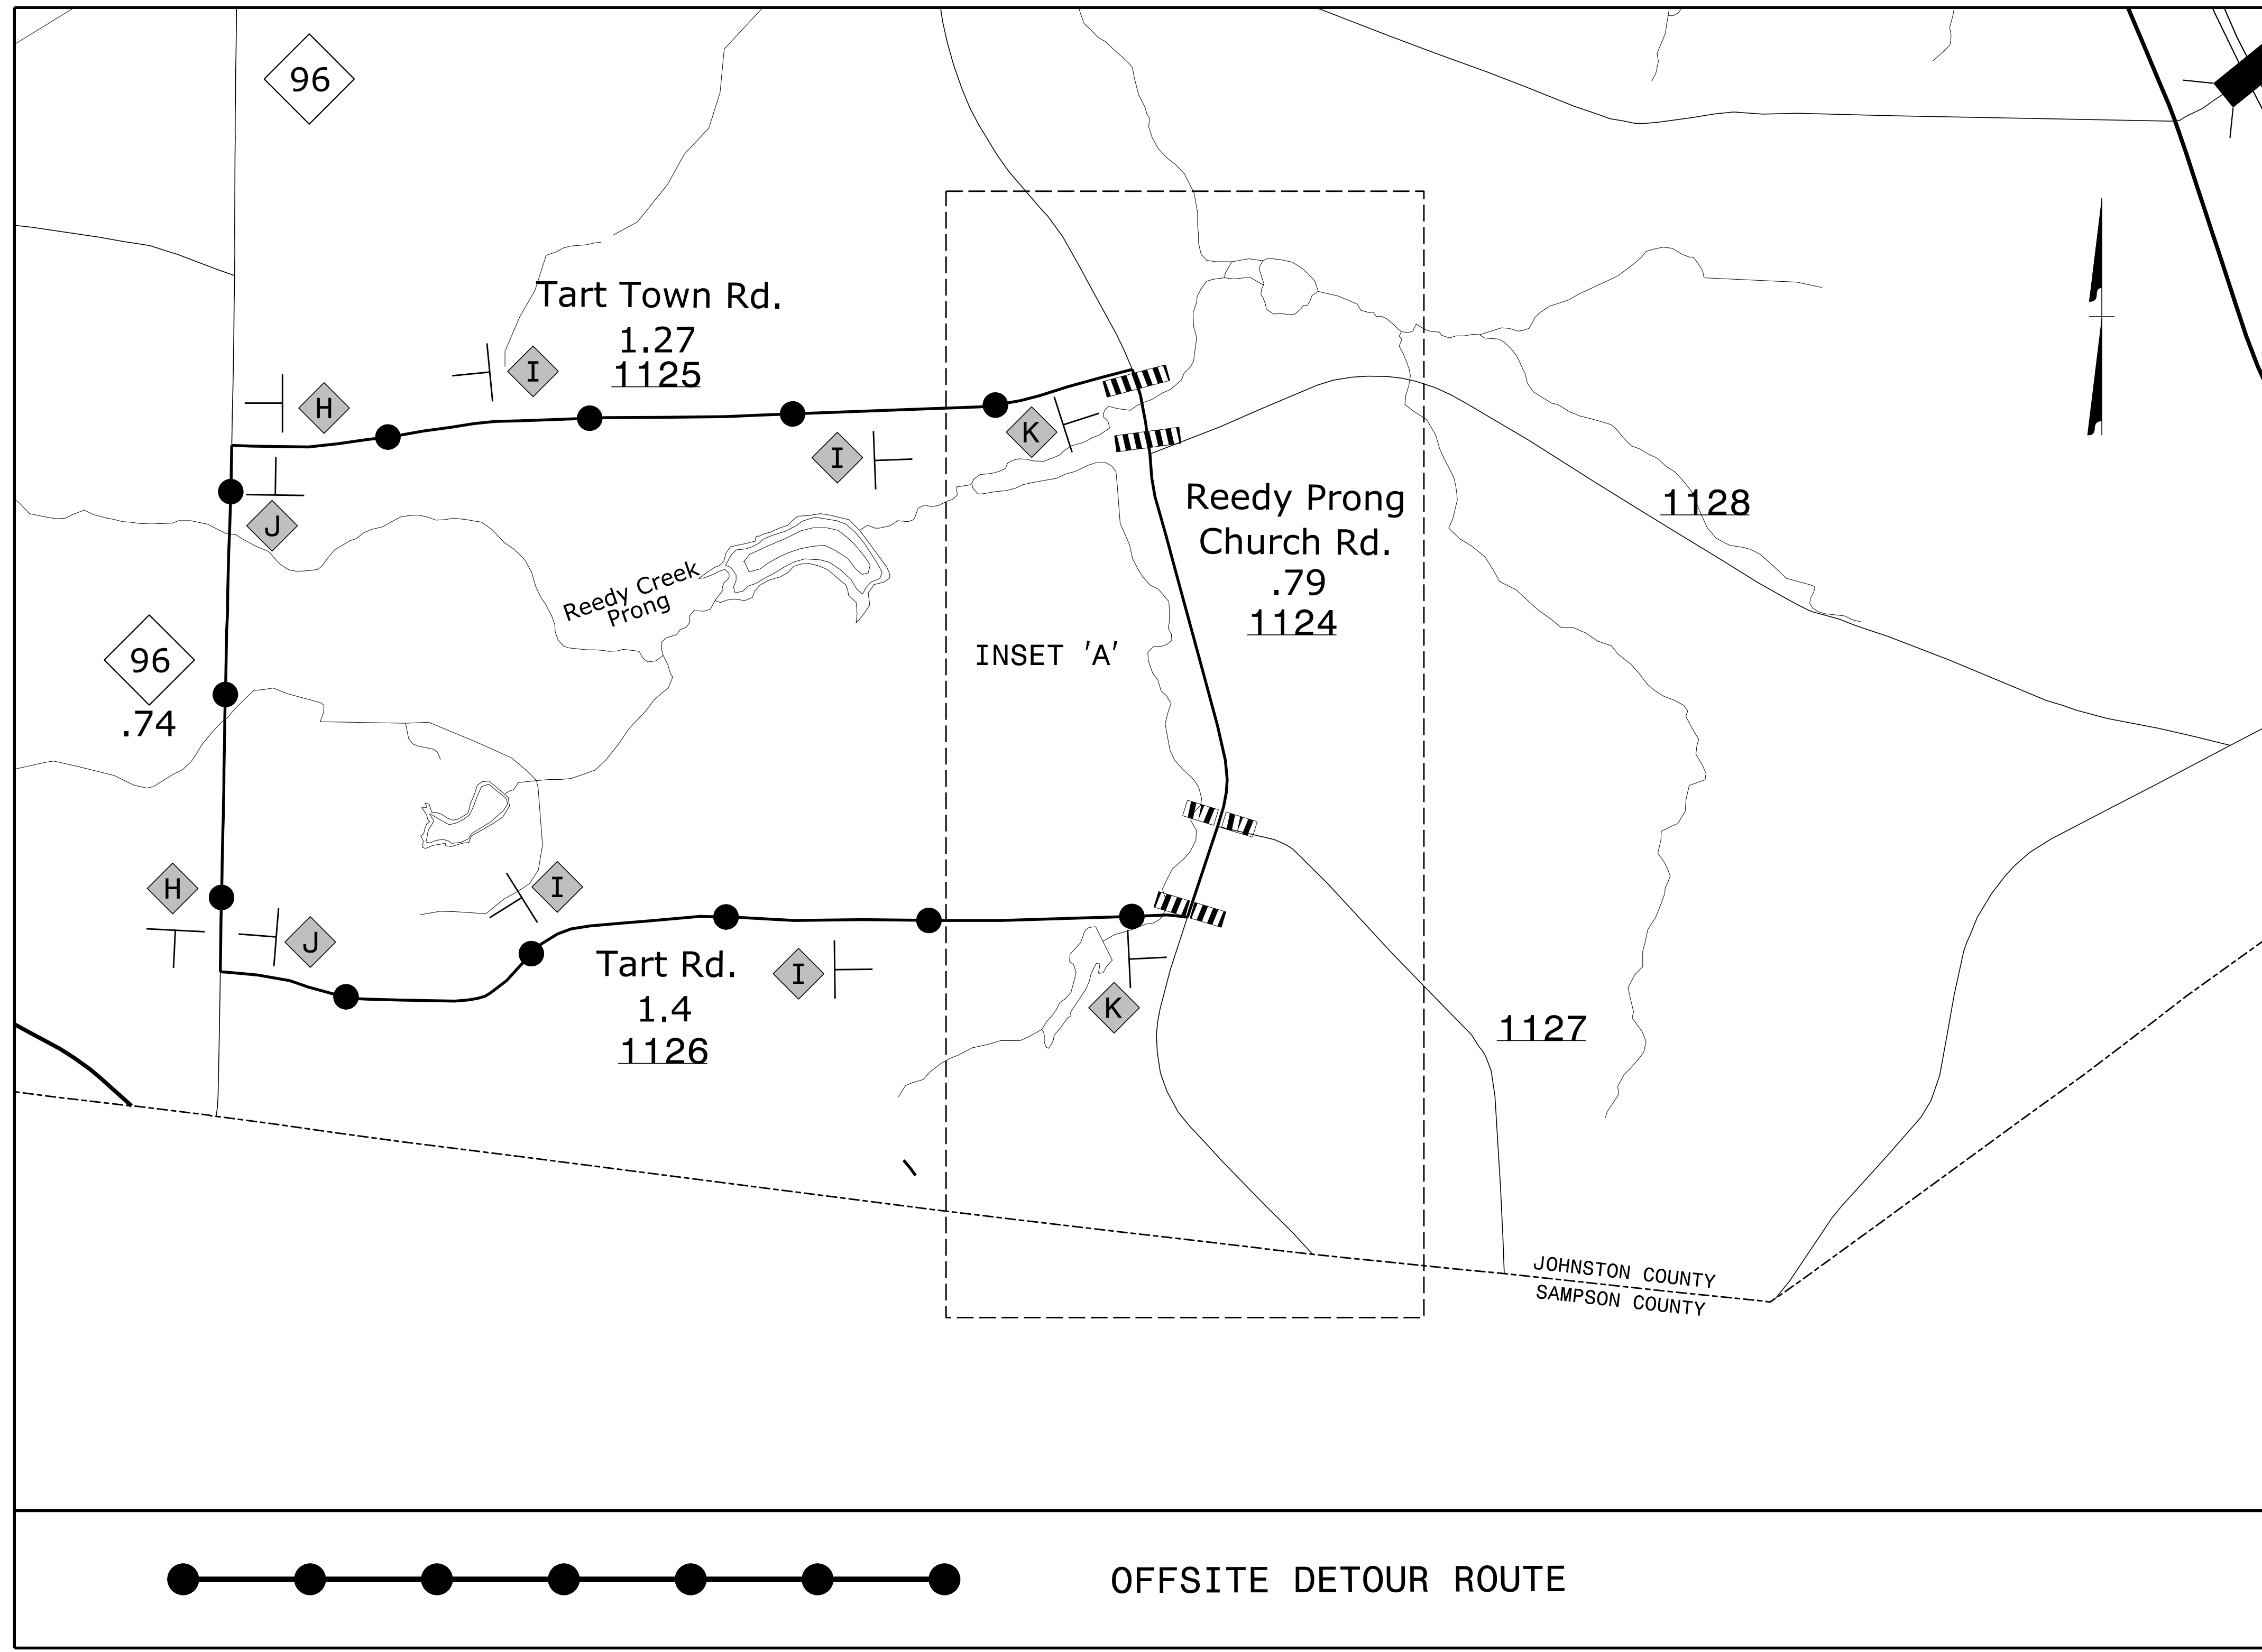

10/12/2022
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 User: AHayes

- NOTES:**
- 1) REFER TO SHEET TMP-01B FOR SIGN AND DEVICE LEGEND.
 - 2) FOR INSET "A", REFER TO ROADWAY STANDARD DRAWINGS 1101.03, SHEETS 1 & 2 OF 9 FOR APPLICABLE NOTES.

PIPE NO. 500548


1223 Jones Franklin Rd.
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TRANSPORTATION PLANNING/DESIGN - BRIDGE/STRUCTURE DESIGN
 CIVIL/SITE DESIGN - GIS/GPS - CONSTRUCTION OBSERVATION



APPROVED:
DocuSigned by:
Greg S. Purvis
01F07C26E3403

DATE: 10/12/2022

DOCUMENT NOT CONSIDERED FINAL
UNLESS ALL SIGNATURES COMPLETED

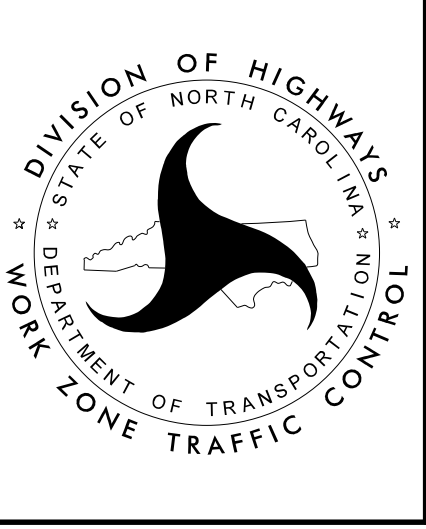

OFFSITE DETOUR

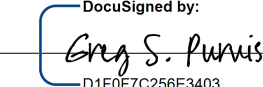TIP NO. BP4 . R028	SHEET NO. PMP - 01
APPROVED:  DATE: 1/5/2024	
SEAL 	
DOCUMENT NOT CONSIDERED FINAL UNLESS ALL SIGNATURES COMPLETED	

STATE OF NORTH CAROLINA
DEPARTMENT OF TRANSPORTATION

PAVEMENT MARKING PLAN
JOHNSTON COUNTY

T.I.P.: BP4.R028

INDEX

SHEET NO.	DESCRIPTION
PMP-01	PAVEMENT MARKING PLAN TITLE AND SCHEDULE SHEET
PMP-02	PAVEMENT MARKING DETAIL

ROADWAY STANDARD DRAWING

THE FOLLOWING ROADWAY STANDARDS AS APPEAR IN "ROADWAY STANDARD DRAWINGS" - PROJECT SERVICES UNIT - N.C. DEPARTMENT OF TRANSPORTATION - RALEIGH, N.C., DATED JANUARY 2024 ARE APPLICABLE TO THIS PROJECT AND BY REFERENCE HEREBY ARE CONSIDERED A PART OF THESE PLANS:

STD. NO.	TITLE
1205.01	PAVEMENT MARKINGS - LINE TYPES AND OFFSETS
1205.02	PAVEMENT MARKINGS - TWO-LANE AND MULTILANE ROADWAYS
1205.12	PAVEMENT MARKINGS - BRIDGES
1261.01	GUARDRAIL AND BARRIER DELINEATORS - INSTALLATION SPACING
1261.02	GUARDRAIL AND BARRIER DELINEATORS - TYPES AND MOUNTING
1262.01	GUARDRAIL END DELINEATION

GENERAL NOTES

THE FOLLOWING GENERAL NOTES APPLY AT ALL TIMES FOR THE DURATION OF THE CONSTRUCTION PROJECT, EXCEPT WHEN OTHERWISE NOTED IN THE PLAN, OR DIRECTED BY THE ENGINEER.

- A) INSTALL PAVEMENT MARKINGS AND PAVEMENT MARKERS ON THE FINAL SURFACE AS FOLLOWS:


ROAD NAME	MARKING	MARKER
SR 1928	THERMOPLASTIC	NONE
- B) TIE PROPOSED PAVEMENT MARKING LINES TO EXISTING PAVEMENT MARKING LINES.
- C) REMOVE/REPLACE ANY CONFLICTING/DAMAGED PAVEMENT MARKINGS AND MARKERS.
- D) PASSING ZONES WILL BE DETERMINED IN THE FIELD AND MUST BE APPROVED BY THE ENGINEER.
- E) ALL STATIONS ARE CONSIDERED +/- UNLESS OTHERWISE SHOWN ON THE PLANS.

FINAL PAVEMENT MARKING SCHEDULE

SYMBOL	DESCRIPTION	PAY ITEM
T1	WHITE SOLID EDGE LINE	THERMOPLASTIC (4", 90 MIL)
T13	YELLOW DOUBLE CENTER	THERMOPLASTIC (4", 90 MIL)

PLAN SUBMITTED TO:

Ayman I. Alqudwah, P.E., Signing and Delineation Regional Engineer

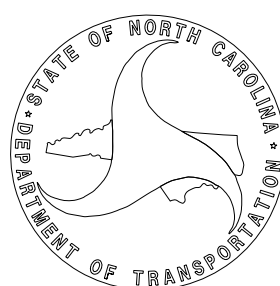



PLAN PREPARED BY: Wetherill Engineering, Inc.


GREG PURVIS, P.E. PROJECT MANAGER
D. ALLEN HAYES, E.I. TRAFFIC DESIGN ENGINEER

PIPE NO. 500548



TRANSPORTATION PLANNING/DESIGN - BRIDGE/STRUCTURE DESIGN
CNIL/SITE DESIGN - GIS/GPS - CONSTRUCTION OBSERVATION

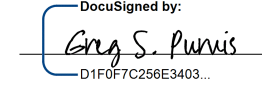TIP NO. BP4 . R028	SHEET NO. PMP - 02
APPROVED:  <small>DESIGNED BY: Greg S. Purvis</small> <small>DATE: 10/3/2022</small>	
SEAL 	
DOCUMENT NOT CONSIDERED FINAL UNLESS ALL SIGNATURES COMPLETED	
PIPE NO. 500548	

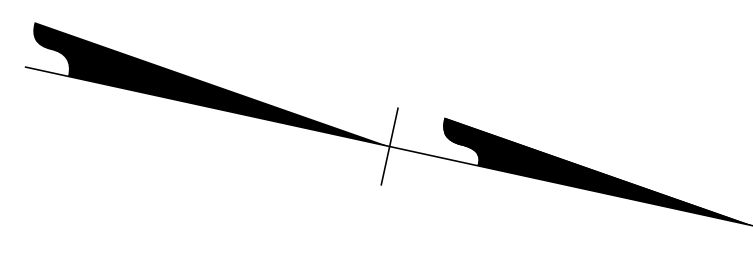


BEGIN FINAL PAVEMENT MARKINGS
-
TIE TO EXISTING


END FINAL PAVEMENT MARKINGS
-
TIE TO EXISTING

15 SR 1124 (REEDY PRONG CHURCH ROAD)

20 - L -

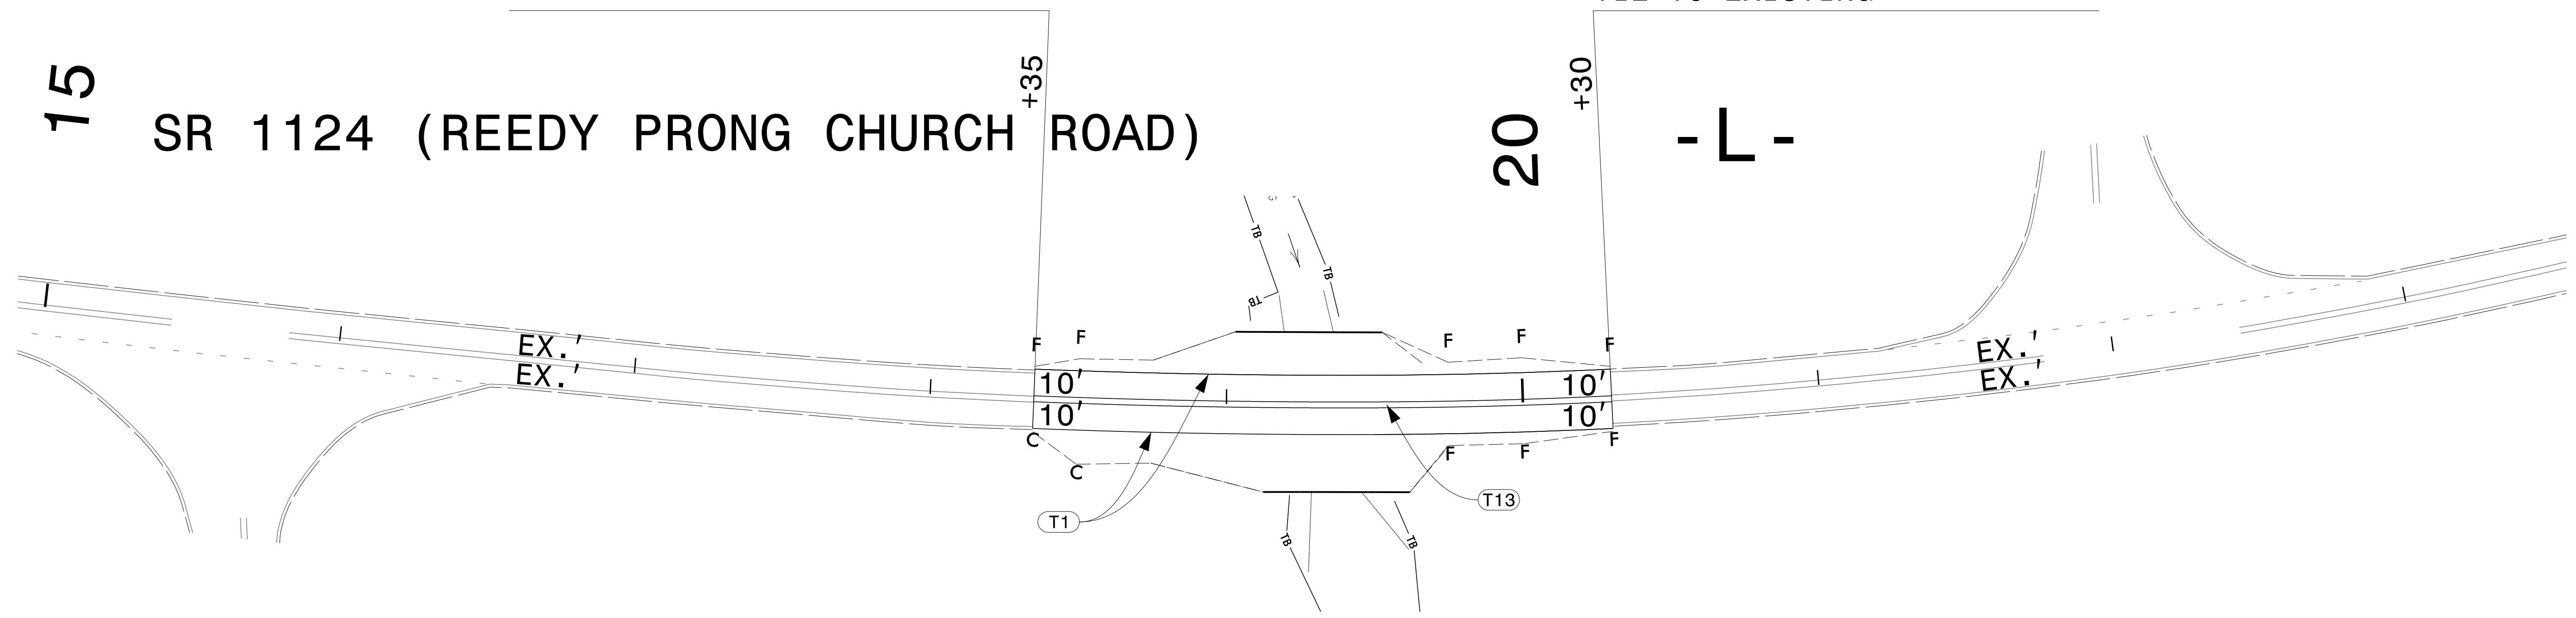

10/3/2022
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 User: Ahayes

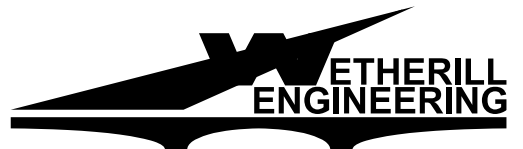


1223 Jones Franklin Rd.
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TRANSPORTATION PLANNING/DESIGN - BRIDGE/STRUCTURE DESIGN
 CIVIL/SITE DESIGN - GIS/GPS - CONSTRUCTION OBSERVATION

PAVEMENT MARKING DETAIL

PROJECT: BP4.R028


See Sheet 1A For Index of Sheets
See Sheet 1B For Conventional Symbols

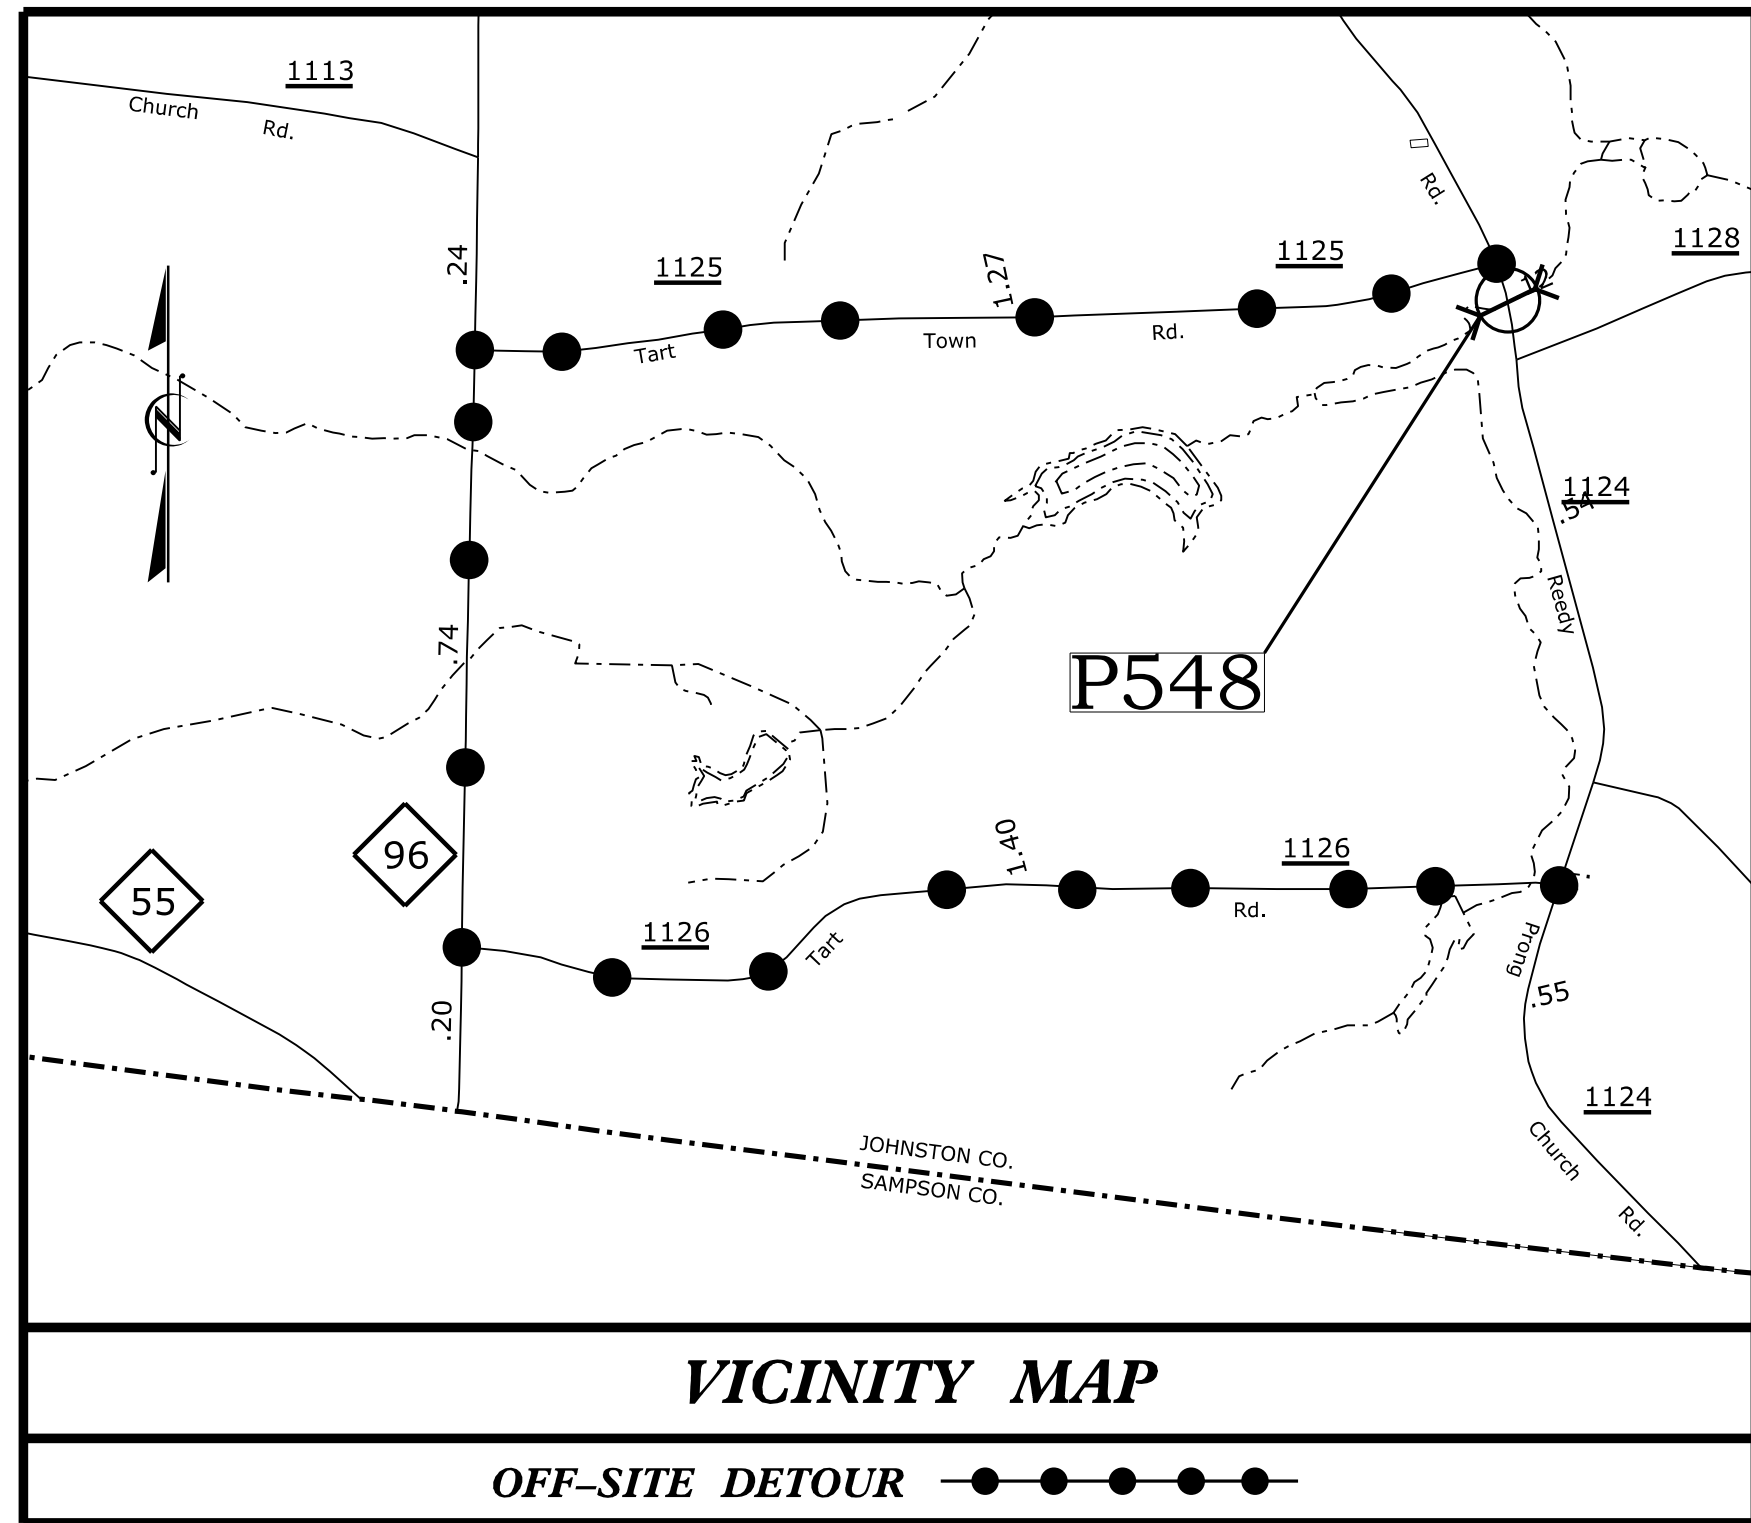

STATE OF NORTH CAROLINA DIVISION OF HIGHWAYS PLAN FOR PROPOSED HIGHWAY EROSION CONTROL JOHNSTON COUNTY

PIPE NO. 500548 OVER REEDY PRONG
ON SR 1124 (REEDY PRONG CHURCH RD.)

PIPE NO. 500548

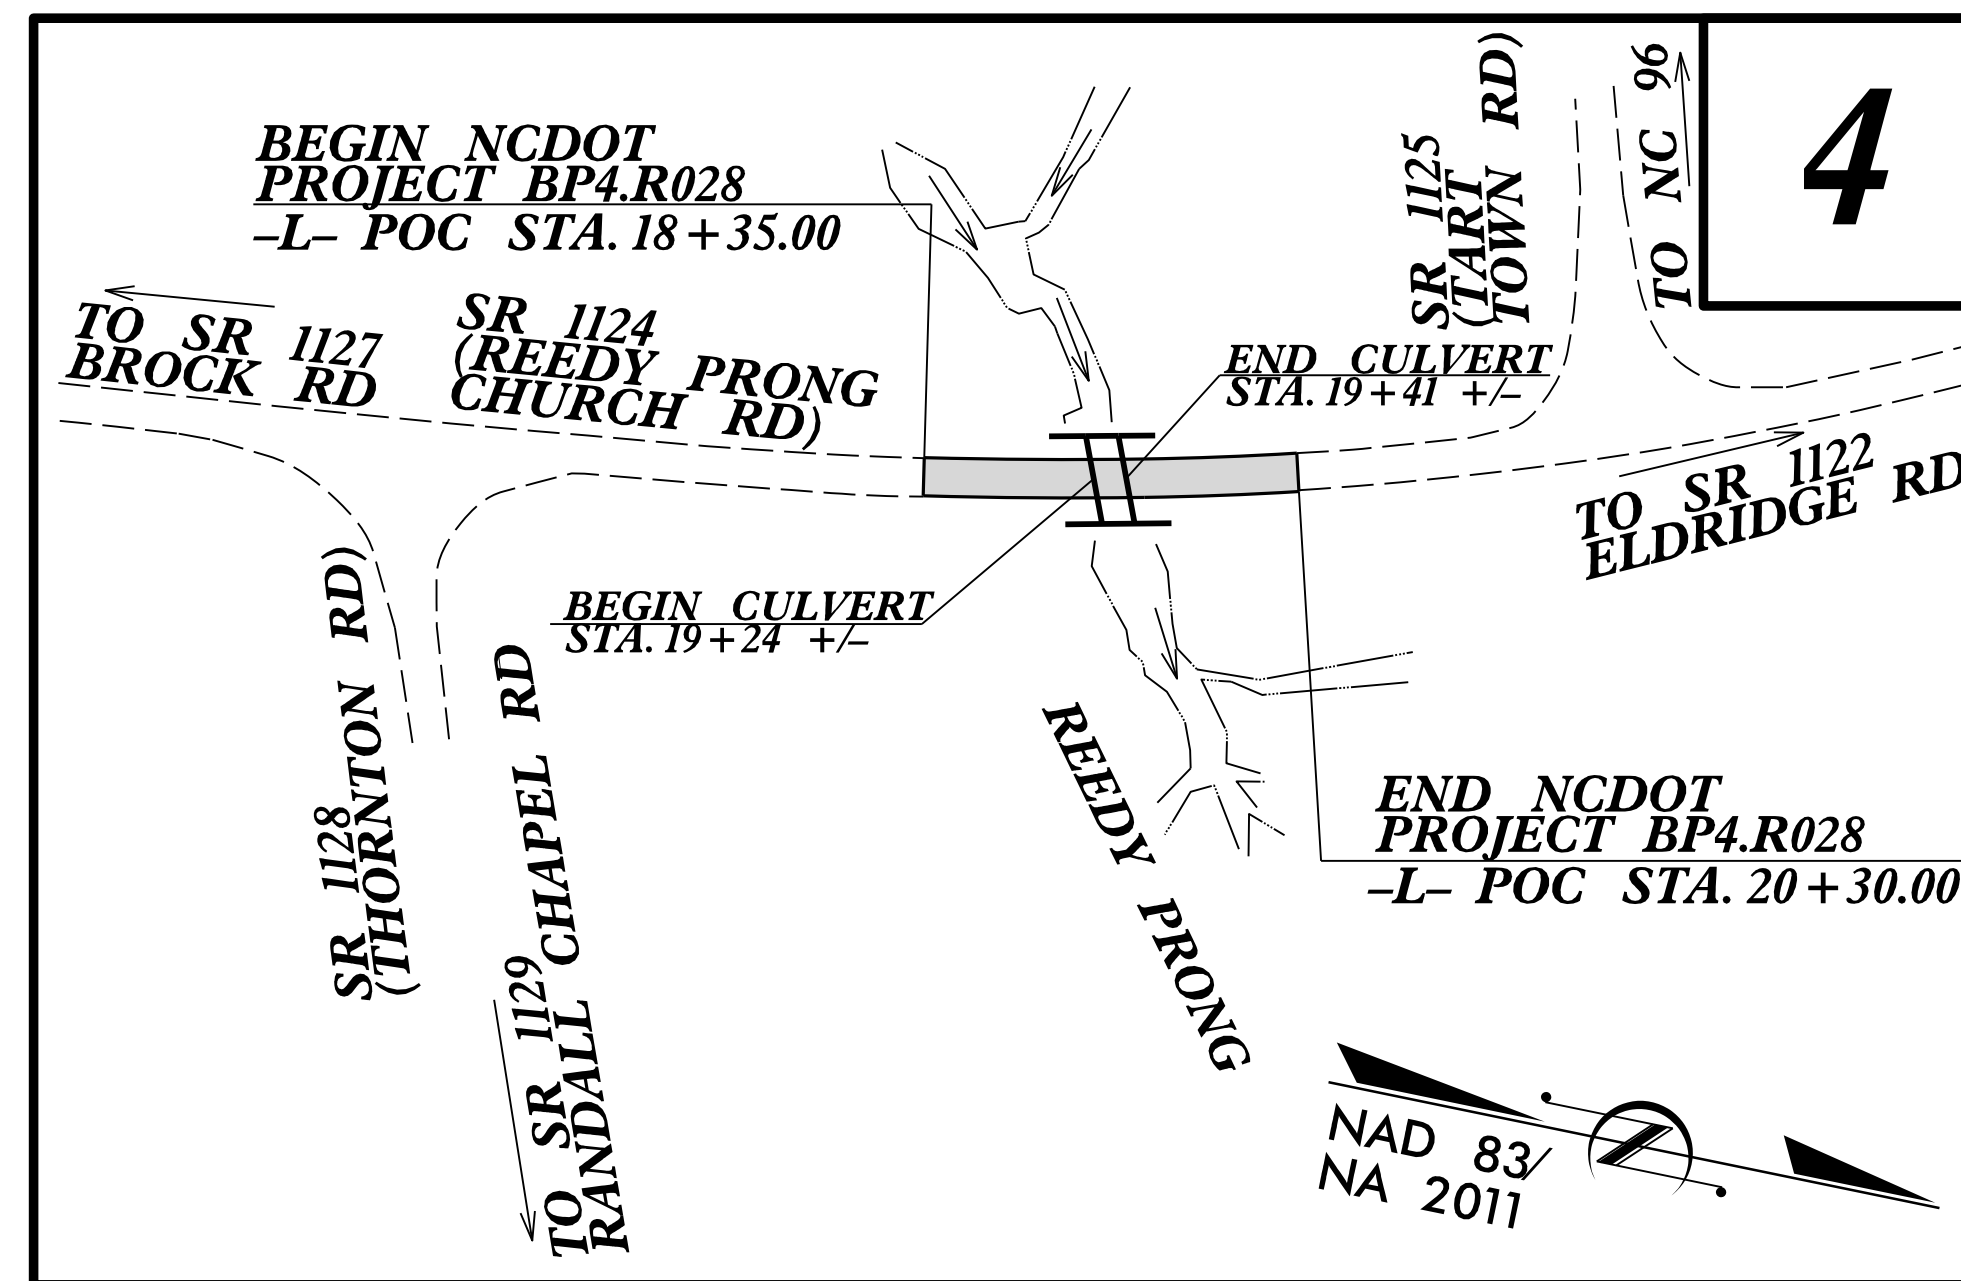


STATE	STATE PROJECT REFERENCE NO.	SHEET NO.	TOTAL SHEETS
N.C.	BP4.R028	EC-1	
STATE PROJ. NO.	F.A. PROJ. NO.	DESCRIPTION	


THIS PROJECT CONTAINS EROSION CONTROL PLANS FOR CLEARING AND GRUBBING PHASE OF CONSTRUCTION.

THIS PROJECT HAS BEEN DESIGNED TO SENSITIVE WATERSHED STANDARDS.

ENVIRONMENTALLY SENSITIVE AREA(S) EXIST ON THIS PROJECT
Refer To E. C. Special Provisions for Special Considerations.

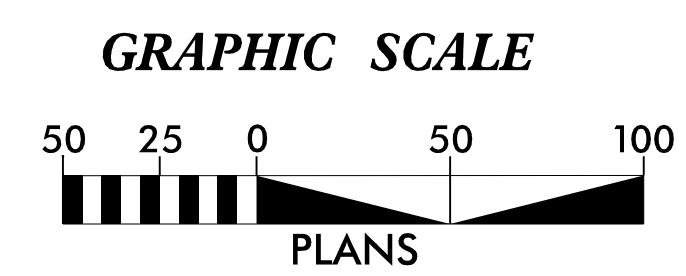

THESE EROSION AND SEDIMENT CONTROL PLANS COMPLY WITH THE APPLICABLE REGULATIONS SET FORTH BY THE NCG-010000 GENERAL CONSTRUCTION PERMIT EFFECTIVE APRIL 1, 2019 AND ISSUED BY THE NORTH CAROLINA DEPARTMENT OF ENVIRONMENTAL QUALITY DIVISION OF WATER RESOURCES.

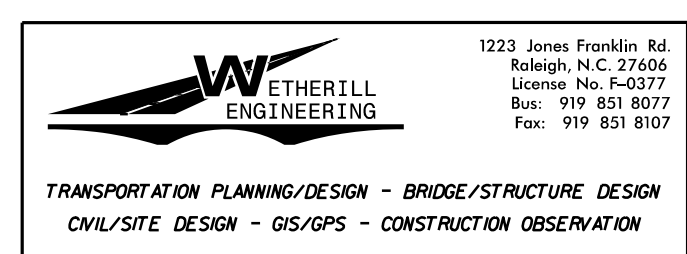

Prepared In the Office of:
WETHERILL ENGINEERING, INC.
1223 JONES FRANKLIN ROAD
RALEIGH, NC 27606

Designed by:
Matthew Harvey 3487
NAME LEVEL III CERTIFICATION NO.

Roadway Standard Drawings
The "Roadway Standard Drawings"- Roadway Design Unit - N. C. Department of Transportation - Raleigh, N. C., dated January 2024 and the latest revision thereto are applicable to this project and by reference hereby are considered a part of these plans.

DIVISION OF HIGHWAYS STATE OF NORTH CAROLINA




PROJECT REFERENCE NO. BP4.R028	SHEET NO. EC-02
ROADWAY DESIGN ENGINEER	HYDRAULICS ENGINEER

EROSION & SEDIMENT CONTROL LEGEND

Std. #	Description	Symbol	Std. #	Description	Symbol
1605.01	Temporary Silt Fence		1633.01	Temporary Rock Silt Check Type A	
1606.01	Special Sediment Control Fence		1633.02	Temporary Rock Silt Check Type B	
1622.01	Temporary Berms and Slope Drains		1633.03	Temporary Rock Silt Check Type A with Excelsior Matting and Flocculant	
1630.02	Silt Basin Type B		1634.01	Temporary Rock Sediment Dam Type A	
1630.03	Temporary Silt Ditch		1634.02	Temporary Rock Sediment Dam Type B	
1630.04	Stilling Basin		1635.01	Rock Pipe Inlet Sediment Trap Type A	
1630.05	Temporary Diversion		1635.02	Rock Pipe Inlet Sediment Trap Type B	
1630.06	Special Stilling Basin		1636.01	Excelsior Wattle Check	
1630.07	Skimmer Basin		1636.01	Excelsior Wattle Check with Flocculant	
1630.08	Tiered Skimmer Basin		1636.01	Coir Fiber Wattle Check	
1630.09	Earthen Dam with Skimmer		1636.01	Coir Fiber Wattle Check with Flocculant	
	Infiltration Basin		1636.02	Silt Fence Excelsior Wattle Break	
	Rock Inlet Sediment Trap:			Silt Fence Coir Fiber Wattle Break	
1632.01	Type A		1636.03	Excelsior Wattle Barrier	
1632.02	Type B		1636.03	Coir Fiber Wattle Barrier	
1632.03	Type C				




PROJECT REFERENCE NO. <i>BP4.R028</i>	SHEET NO. <i>EC-2A</i>
R/W SHEET NO.	
ROADWAY DESIGN ENGINEER	HYDRAULICS ENGINEER

ONSITE CONCRETE WASHOUT STRUCTURE WITH LINER

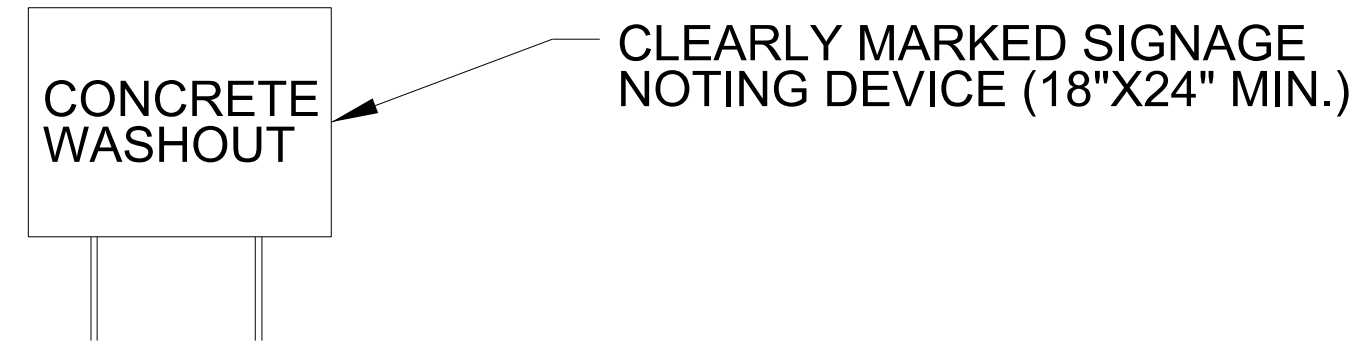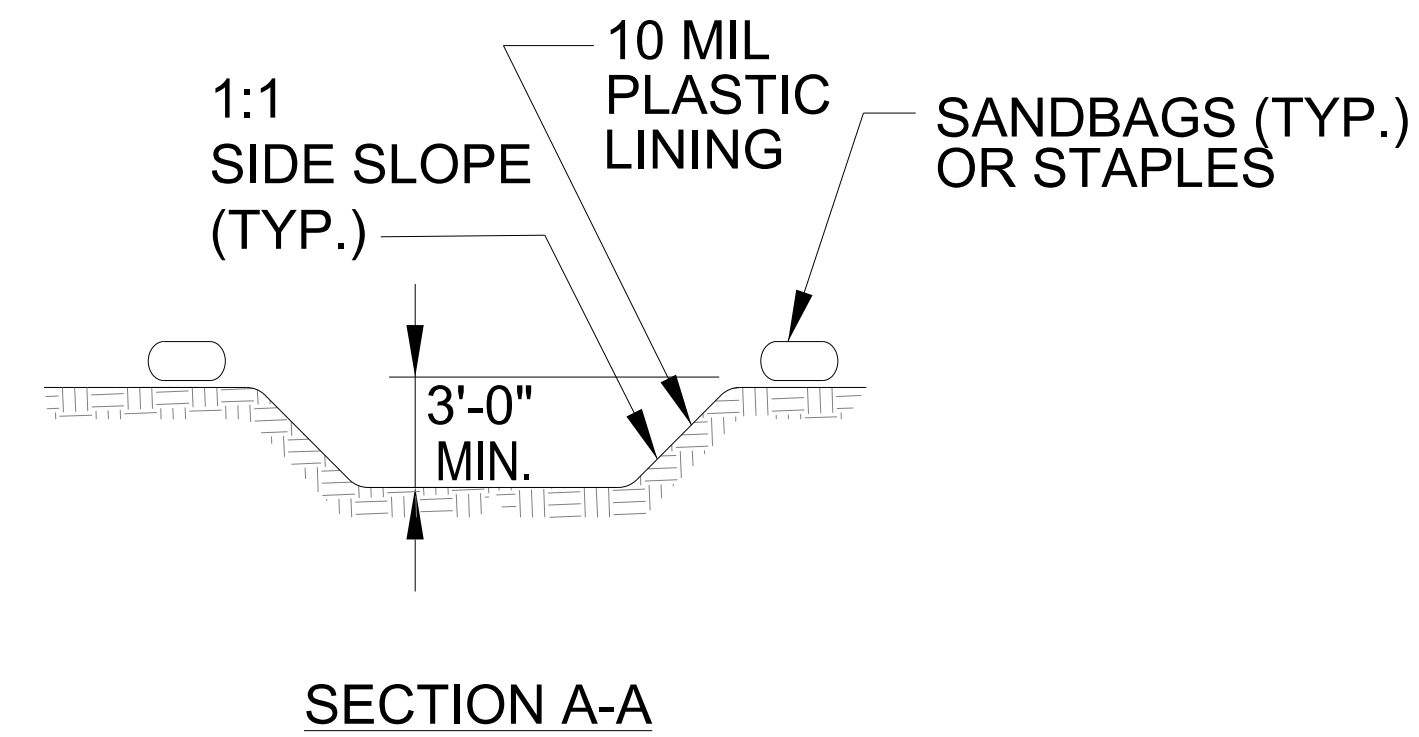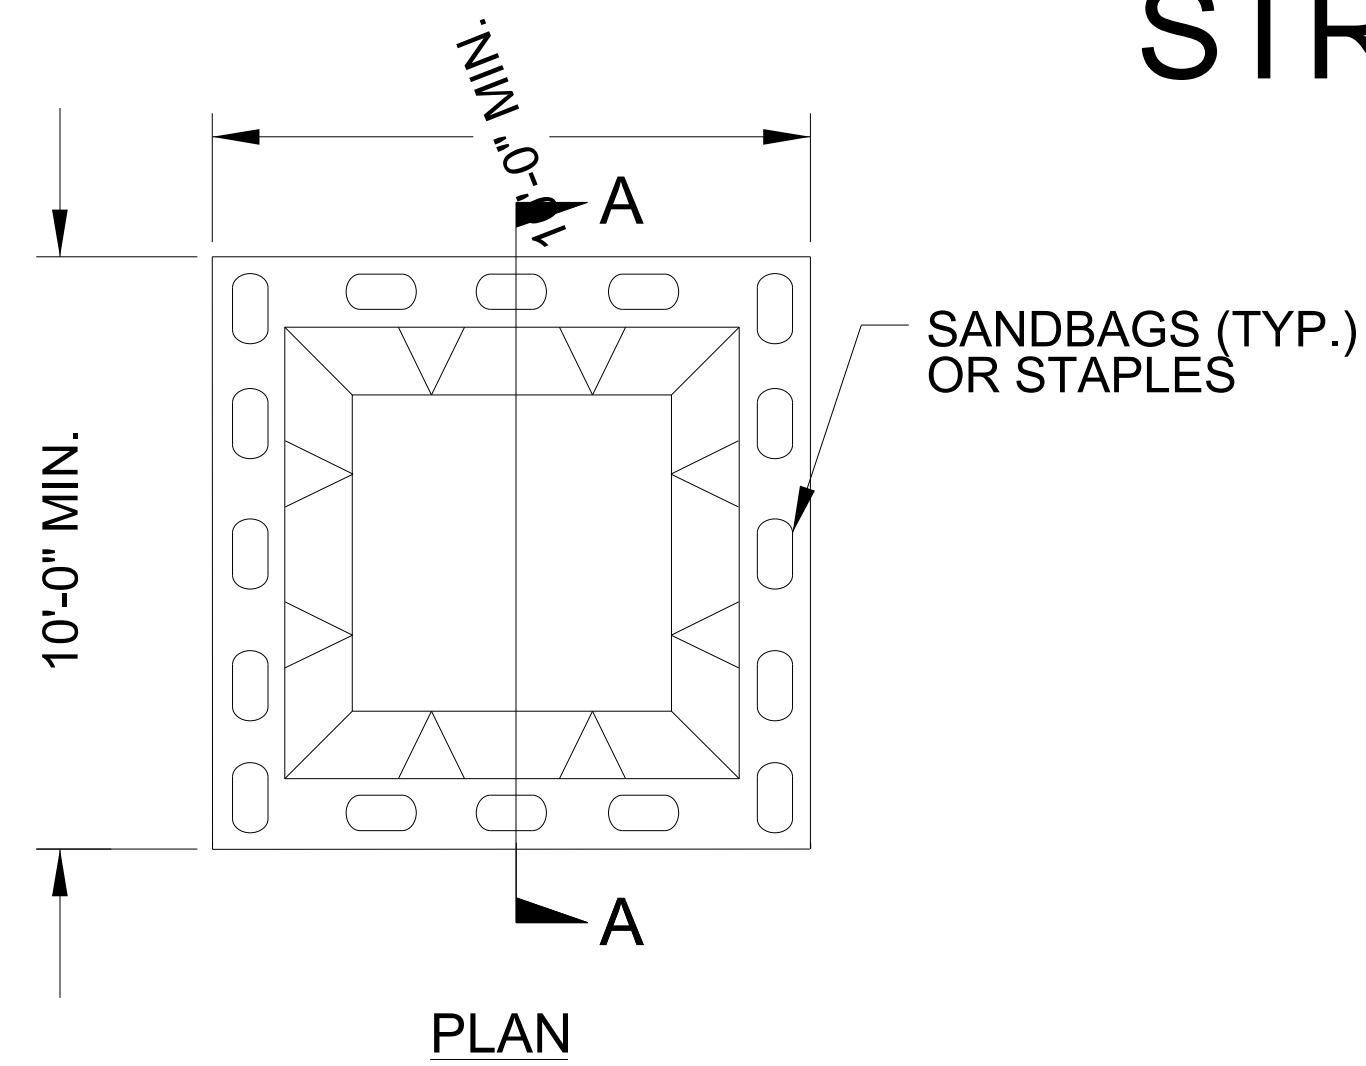

BELOW GRADE WASHOUT STRUCTURE
NOT TO SCALE

- NOTES:
1. ACTUAL LOCATION DETERMINED IN FIELD
 2. THE CONCRETE WASHOUT STRUCTURES SHALL BE MAINTAINED WHEN THE LIQUID AND/OR SOLID REACHES 75% OF THE STRUCTURES CAPACITY TO PROVIDE ADEQUATE HOLDING CAPACITY WITH A MINIMUM 12 INCHES OF FREEBOARD.
 3. CONCRETE WASHOUT STRUCTURE NEEDS TO BE CLEARLY MARKED WITH SIGNAGE NOTING DEVICE.

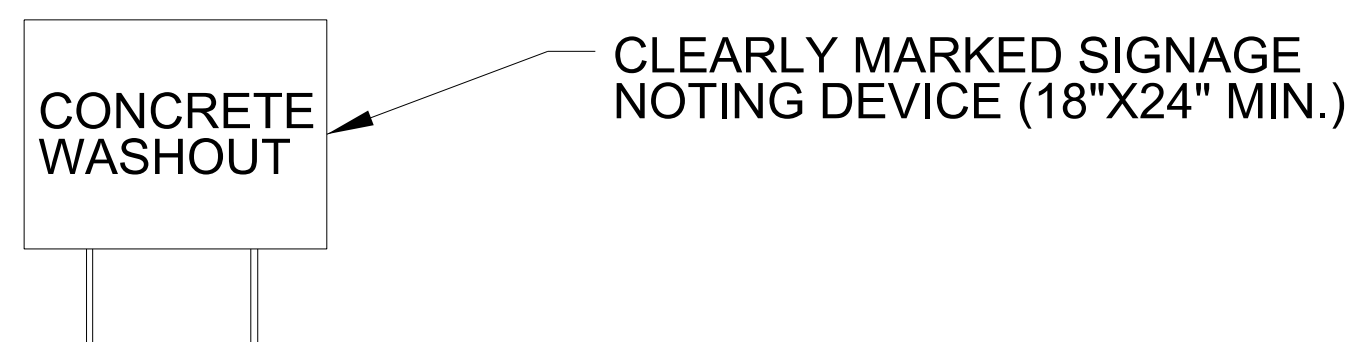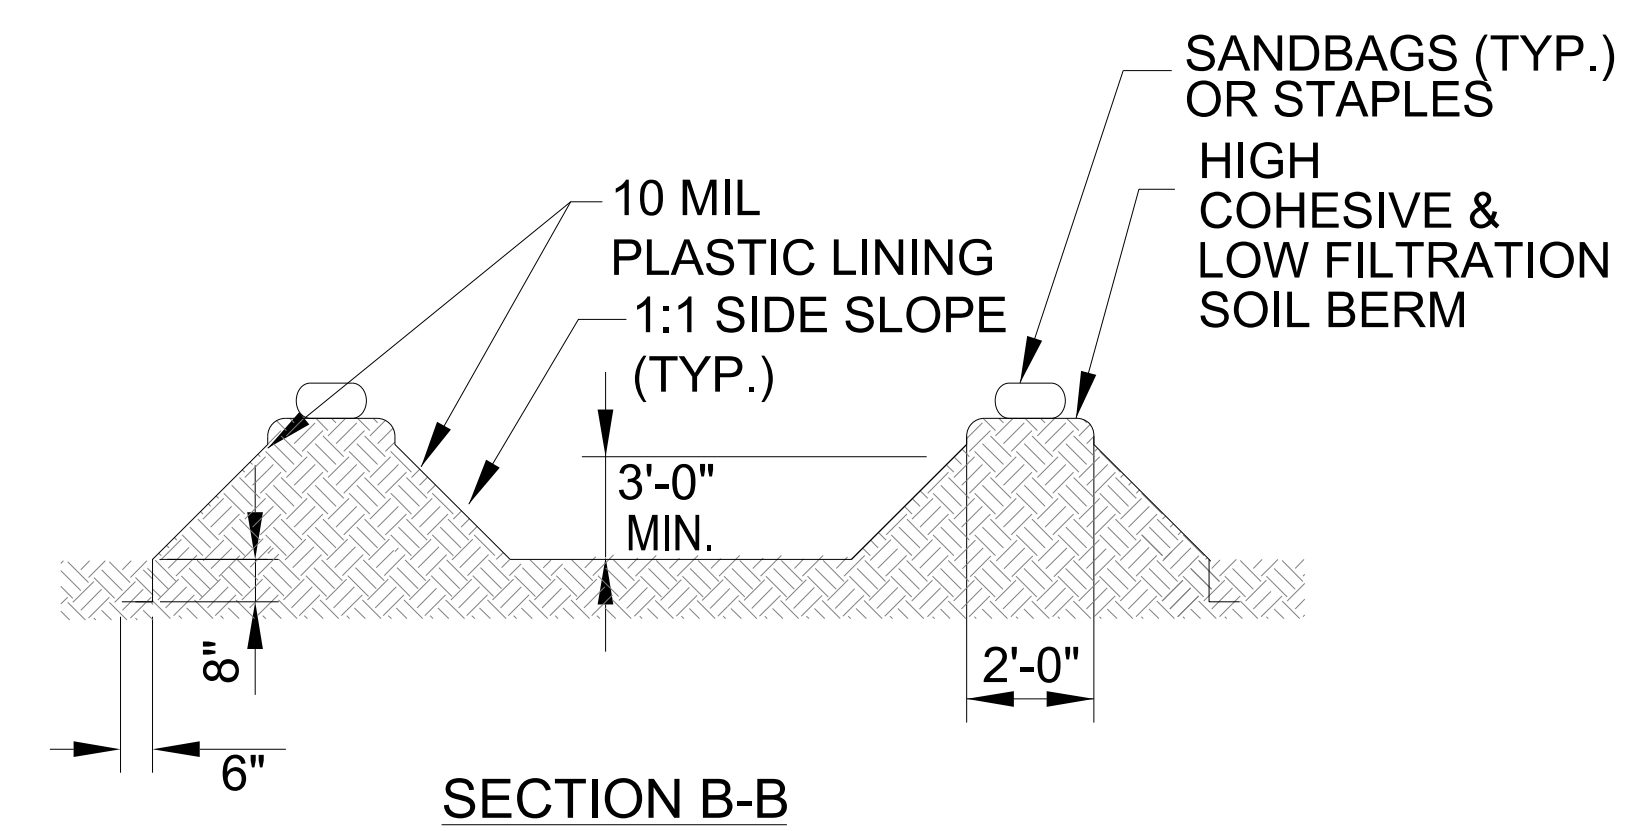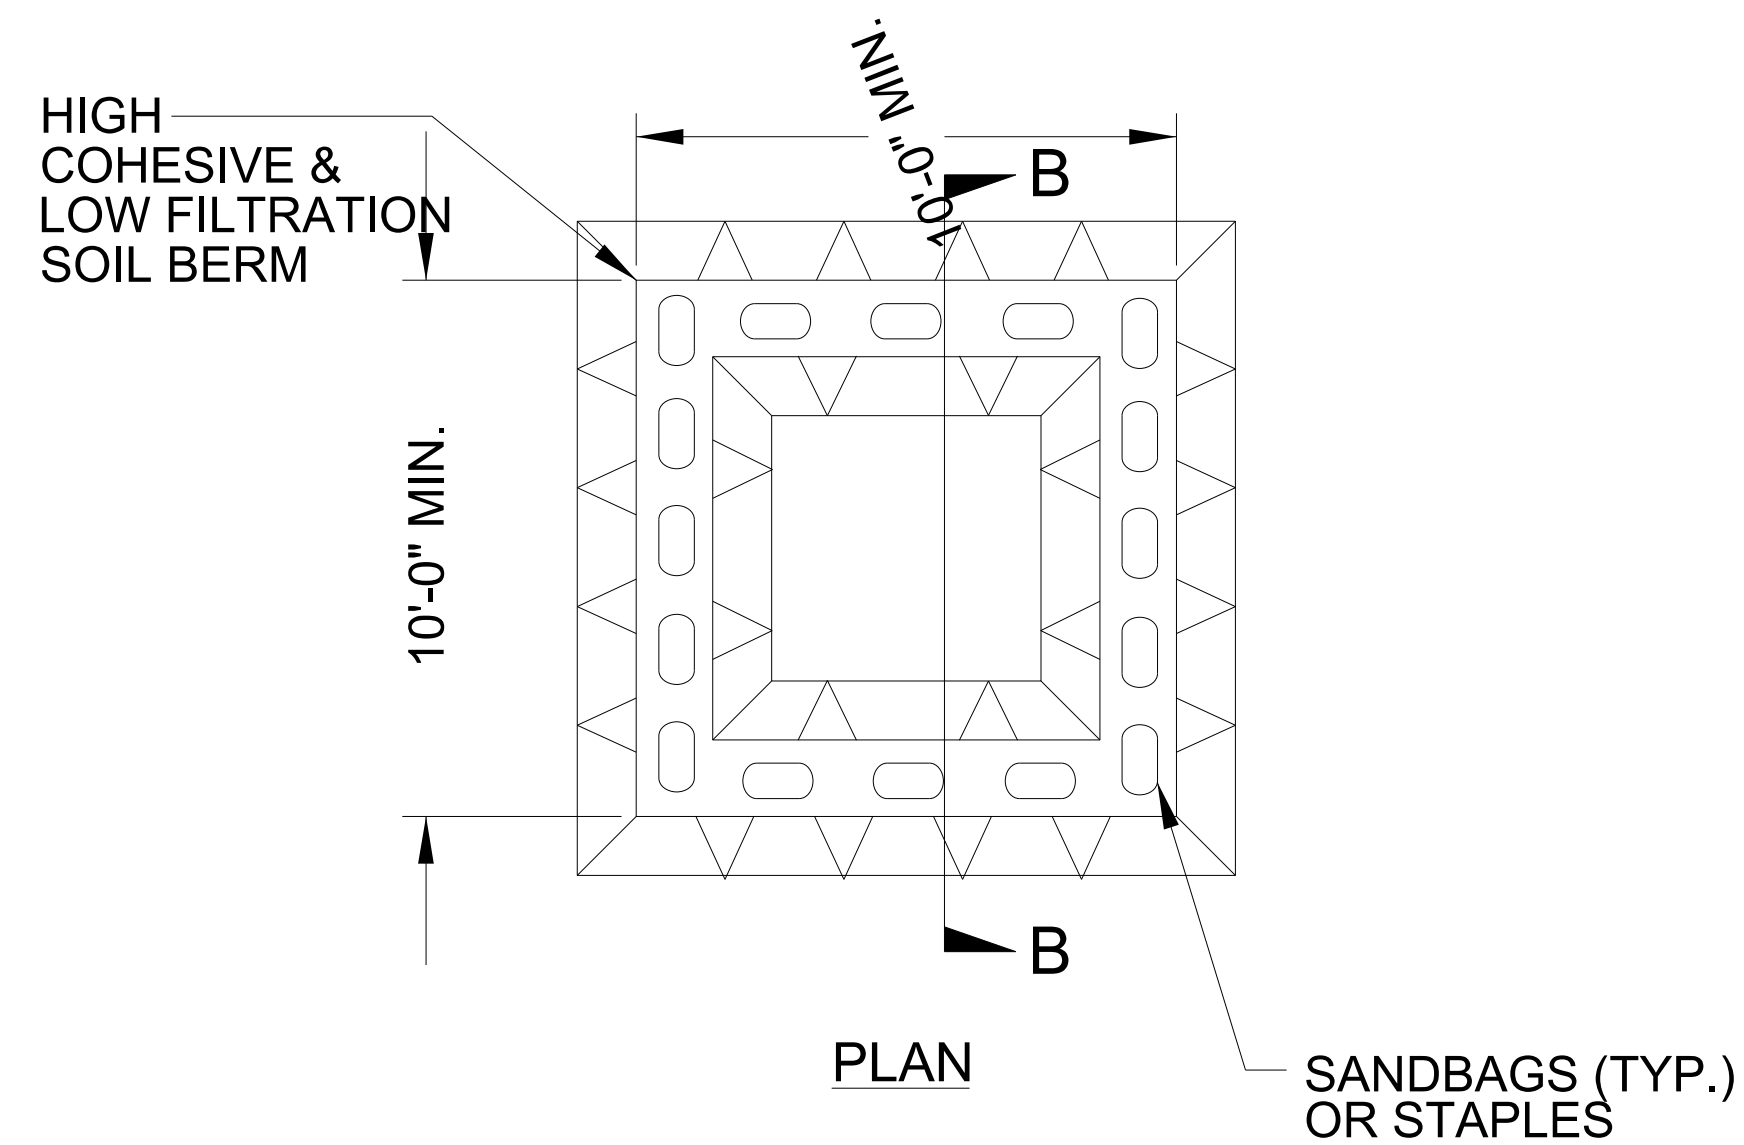

ABOVE GRADE WASHOUT STRUCTURE
NOT TO SCALE

- NOTES:
1. ACTUAL LOCATION DETERMINED IN FIELD
 2. THE CONCRETE WASHOUT STRUCTURES SHALL BE MAINTAINED WHEN THE LIQUID AND/OR SOLID REACHES 75% OF THE STRUCTURES CAPACITY TO PROVIDE ADEQUATE HOLDING CAPACITY WITH A MINIMUM 12 INCHES OF FREEBOARD.
 3. CONCRETE WASHOUT STRUCTURE NEEDS TO BE CLEARLY MARKED WITH SIGNAGE NOTING DEVICE.

DIVISION OF HIGHWAYS
STATE OF NORTH CAROLINA

SOIL STABILIZATION TIMEFRAMES


<i>SITE DESCRIPTION</i>	<i>STABILIZATION TIME</i>	<i>TIMEFRAME EXCEPTIONS</i>
PERIMETER DIKES, SWALES, DITCHES AND SLOPES	7 DAYS	NONE
HIGH QUALITY WATER (HQW) ZONES	7 DAYS	NONE
SLOPES STEEPER THAN 3:1	7 DAYS	IF SLOPES ARE 10' OR LESS IN LENGTH AND ARE NOT STEEPER THAN 2:1, 14 DAYS ARE ALLOWED.
SLOPES 3:1 OR FLATTER	14 DAYS	7 DAYS FOR SLOPES GREATER THAN 50' IN LENGTH.
ALL OTHER AREAS WITH SLOPES FLATTER THAN 4:1	14 DAYS	NONE, EXCEPT FOR PERIMETERS AND HQW ZONES.


PI Sta 17+93.45 PI Sta 21+80.54
 $\Delta = 6^{\circ} 47' 19.7''$ (LT) $\Delta = 14^{\circ} 27' 13.8''$ (LT)
 $D = 2^{\circ} 10' 00.0''$ $D = 3^{\circ} 09' 02.2''$
 $L = 313.33'$ $L = 458.76'$
 $T = 156.85'$ $T = 230.61'$
 $R = 2,644.42'$ $R = 1,818.57'$
 SE=SEE PLANS SE=SEE PLANS

**BEGIN NCDOT
 PROJECT BP4.R028
 -L- POC STA. 18+35.00**

-L- POC Sta. 16+36.60

NOTE:
 UTILIZE TEMPORARY SEDIMENT BASIN OR SPECIAL STILLING
 BASIN(S) AS STILLING BASIN WHERE APPLICABLE.

PIPE NO. 500548		PROJECT REFERENCE NO. BP4.R028	SHEET NO. EC-04/CONST.04
FINAL PLANS			
ROADWAY DESIGN ENGINEER		RW SHEET NO.	
HYDRAULICS ENGINEER			
			
1223 Jones Franklin Rd. Raleigh, N.C. 27606 License No. F-0377 Bus: 919 851 8077 Fax: 919 851 8107			
TRANSPORTATION PLANNING/DESIGN - BRIDGE/STRUCTURE DESIGN CIVIL/SITE DESIGN - GIS/GPS - CONSTRUCTION OBSERVATION			

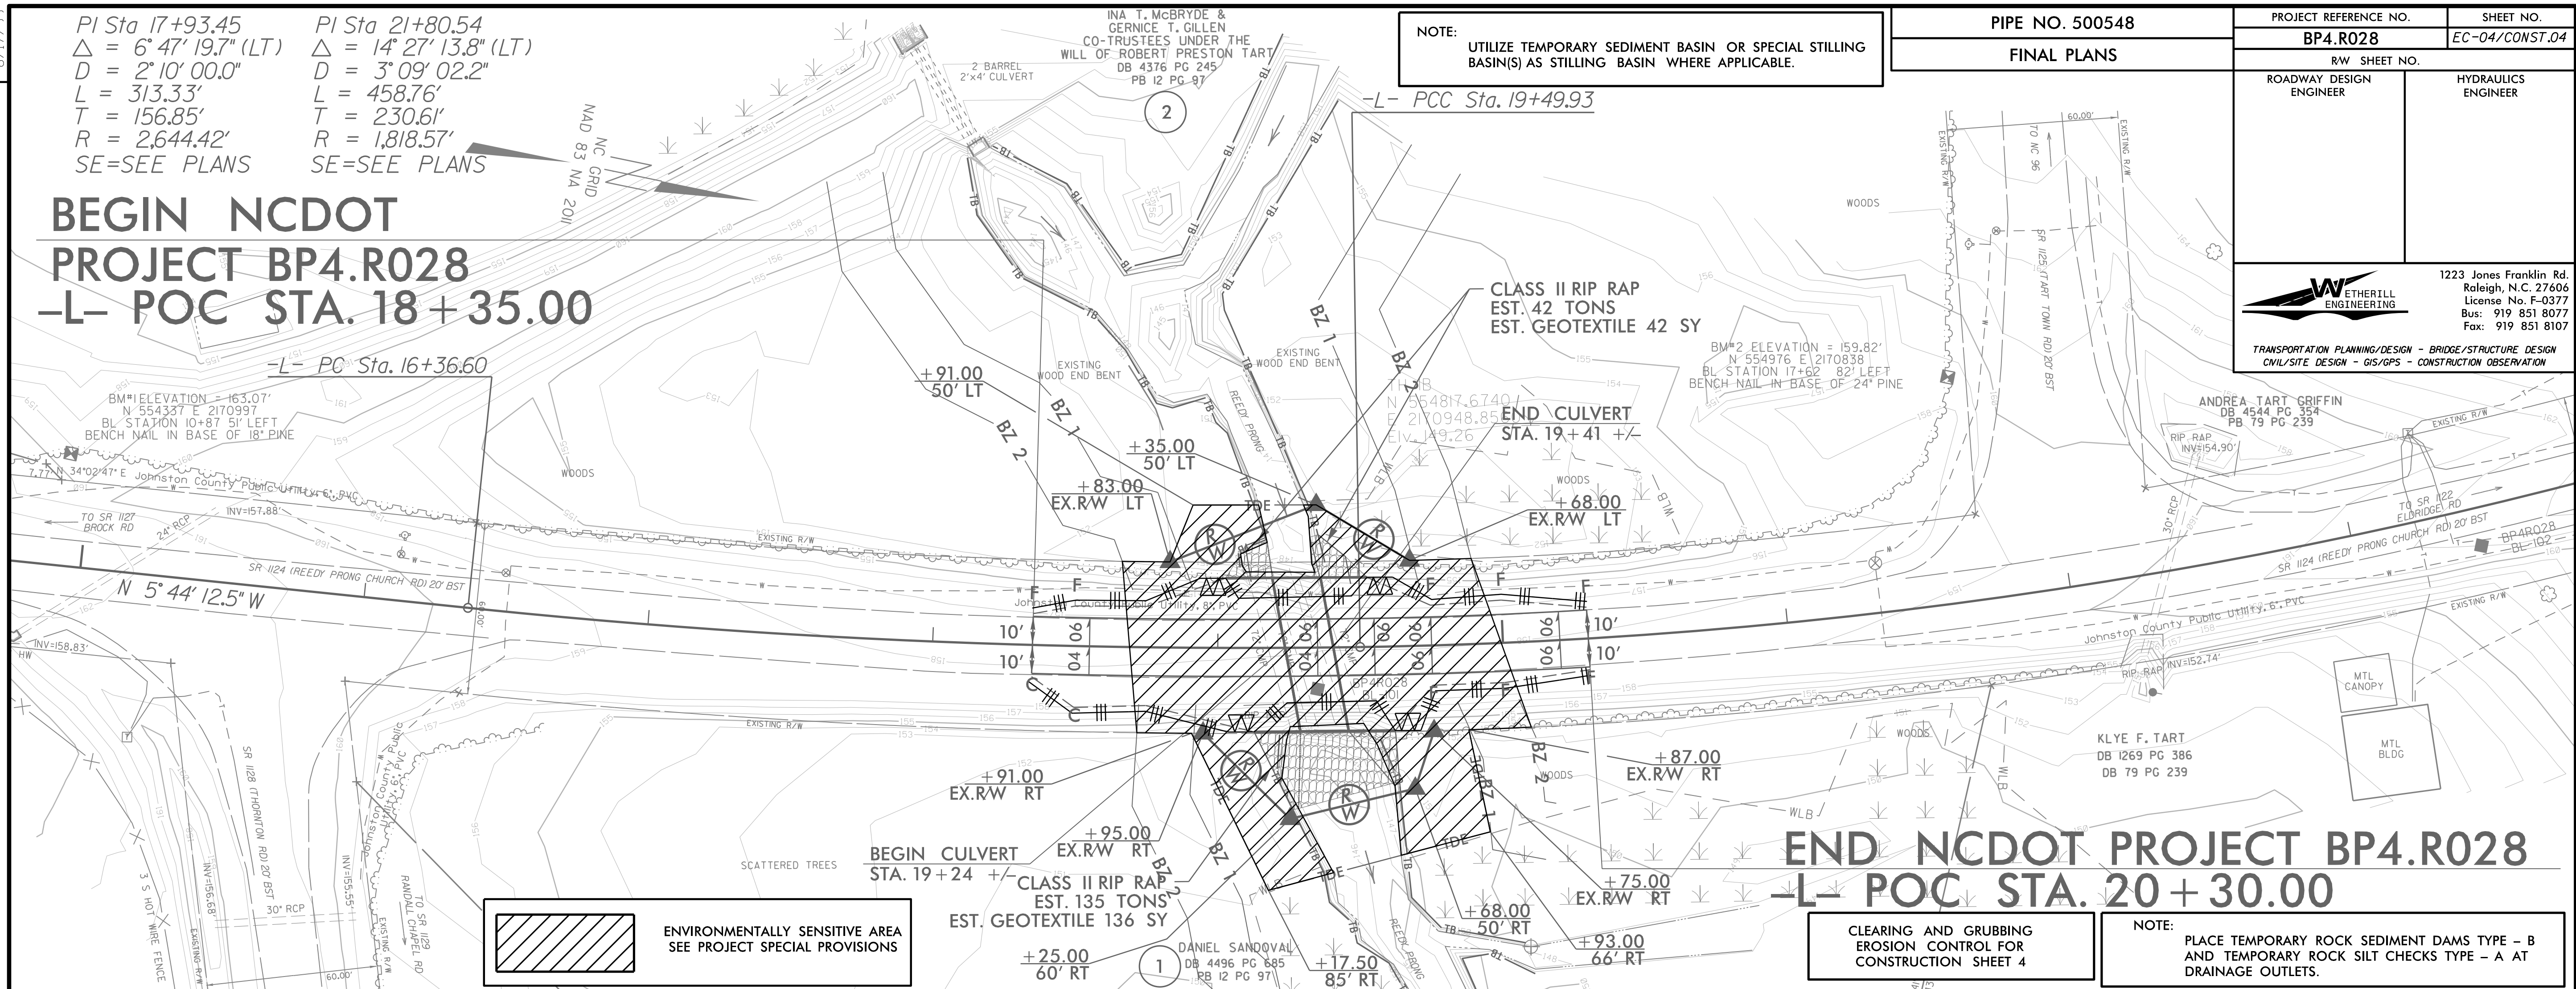


 ENVIRONMENTALLY SENSITIVE AREA
 SEE PROJECT SPECIAL PROVISIONS

**END NCDOT PROJECT BP4.R028
 -L- POC STA. 20+30.00**

CLEARING AND GRUBBING
 EROSION CONTROL FOR
 CONSTRUCTION SHEET 4

NOTE:
 PLACE TEMPORARY ROCK SEDIMENT DAMS TYPE - B
 AND TEMPORARY ROCK SILT CHECKS TYPE - A AT
 DRAINAGE OUTLETS.

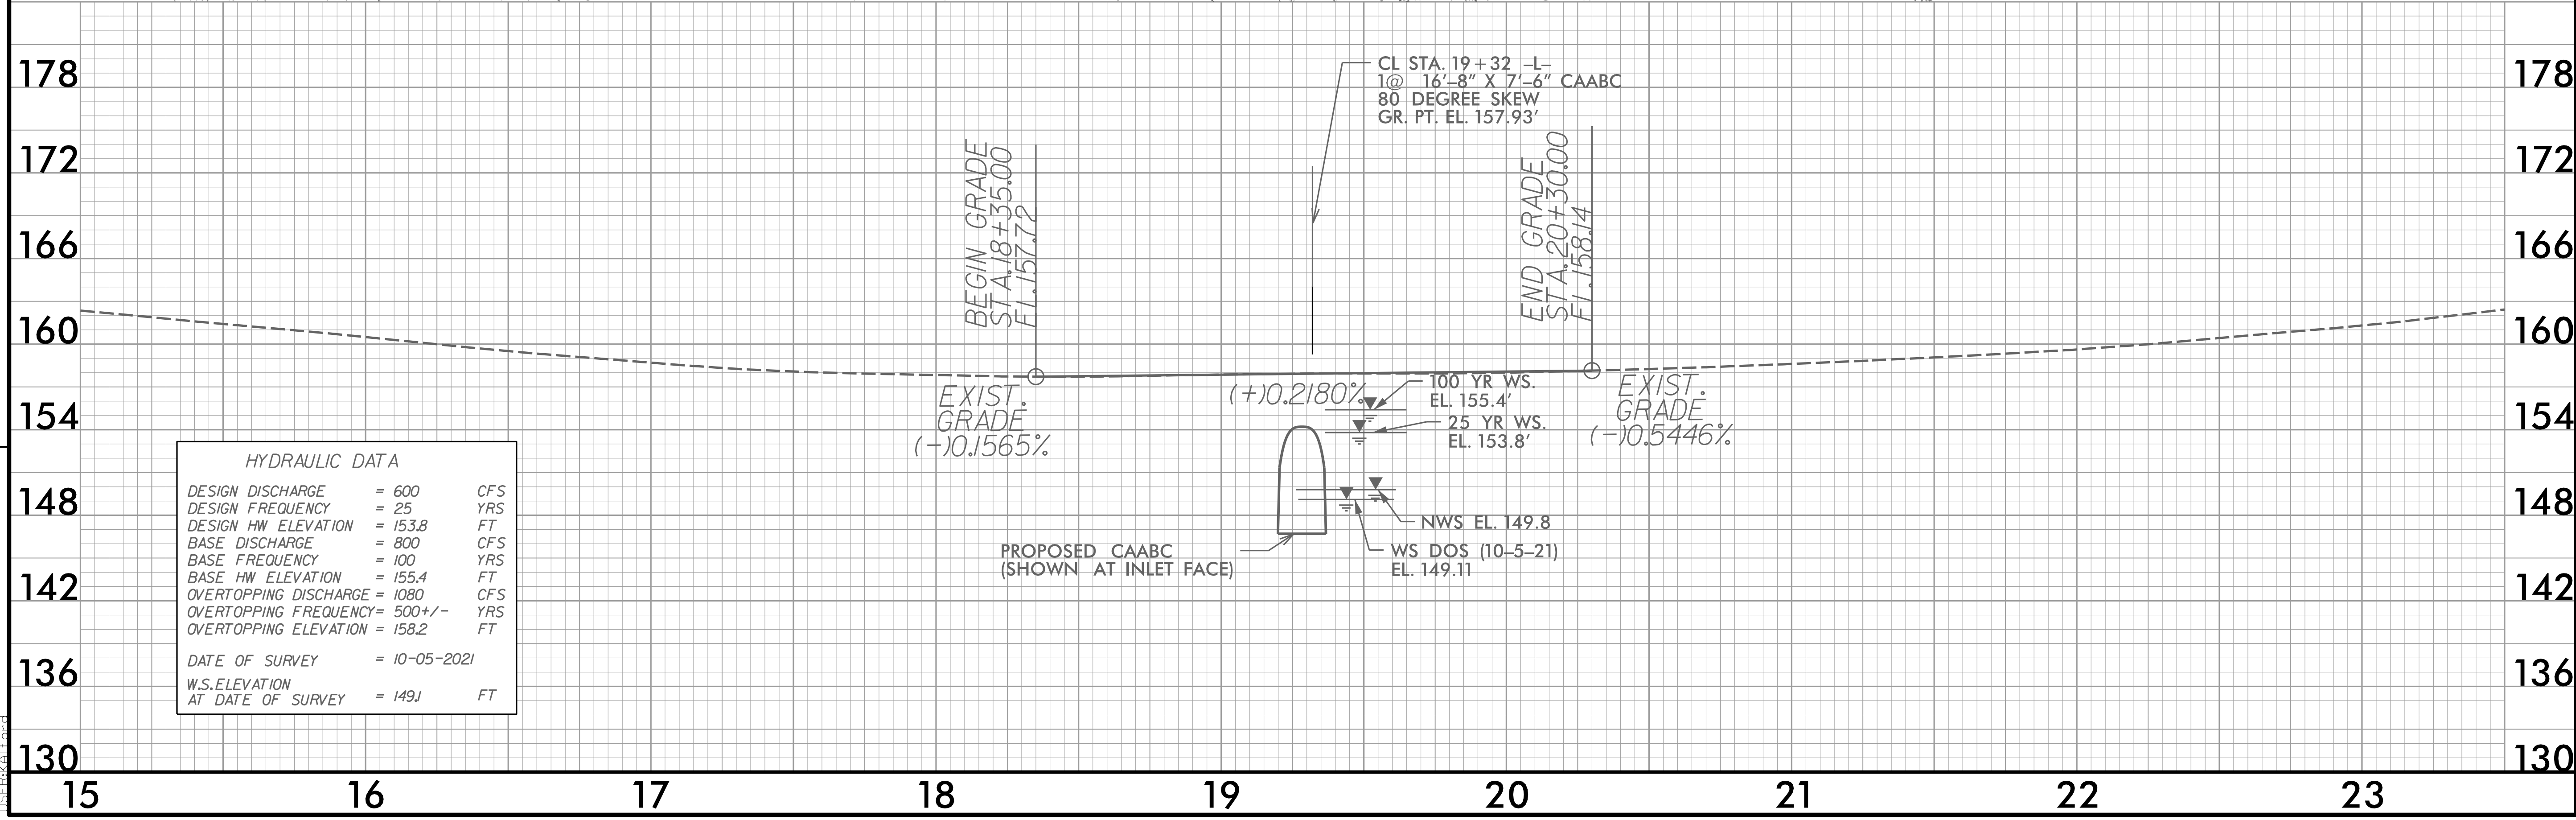

HYDRAULIC DATA		
DESIGN DISCHARGE	= 600	CFS
DESIGN FREQUENCY	= 25	YRS
DESIGN HW ELEVATION	= 153.8	FT
BASE DISCHARGE	= 800	CFS
BASE FREQUENCY	= 100	YRS
BASE HW ELEVATION	= 155.4	FT
OVERTOPPING DISCHARGE	= 1080	CFS
OVERTOPPING FREQUENCY	= 500 +/-	YRS
OVERTOPPING ELEVATION	= 158.2	FT
DATE OF SURVEY	= 10-05-2021	
W.S. ELEVATION AT DATE OF SURVEY	= 149J	FT


REVISIONS

11/18/2023
 11/18/2023
 11/18/2023

PROJECT REFERENCE NO.	SHEET NO.
BP4.R028	EC-05/CONST.04
RW SHEET NO.	
ROADWAY DESIGN ENGINEER	HYDRAULICS ENGINEER


CULVERT CONSTRUCTION SEQUENCE

PHASE I

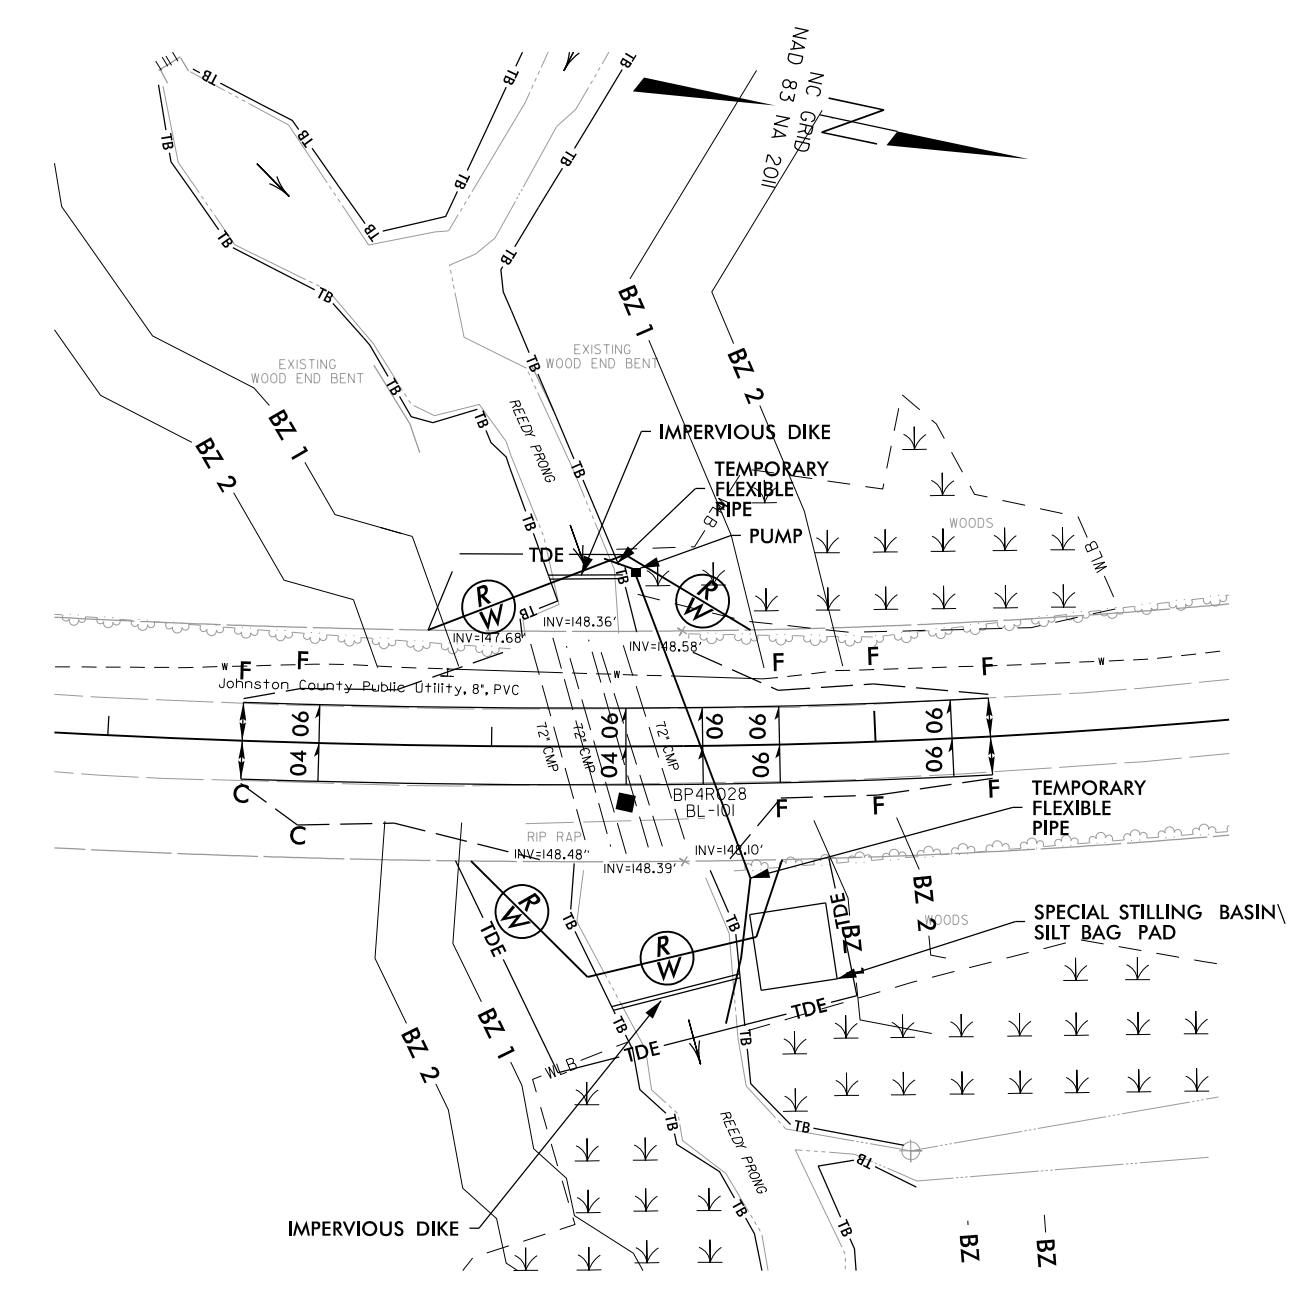


- INSTALL EROSION CONTROL MEASURES FOR THIS SITE PRIOR TO COMMENCING CULVERT WORK. (NOT SHOWN FOR CLARITY).
1. INSTALL SPECIAL STILLING BASINS AS NEEDED FOR DEWATERING OF THE PROJECT SITE THROUGHOUT CONSTRUCTION SEQUENCING.
 2. INSTALL IMPERVIOUS DIKE UPSTREAM AND DOWNSTREAM AND UTILIZE A PUMP AROUND TO MAINTAIN THE FLOW OF WATER.

PHASE II

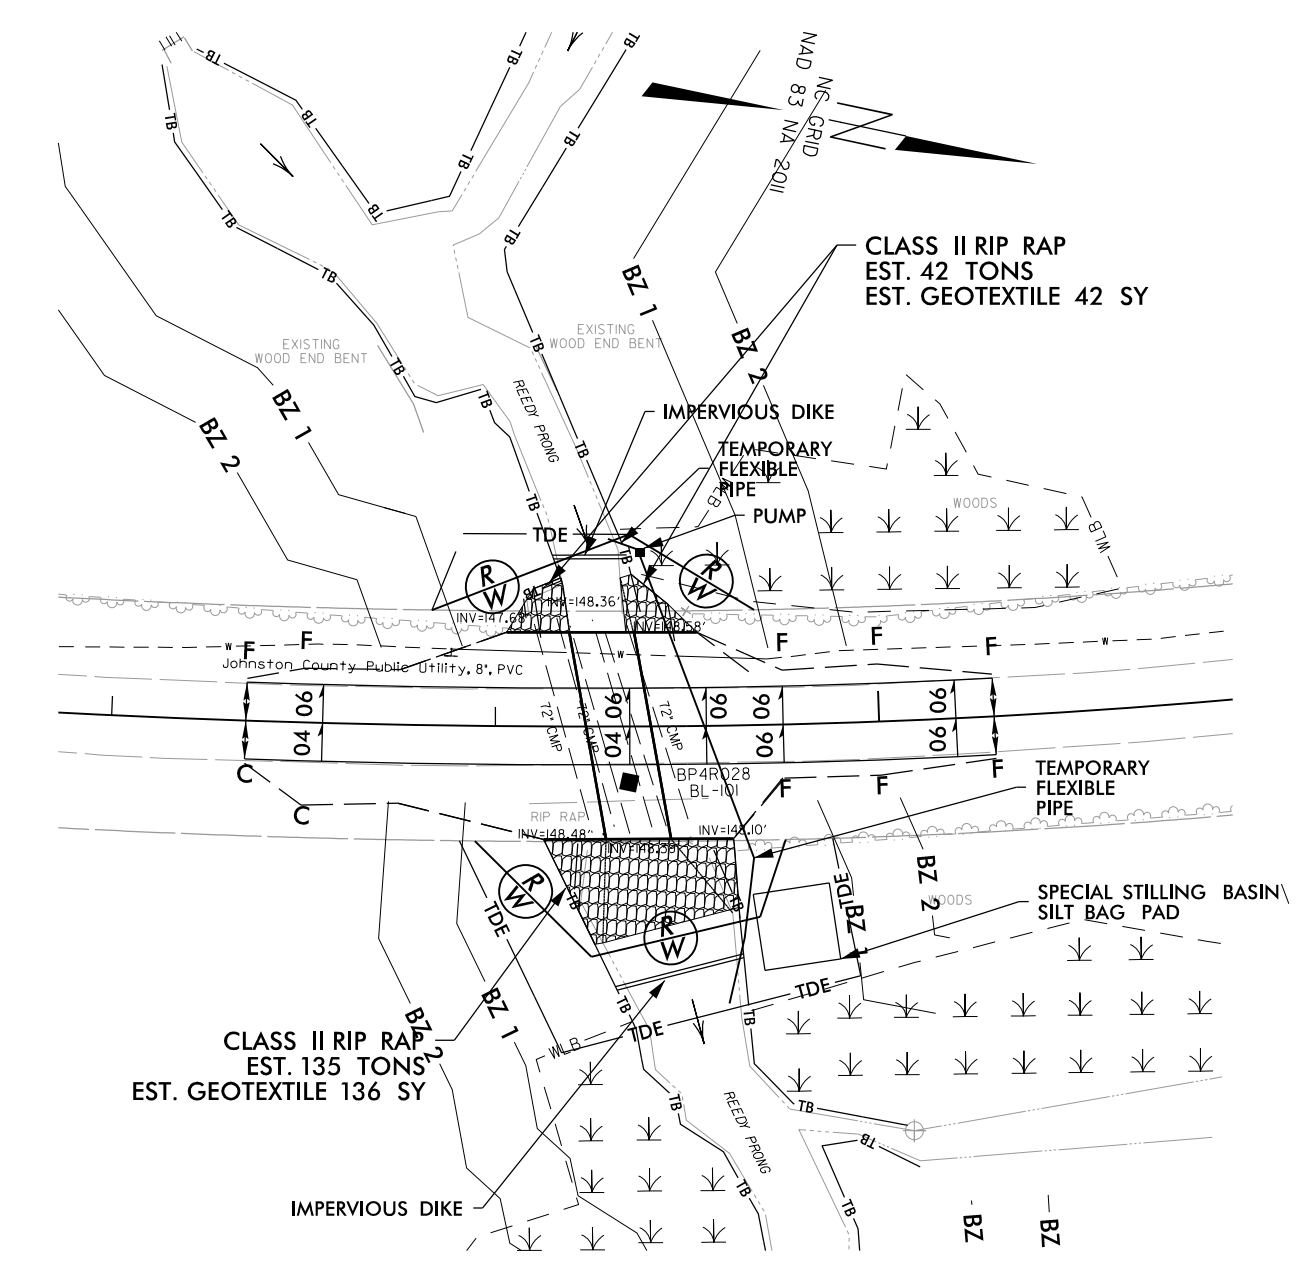

1. DEWATER WORK SITE USING SPECIAL STILLING BASIN\SILT BAG.
2. REMOVE EXISTING PIPES AND HEADWALLS. INSTALL ALUMINUM BOX CULVERT, HEADWALLS, AND PLACE RIP RAP ALL IN THE DRY.

PHASE III

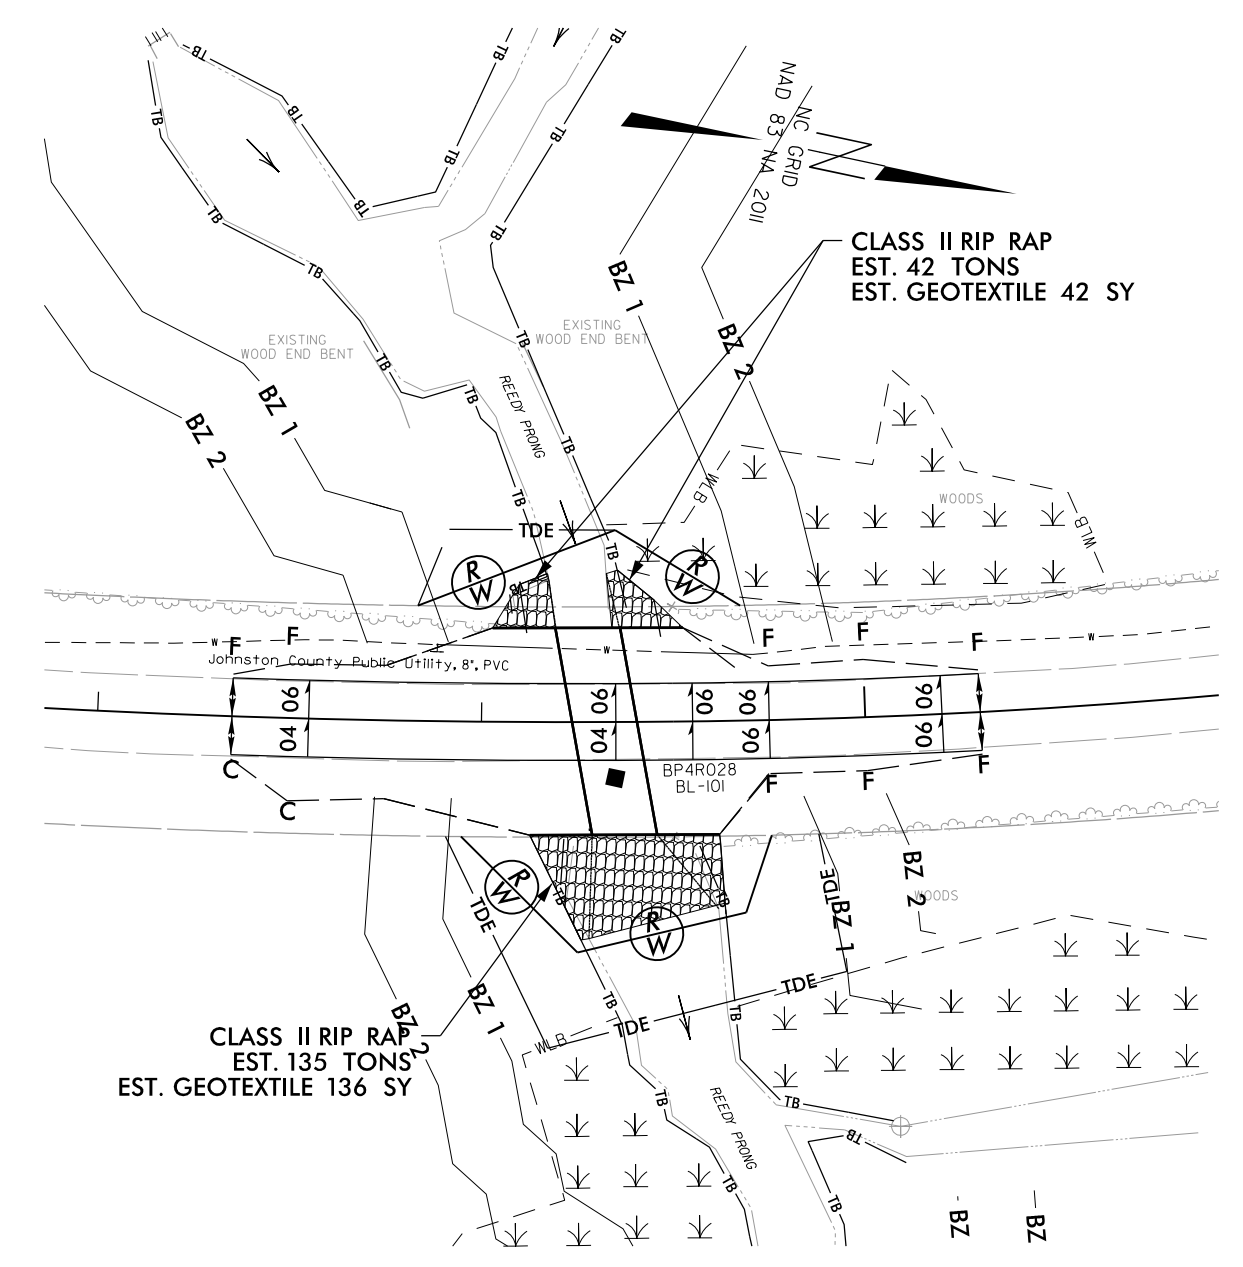

1. REMOVE IMPERVIOUS DIKES TO ALLOW NORMAL STREAM FLOW.
2. REMOVE PUMP, TEMPORARY FLEXIBLE PIPE, AND SPECIAL STILLING BASIN\SILT BAG.
3. CONSTRUCT ROADWAY.


STATE	STATE PROJECT REFERENCE NO.	SHEET NO.	TOTAL SHEETS
N.C.	BP4.R028	RF-1	
STATE PROJ. NO.	P.A. PROJ. NO.	DESCRIPTION	

PLANTING DETAILS


SEEDLING / LINER BAREROOT PLANTING DETAIL

HEALING IN


1. Locate a healing-in site in a shady, well protected area.
2. Excavate a flat bottom trench 12 inches deep and provide drainage.

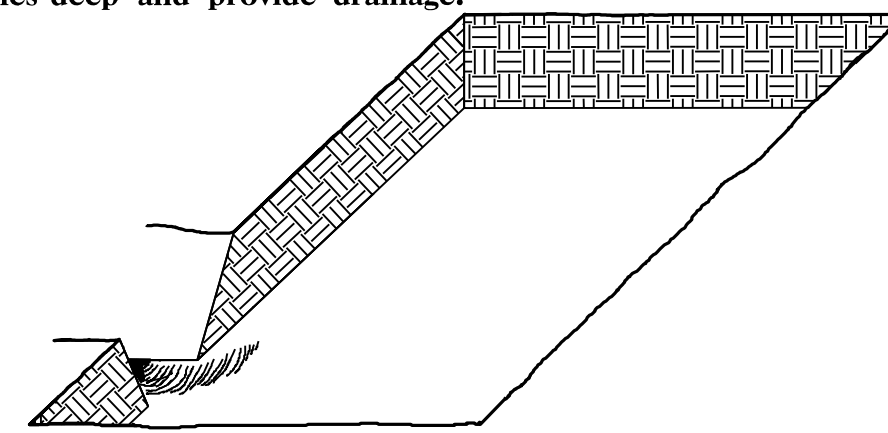


3. Backfill the trench with 2 inches well rotted sawdust. Place a 2 inch layer of well rotted sawdust at a sloping angle at one end of the trench.

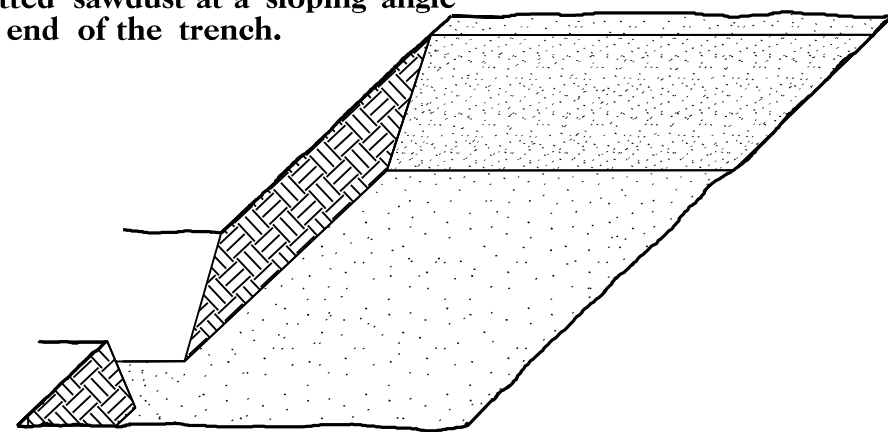

4. Place a single layer of plants against the sloping end so that the root collar is at ground level.

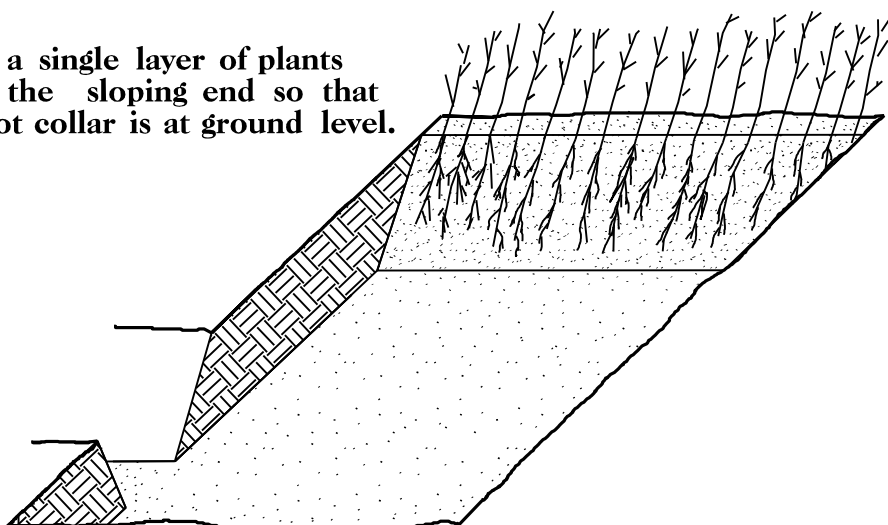


5. Place a 2 inch layer of well rotted sawdust over the roots maintaining a sloping angle.

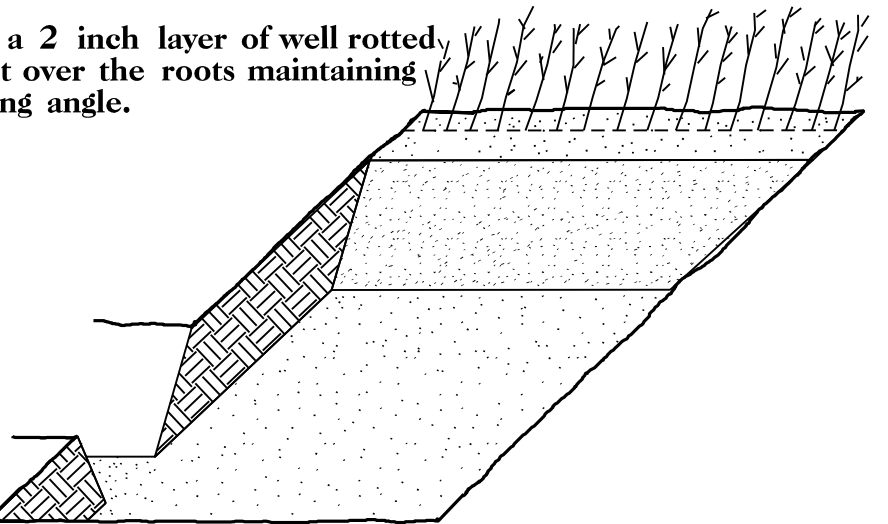


6. Repeat layers of plants and sawdust as necessary and water thoroughly.


DIBBLE PLANTING METHOD USING THE KBC PLANTING BAR

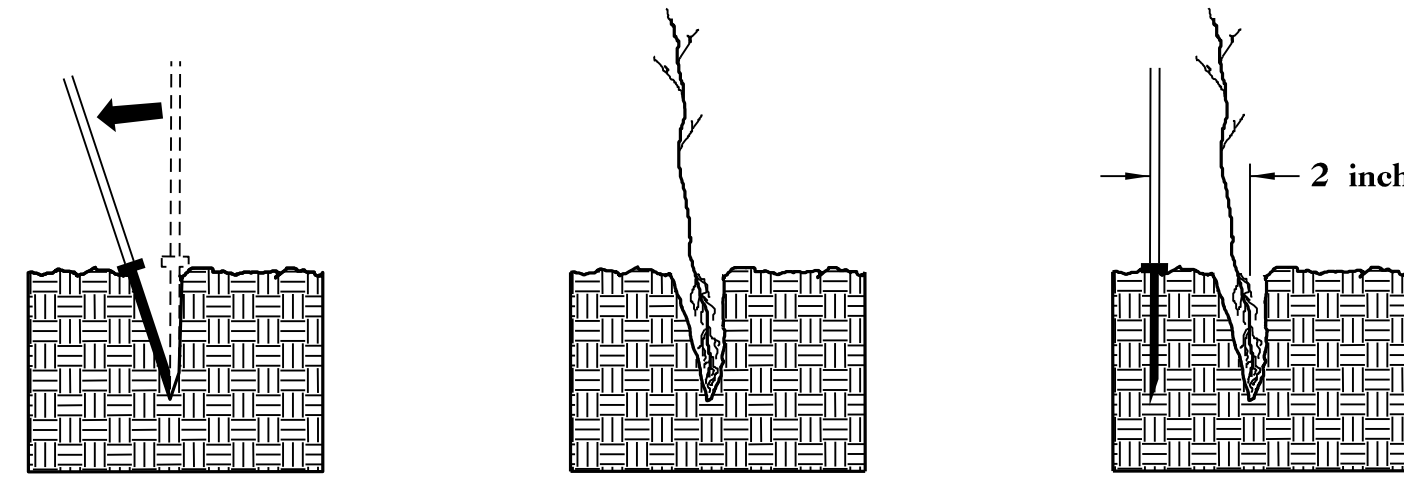


1. Insert planting bar as shown and pull handle toward planter.

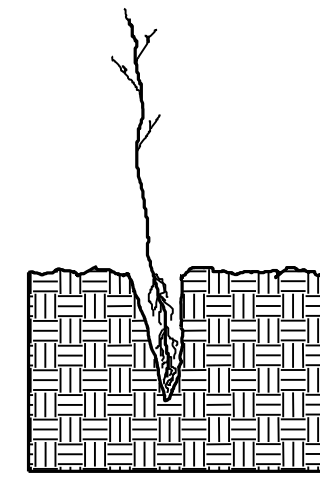


2. Remove planting bar and place seedling at correct depth.

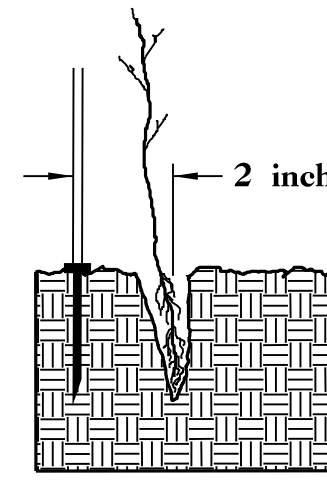


3. Insert planting bar 2 inches toward planter from seedling.

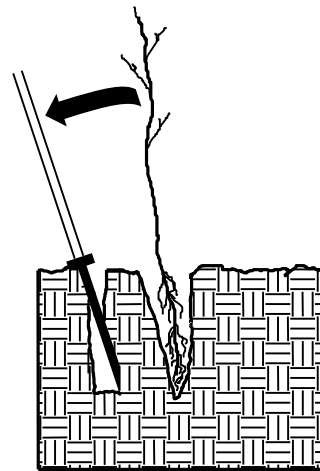

4. Pull handle of bar toward planter, firming soil at bottom.

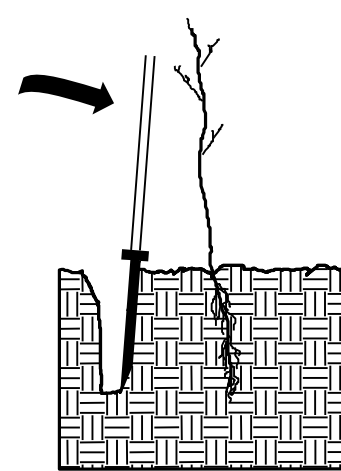

5. Push handle forward firming soil at top.

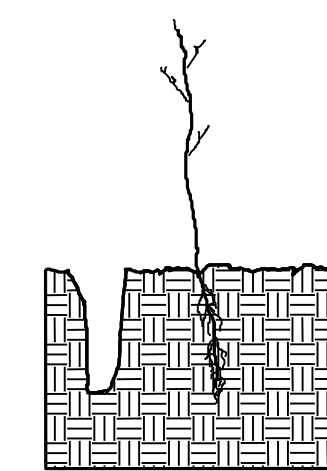


6. Leave compaction hole open. Water thoroughly.

PLANTING NOTES:

PLANTING BAG
During planting, seedlings shall be kept in a moist canvas bag or similar container to prevent the root systems from drying.



KBC PLANTING BAR
Planting bar shall have a blade with a triangular cross section, and shall be 12 inches long, 4 inches wide and 1 inch thick at center.

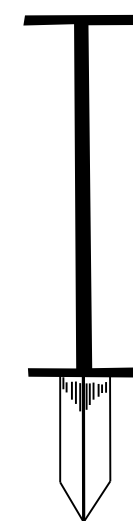

ROOT PRUNING
All seedlings shall be root pruned, if necessary, so that no roots extend more than 10 inches below the root collar.

REFORESTATION

- TREE REFORESTATION SHALL BE PLANTED 6 FT. TO 10 FT. ON CENTER, RANDOM SPACING, AVERAGING 8 FT. ON CENTER, APPROXIMATELY 680 PLANTS PER ACRE.

REFORESTATION

MIXTURE, TYPE, SIZE, AND FURNISH SHALL CONFORM TO THE FOLLOWING:

40%	LIRIODENDRON TULIPIFERA	TULIP POPLAR	12 in - 18 in BR
30%	PLATANUS OCCIDENTALIS	AMERICAN SYCAMORE	12 in - 18 in BR
30%	BETULA NIGRA	RIVER BIRCH	12 in - 18 in BR

REFORESTATION DETAIL SHEET


N.C.D.O.T. - ROADSIDE ENVIRONMENTAL UNIT

09/08/2019

See Sheet UC-2 For Conventional Symbols

T.I.P. NO.	SHEET NO.
BP4.R028	UC-1

PROJECT: BP4.R028

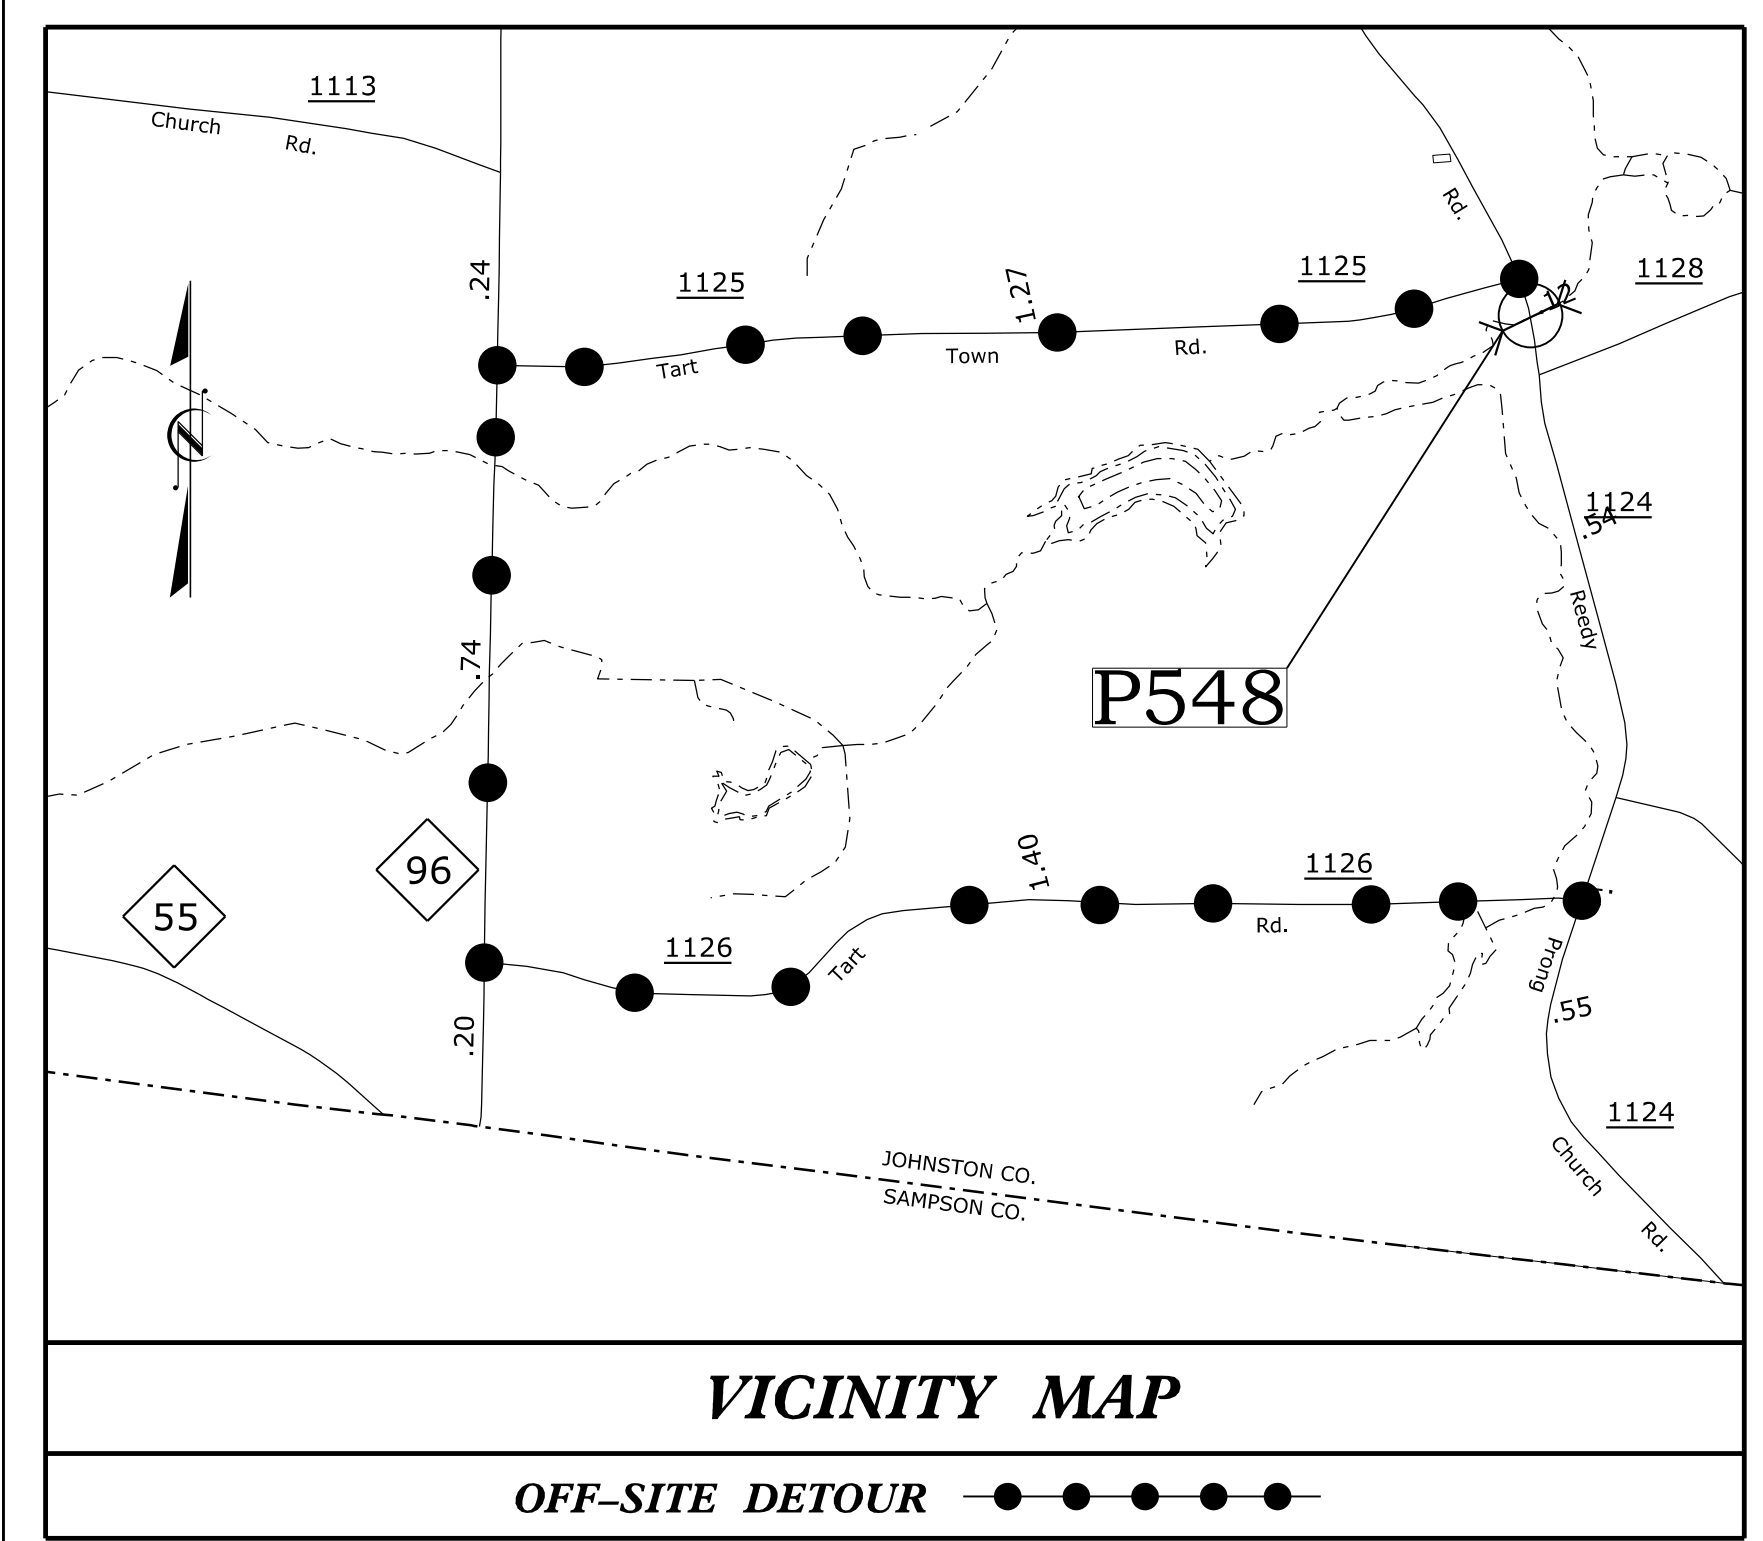

STATE OF NORTH CAROLINA DIVISION OF HIGHWAYS


UTILITY CONSTRUCTION PLANS

RELEASE FOR
CONSTRUCTION
DATE: 11/15/2023


**LOCATION: PIPE NO. 500548 OVER REEDY PRONG
ON SR 1124 (REEDY PRONG CHURCH RD.)**

TYPE OF WORK: WATER RELOCATION

RFC PLANS

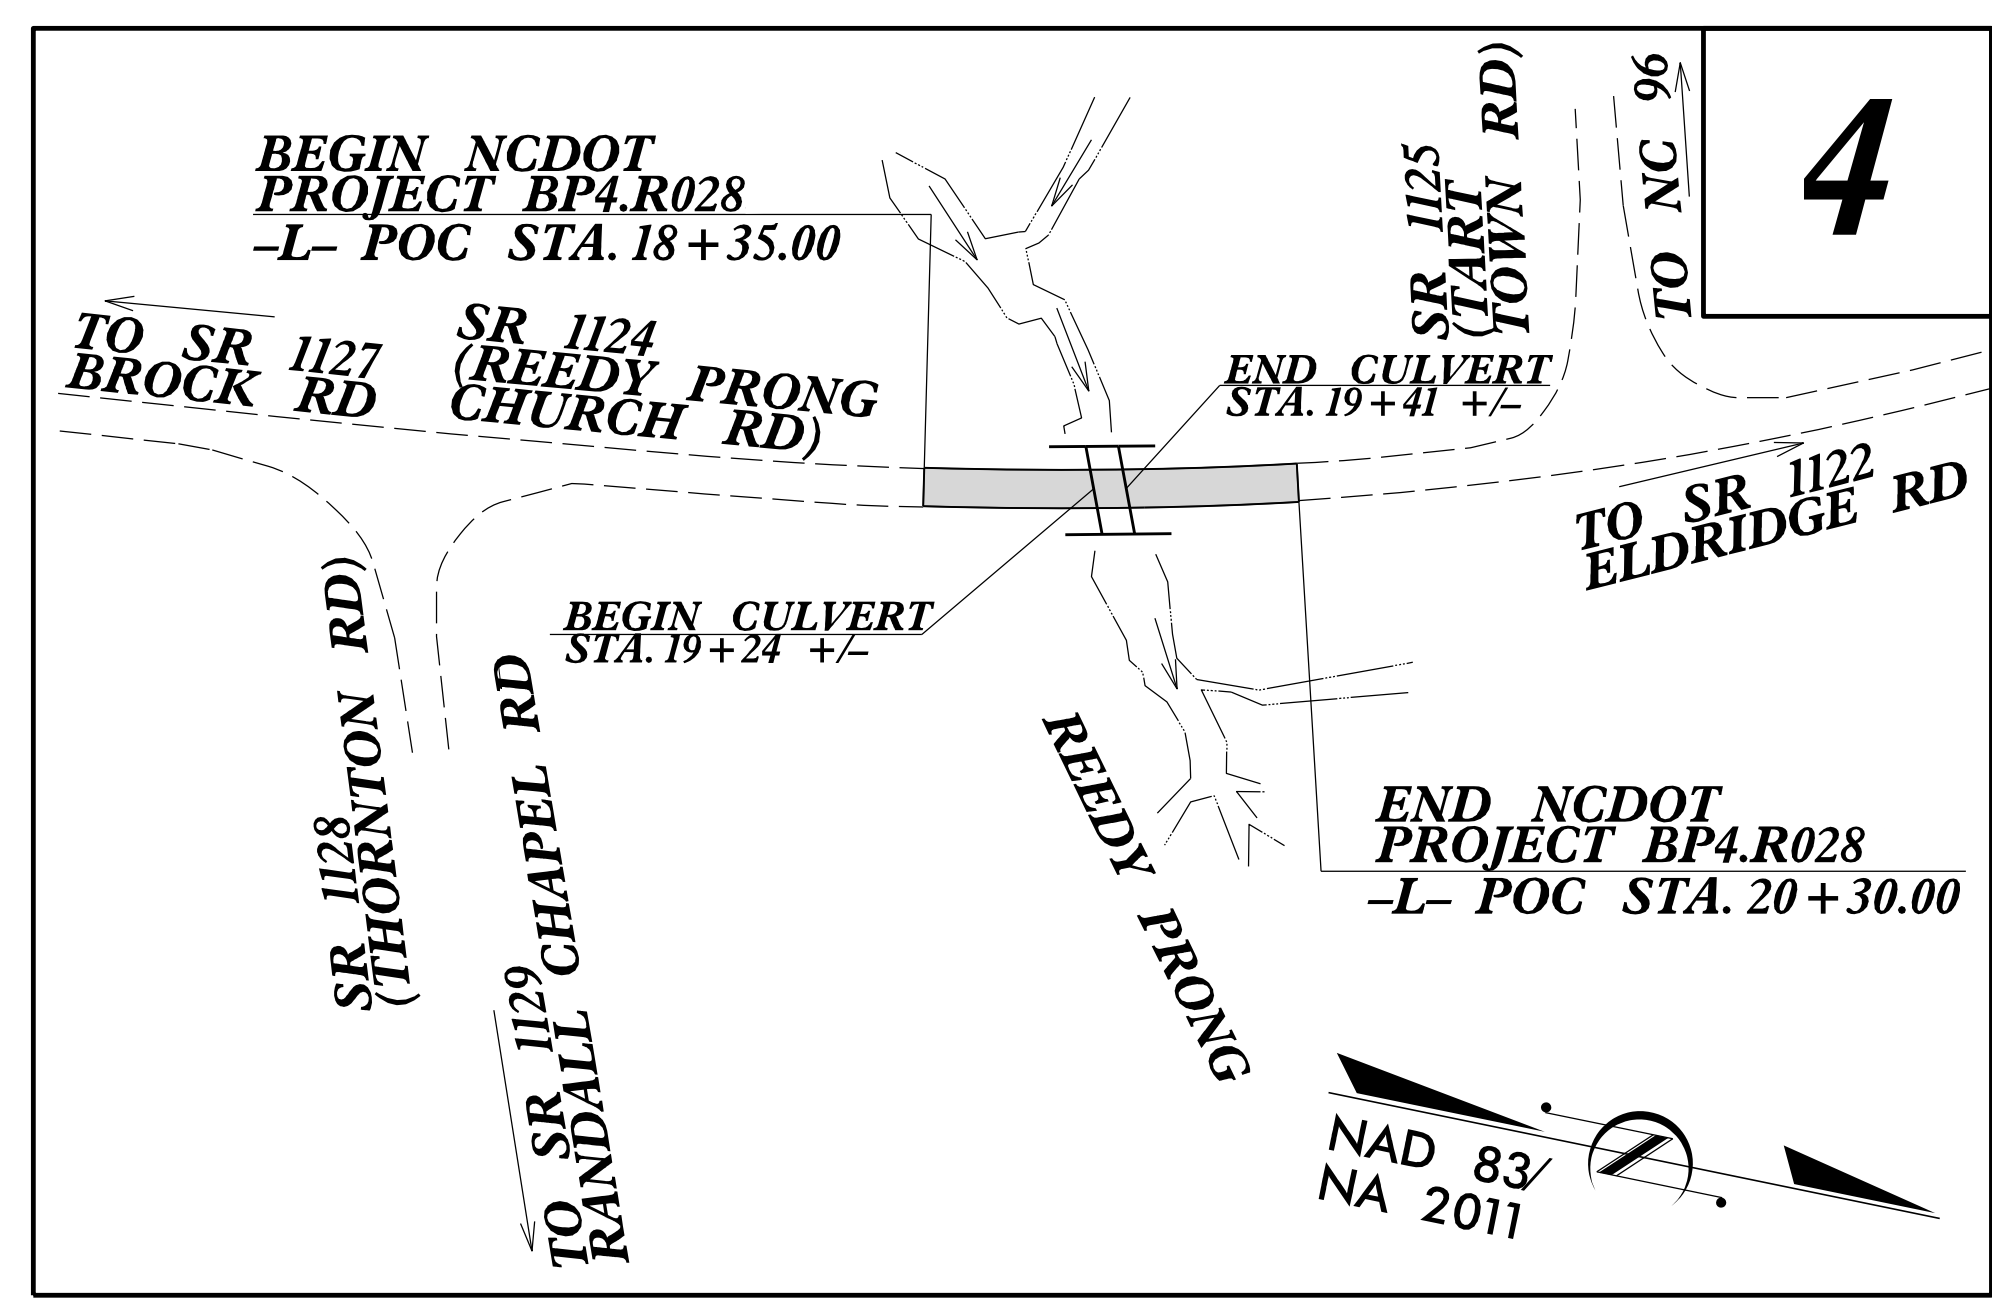

DOCUMENT NOT CONSIDERED FINAL
UNTIL ALL SIGNATURES ARE COMPLETED

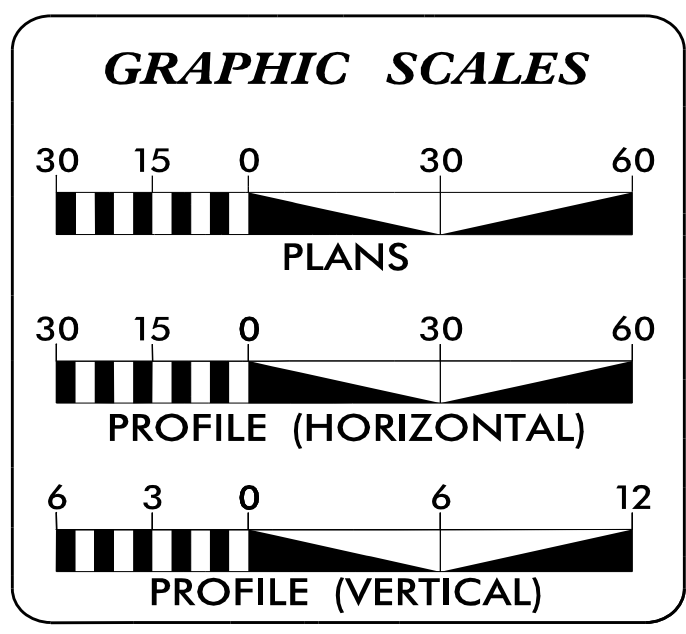

INDEX OF SHEETS

SHEET NO.:	DESCRIPTION:
UC-1	TITLE SHEET
UC-2	UTILITY SYMBOLOGY
UC-3	NOTES
UC-3A	DETAILS
UC-4	UTILITY CONSTRUCTION PLAN AND PROFILE SHEET

WATER OWNER ON PROJECT

(A) WATER - JOHNSTON COUNTY

PREPARED IN THE OFFICE OF

WETHERILL ENGINEERING

1223 Jones Franklin Rd.
Raleigh, N.C. 27606
License No. F-0377
Bus: 919 851 8077
Fax: 919 851 8107

TRANSPORTATION PLANNING/DESIGN - BRIDGE/STRUCTURE DESIGN
CIVIL/SITE DESIGN - GIS/GPS - SURVEY/SUE - UTILITIES - CONSTRUCTION OBSERVATION

PANKIL K. PATEL UTILITY PROJECT MANAGER
JOHN D. SCHRINER, PLS UTILITY COORDINATOR

SEAL 11/15/2023

EDWARD G. WETHERILL
ENGINEER
10773

**DIVISION OF HIGHWAYS
DIVISION FOUR**
509 Ward Boulevard, Wilson NC, 27895

ANDY BROWN, PE ACTING DEPUTY DIVISION ENGINEER
NCDOT DIVISION 4

KYLE PLEASANT DIVISION UTILITY ENGINEER

\$\$\$ SYSTEMS \$\$\$
\$\$\$ DGN \$\$\$
\$\$\$ USERNAME \$\$\$

STATE OF NORTH CAROLINA DIVISION OF HIGHWAYS

**WETHERILL
ENGINEERING**
1223 Jones Franklin Rd.
Raleigh, N.C. 27606
License No. F-0377
Bus: 919 851 8077
Fax: 919 851 8107
TRANSPORTATION PLANNING/DESIGN - BRIDGE/STRUCTURE DESIGN
CIVIL/SITE DESIGN - GIS/GIS - SURVEY/SUE - UTILITIES - CONSTRUCTION OBSERVATION

PROJECT REFERENCE NO. BP4 .R028	SHEET NO. UC-2
DOCUMENT NOT CONSIDERED FINAL UNLESS ALL SIGNATURES COMPLETED	
UTILITY CONSTRUCTION	

UTILITIES PLAN SHEET SYMBOLS

RELEASE FOR
CONSTRUCTION
DATE: 11/15/2023

PROPOSED WATER SYMBOLS

Water Line (Sized as Shown)	
11¼ Degree Bend	
22½ Degree Bend	
45 Degree Bend	
90 Degree Bend	
Plug	
Tee	
Cross	
Reducer	
Gate Valve	
Butterfly Valve	
Tapping Valve	
Line Stop	
Line Stop with Bypass	
Blow Off	
Fire Hydrant	
Relocate Fire Hydrant	
Remove Fire Hydrant	REM FH
Water Meter	
Relocate Water Meter	
Remove Water Meter	REM WM
Water Pump Station	
RPZ Backflow Preventer	
DCV Backflow Preventer	
Relocate RPZ Backflow Preventer	
Relocate DCV Backflow Preventer	

PROPOSED SEWER SYMBOLS

Gravity Sewer Line (Sized as Shown)	
Force Main Sewer Line (Sized as Shown)	
Manhole (Sized per Note)	
Sewer Pump Station	

PROPOSED MISCELLANEOUS UTILITIES SYMBOLS

Power Pole	
Telephone Pole	
Joint Use Pole	
Telephone Pedestal	
Utility Line by Others (Type as Shown)	
Trenchless Installation	
Encasement by Open Cut	
Encasement	

Thrust Block	
Air Release Valve	
Utility Vault	
Concrete Pier	
Steel Pier	
Remove Pole	REM
Plan Note	
Pay Item Note	

EXISTING UTILITIES SYMBOLS

Power Pole		*Underground Power Line	
Telephone Pole		*Underground Telephone Cable	
Joint Use Pole		*Underground Telephone Conduit	
Utility Pole		*Underground Fiber Optics Telephone Cable	
Utility Pole with Base		*Underground TV Cable	
H-Frame Pole		*Underground Fiber Optics TV Cable	
Power Transmission Line Tower		*Underground Gas Pipeline	
Water Manhole		Aboveground Gas Pipeline	
Power Manhole		*Underground Water Line	
Telephone Manhole		Aboveground Water Line	
Sanitary Sewer Manhole		*Underground Gravity Sanitary Sewer Line	
Hand Hole for Cable		Aboveground Gravity Sanitary Sewer Line	
Power Transformer		*Underground SS Forced Main Line	
Telephone Pedestal		Underground Unknown Utility Line	
CATV Pedestal		SUE Test Hole	
Gas Valve		Water Meter	
Gas Meter		Water Valve	
Located Miscellaneous Utility Object		Fire Hydrant	
Abandoned According to Utility Records	AATUR	Sanitary Sewer Cleanout	
End of Information	E.O.I.		


*For Existing Utilities
Utility Line Drawn from Record (Type as Shown)

Designated Utility Line (Type as Shown)

UTILITY CONSTRUCTION


 1223 Jones Franklin Rd.
 Raleigh, N.C. 27606
 License No. F-0377
 Bus: 919 851 8077
 Fax: 919 851 8107

TRANSPORTATION PLANNING/DESIGN - BRIDGE/STRUCTURE DESIGN
 CIVIL/SITE DESIGN - GIS/GPS - SURVEY/SUE - UTILITIES - CONSTRUCTION OBSERVATION

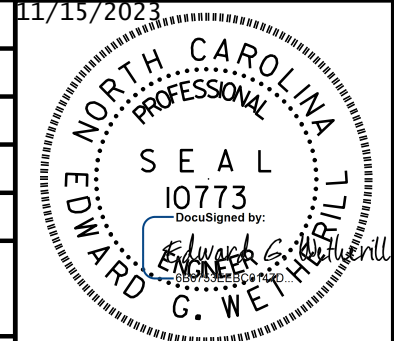PROJECT REFERENCE NO. BP4.R028	SHEET NO. UC-3
DESIGNED BY: PKP	11/15/2023
DRAWN BY: JDS	
CHECKED BY: PKP	
APPROVED BY: EGW	
REVISED:	
NORTH CAROLINA DEPARTMENT OF TRANSPORTATION	
UTILITIES ENGINEERING SEC. PHONE: (919) 707-6690 FAX: (919) 250-4151	UTILITY CONSTRUCTION PLANS ONLY
DOCUMENT NOT CONSIDERED FINAL UNLESS ALL SIGNATURES COMPLETED	
UTILITY CONSTRUCTION	

GENERAL NOTES:

1. THE PROPOSED UTILITY CONSTRUCTION SHALL MEET THE APPLICABLE REQUIREMENTS OF THE NC DEPARTMENT OF TRANSPORTATIONS "STANDARD SPECIFICATIONS FOR ROADS AND STRUCTURES" DATED JANUARY 2024.
2. THE EXISTING UTILITIES BELONG TO JOHNSTON COUNTY. CONTACT MIKE KEEN (UTILITY PROJECT MANAGER) 919-209-8333.
3. ALL WATER LINES TO BE INSTALLED WITHIN COMPLIANCE OF THE RULES AND REGULATIONS OF THE NORTH CAROLINA DEPARTMENT OF ENVIRONMENTAL QUALITY, DIVISION OF WATER RESOURCES, PUBLIC WATER SUPPLY SECTION. ALL SEWER LINES TO BE INSTALLED WITHIN COMPLIANCE OF THE RULES AND REGULATIONS OF THE NORTH CAROLINA DEPARTMENT OF ENVIRONMENT QUALITY, DIVISION OF WATER RESOURCES, WATER QUALITY SECTION. PERFORM ALL WORK IN ACCORDANCE WITH THE APPLICABLE PLUMBING CODES.
4. THE UTILITY OWNER OWNS THE EXISTING UTILITY FACILITIES AND WILL OWN THE NEW UTILITY FACILITIES AFTER ACCEPTANCE BY THE DEPARTMENT. THE DEPARTMENT OWNS THE CONSTRUCTION CONTRACT AND HAS ADMINISTRATIVE AUTHORITY. COMMUNICATIONS AND DECISIONS BETWEEN THE CONTRACTOR AND UTILITY OWNER ARE NOT BINDING UPON THE DEPARTMENT OR THIS CONTRACT UNLESS AUTHORIZED BY THE ENGINEER. AGREEMENTS BETWEEN THE UTILITY OWNER AND CONTRACTOR FOR THE WORK THAT IS NOT PART OF THIS CONTRACT OR IS SECONDARY TO THIS CONTRACT ARE ALLOWED, BUT ARE NOT BINDING UPON THE DEPARTMENT.
5. PROVIDE ACCESS FOR THE DEPARTMENT PERSONNEL AND THE OWNER'S REPRESENTATIVES TO ALL PHASES OF CONSTRUCTION. NOTIFY DEPARTMENT PERSONNEL AND THE UTILITY OWNER TWO WEEKS PRIOR TO COMMENCEMENT OF ANY WORK AND ONE WEEK PRIOR TO SERVICE INTERRUPTION. KEEP UTILITY OWNERS' REPRESENTATIVES INFORMED OF WORK PROGRESS AND PROVIDE OPPORTUNITY FOR INSPECTION OF CONSTRUCTION AND TESTING.
6. THE PLANS DEPICT THE BEST AVAILABLE INFORMATION FOR THE LOCATION, SIZE, AND TYPE OF MATERIAL FOR ALL EXISTING UTILITIES. MAKE INVESTIGATIONS FOR DETERMINING THE EXACT LOCATION, SIZE, AND TYPE MATERIAL OF THE EXISTING FACILITIES AS NECESSARY FOR THE CONSTRUCTION OF THE PROPOSED UTILITIES AND FOR AVOIDING DAMAGE TO EXISTING FACILITIES. REPAIR ANY DAMAGE INCURRED TO EXISTING FACILITIES TO THE ORIGINAL OR BETTER CONDITION AT NO ADDITIONAL COST TO THE DEPARTMENT.
7. MAKE FINAL CONNECTIONS OF THE NEW WORK TO THE EXISTING SYSTEM WHERE INDICATED ON THE PLANS, AS REQUIRED TO FIT THE ACTUAL CONDITIONS, OR AS DIRECTED.
8. MAKE CONNECTIONS BETWEEN EXISTING AND PROPOSED UTILITIES AT TIMES MOST CONVENIENT TO THE PUBLIC, WITHOUT ENDANGERING THE UTILITY SERVICE, AND IN ACCORDANCE WITH THE UTILITY OWNER'S REQUIREMENTS. MAKE CONNECTIONS ON WEEKENDS, AT NIGHT, AND ON HOLIDAYS IF NECESSARY.
9. ALL UTILITY MATERIALS SHALL BE APPROVED PRIOR TO DELIVERY TO THE PROJECT. SEE 1500-7, "SUBMITTALS AND RECORDS" IN SECTION 1500 OF THE STANDARD SPECIFICATIONS.
10. JOHNSTON COUNTY SHALL BE PROVIDED WITH TWO COPIES OF SURVEYED AS-BUILTS OF THE INSTALLED UTILITY. THE AS-BUILTS SHALL INCLUDE NOTATIONS OF THE SIZE AND TYPE OF MATERIAL INSTALLED; GPS COORDINATES OF ALL: FITTINGS, UTILITY CONTROLS, AND THE HORIZONTAL AND VERTICAL LOCATIONS OF THE PIPING. PROVIDE BORING LOGS FROM TRENCHLESS INSTALLATIONS.

RELEASE FOR
 CONSTRUCTION
 DATE: 11/15/2023

PROJECT SPECIFIC NOTES

1. CONTRACTOR SHALL FULLY INSTALL, PRESSURE & LEAKAGE TEST, AND CHLORINATE NEW WATER MAIN PRIOR TO CONNECTION TO EXISTING SYSTEM.
2. CONTRACTOR SHALL PERFORM THE CONNECTION DURING OFF PEAK HOURS WITH A MAXIMUM SHUT DOWN TIME OF FIVE HOURS. (12 PM MIDNIGHT TO 5 AM).
3. ANY WORK OR TEST PERFORMED WITHOUT NOTIFICATION AND CONTACT WITH TOWN OF CANTON FIELD INSPECTORS SHALL BE PERFORMED AT THE CONTRACTOR'S RISK. TESTING SHALL BE PERFORMED IN THE PRESENCE OF COUNTY PERSONNEL.
4. OPERATION OF EXISTING GATE VALVES SHALL BE DONE BY COUNTY OPERATIONS STAFF.
5. TIE NEW WATER MAIN INTO EXISTING. INSTALL THRUST BLOCKS AND RODDING AS REQUIRED.
6. NEW WATER MAIN SHALL NOT BE CONNECTED TO EXISTING MAIN WITHOUT PRIOR APPROVAL AND COORDINATION WITH COUNTY.
7. FOR NEW WATER MAIN CONNECTIONS, USE GRIP RING PIPE RESTRAINER AS REQUIRED.
8. NEW WATER MAIN SHALL BE INSTALLED WITH BOTH ELECTRONIC MARKER TAPE/ TRACER WIRE AND ELECTRONIC MARKER BALLS.

WATER INSTALLATION NOTES

1. STATION 10+00± TO STATION 10+34± SHALL BE 8" PVC SDR21, INSTALLED BY OPEN CUT METHOD.
2. STATION 10+34± TO STATION 13+34± SHALL BE 8" FUSIBLE PVC C900, INSTALLED BY DIRECTIONAL DRILL.
3. STATION 13+34± TO STATION 13+55± SHALL BE 8" PVC SDR21, INSTALLED BY OPEN CUT METHOD.

PROJECT REFERENCE NO. BP4.R028	SHEET NO. UC-3A
DESIGNED BY: PKP	11/15/2023
DRAWN BY: JDS	
CHECKED BY: PKP	
APPROVED BY: EGW	
REVISED:	
NORTH CAROLINA DEPARTMENT OF TRANSPORTATION	
UTILITIES ENGINEERING SEC. PHONE: (919) 707-6690 FAX: (919) 250-4151	UTILITY CONSTRUCTION PLANS ONLY
DOCUMENT NOT CONSIDERED FINAL UNLESS ALL SIGNATURES COMPLETED	
UTILITY CONSTRUCTION	

RELEASE FOR CONSTRUCTION
 DATE: 11/15/2023

TAPPING SLEEVE & VALVE ASSEMBLY
NOT TO SCALE

NOTES:

- TAPPING SLEEVE SHALL BE FABRICATED OF TYPE 304 OR 316 S.S. AND PROVIDE A 360° SEAL AROUND EXISTING PIPE WITH FULL CIRCUMFERENTIAL GASKET.
- TAPPING SLEEVE SHALL BE JCM 432, MUELLER H-304, FORD FTSS, ROMAC ST III OR APPROVED EQUAL.
- ALL MATERIALS USED IN THE POTABLE WATER SYSTEM MUST BE NSF61 AND NSF372 CERTIFIED AND MEET THE LATEST FEDERAL SAFE DRINKING WATER ACT REQUIREMENTS.

Drawn By: _____	Name _____	Date _____
Checked By: _____	JOHNSTON COUNTY	
Approved By: _____	Department of Public Utilities	
Scale: _____	P.O. Box 2263	Smithfield, NC 27577
Rev. Description Date Init.		

VALVE AND VALVE BOX INSTALLATION
NOT TO SCALE

NOTES:

- D.I.P. MAY BE USED FOR VALVE BOX EXTENSIONS.
- VALVE BOX SHOULD NOT CONTACT WATER MAIN OR VALVE.
- CONCRETE PROTECTOR RING SHALL BE USED IN ALL UNPAVED AREAS.
- ALL MATERIALS USED IN THE POTABLE WATER SYSTEM MUST BE NSF61 AND NSF372 CERTIFIED AND MEET THE LATEST FEDERAL SAFE DRINKING WATER ACT REQUIREMENTS.

Drawn By: _____	Name _____	Date _____
Checked By: _____	JOHNSTON COUNTY	
Approved By: _____	Department of Public Utilities	
Scale: _____	P.O. Box 2263	Smithfield, NC 27577
Rev. Description Date Init.		

VERTICAL BEND RODDING AND BLOCKING DETAIL
NOT TO SCALE

ROD REQUIREMENTS

SIZE OF 45° BEND	STATIC THRUST IN POUNDS	NUMBER OF RODS REQUIRED
6"	4,328	2
8"	7,694	2
12"	17,312	4
16"	30,779	6
20"	48,091	8
24"	69,252	10

GENERAL NOTES:

- RODS AND NUTS SHALL BE OF TYPE 304 OR TYPE 316 STAINLESS STEEL.
- CONCRETE SHALL NOT CONTACT BOLTS OR ENDS OF MECHANICAL JOINT BENDS.

Drawn By: _____	Name _____	Date _____
Checked By: _____	JOHNSTON COUNTY	
Approved By: _____	Department of Public Utilities	
Scale: _____	P.O. Box 2263	Smithfield, NC 27577
Rev. Description Date Init.		

THRUST BLOCK DETAIL
NOT TO SCALE

THRUST BLOCK SCHEDULE

PIPE SIZE	90° BEND		45° BEND		22 1/2° BEND		11 1/4° BEND		TEE			PLUG			
	A	B	A	B	A	B	A	B	A	B	C	D	A	B	C
4"	8"	12"	8"	8"	8"	8"	8"	8"	8"	8"	8"	8"	10"	10"	10"
6"	10"	15"	10"	10"	10"	10"	10"	10"	10"	10"	12"	12"	12"	12"	12"
8"	12"	18"	12"	12"	12"	12"	12"	12"	12"	12"	12"	12"	12"	12"	12"
10"	14"	21"	14"	14"	14"	14"	14"	14"	14"	14"	14"	14"	14"	14"	14"
12"	16"	24"	16"	16"	16"	16"	16"	16"	16"	16"	16"	16"	16"	16"	16"
14"	18"	28"	18"	18"	18"	18"	18"	18"	18"	18"	18"	18"	18"	18"	18"
16"	20"	32"	20"	20"	20"	20"	20"	20"	20"	20"	20"	20"	20"	20"	20"
18"	22"	36"	22"	22"	22"	22"	22"	22"	22"	22"	22"	22"	22"	22"	22"
20"	24"	40"	24"	24"	24"	24"	24"	24"	24"	24"	24"	24"	24"	24"	24"
24"	28"	48"	28"	28"	28"	28"	28"	28"	28"	28"	28"	28"	28"	28"	28"

Drawn By: _____	Name _____	Date _____
Checked By: _____	JOHNSTON COUNTY	
Approved By: _____	Department of Public Utilities	
Scale: _____	P.O. Box 2263	Smithfield, NC 27577
Rev. Description Date Init.		

HARNES RESTRAINT DETAIL
NOT TO SCALE

Drawn By: _____	Name _____	Date _____
Checked By: _____	JOHNSTON COUNTY	
Approved By: _____	Department of Public Utilities	
Scale: _____	P.O. Box 2263	Smithfield, NC 27577
Rev. Description Date Init.		

PIPE LAYING CONDITION
NOT TO SCALE

Drawn By: _____	Name _____	Date _____
Checked By: _____	JOHNSTON COUNTY	
Approved By: _____	Department of Public Utilities	
Scale: _____	P.O. Box 2263	Smithfield, NC 27577
Rev. Description Date Init.		

THRUST COLLAR INSTALLATION
NOT TO SCALE

THRUST COLLAR SCHEDULE

PIPE DIAMETER	CONCRETE THRUST COLLAR		ANCHOR COLLAR	RINGS REQUIRED
	A	B		
6"/8"/12"	14"	14"	2"	ONE
16"	14"	14"	2"	ONE
20"	14"	14"	3"	ONE
24"	14"	14"	3"	TWO
30"	14"	14"	4"	TWO
36"	14"	14"	4"	TWO

Drawn By: _____	Name _____	Date _____
Checked By: _____	JOHNSTON COUNTY	
Approved By: _____	Department of Public Utilities	
Scale: _____	P.O. Box 2263	Smithfield, NC 27577
Rev. Description Date Init.		

8.17.7/99

RELEASE FOR CONSTRUCTION
DATE: 11/15/2023


ETHERILL ENGINEERING
 1223 Jones Franklin Rd.
 Raleigh, N.C. 27606
 License No. F-0377
 Bus: 919 851 8077
 Fax: 919 851 8107

TRANSPORTATION PLANNING/DESIGN - BRIDGE/STRUCTURE DESIGN
 CIVIL/SITE DESIGN - GIS/GPS - SURVEY/SUE - UTILITIES - CONSTRUCTION OBSERVATION

PROJECT REFERENCE NO. BP4.R028	SHEET NO. UC-4
DESIGNED BY: <i>PKP</i>	11/15/2023
DRAWN BY: <i>JDS</i>	
CHECKED BY: <i>PKP</i>	
APPROVED BY: <i>EGW</i>	
REVISD:	
NORTH CAROLINA DEPARTMENT OF TRANSPORTATION	
UTILITIES ENGINEERING SEC. PHONE: (919) 707-6690 FAX: (919) 250-4151	UTILITY CONSTRUCTION PLANS ONLY

DOCUMENT NOT CONSIDERED FINAL UNLESS ALL SIGNATURES COMPLETED

UTILITY CONSTRUCTION

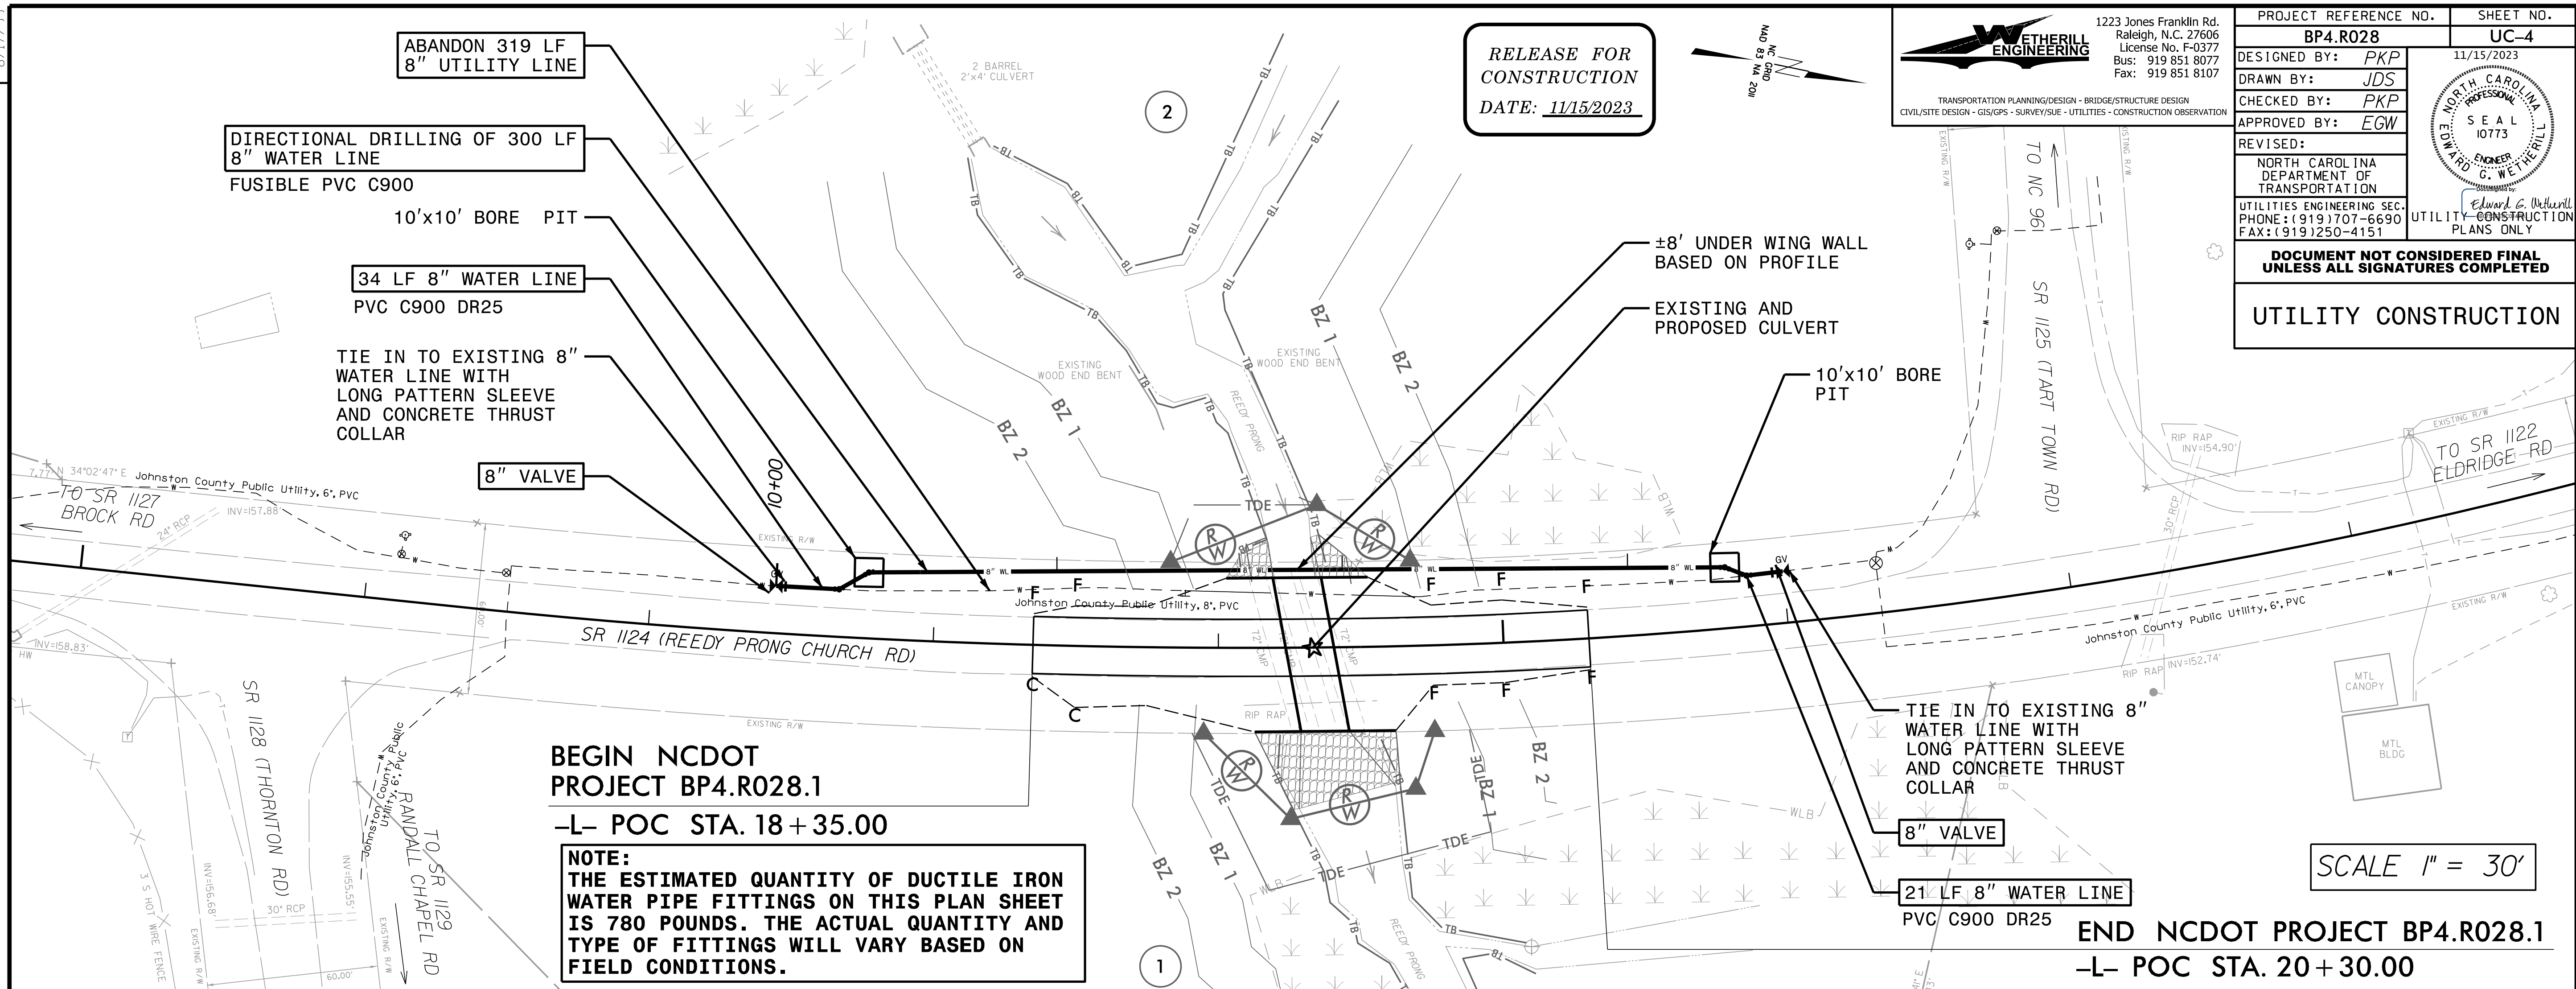


BEGIN NCDOT PROJECT BP4.R028.1
 -L- POC STA. 18+35.00

NOTE:
 THE ESTIMATED QUANTITY OF DUCTILE IRON WATER PIPE FITTINGS ON THIS PLAN SHEET IS 780 POUNDS. THE ACTUAL QUANTITY AND TYPE OF FITTINGS WILL VARY BASED ON FIELD CONDITIONS.

SCALE 1" = 30'

END NCDOT PROJECT BP4.R028.1
-L- POC STA. 20+30.00

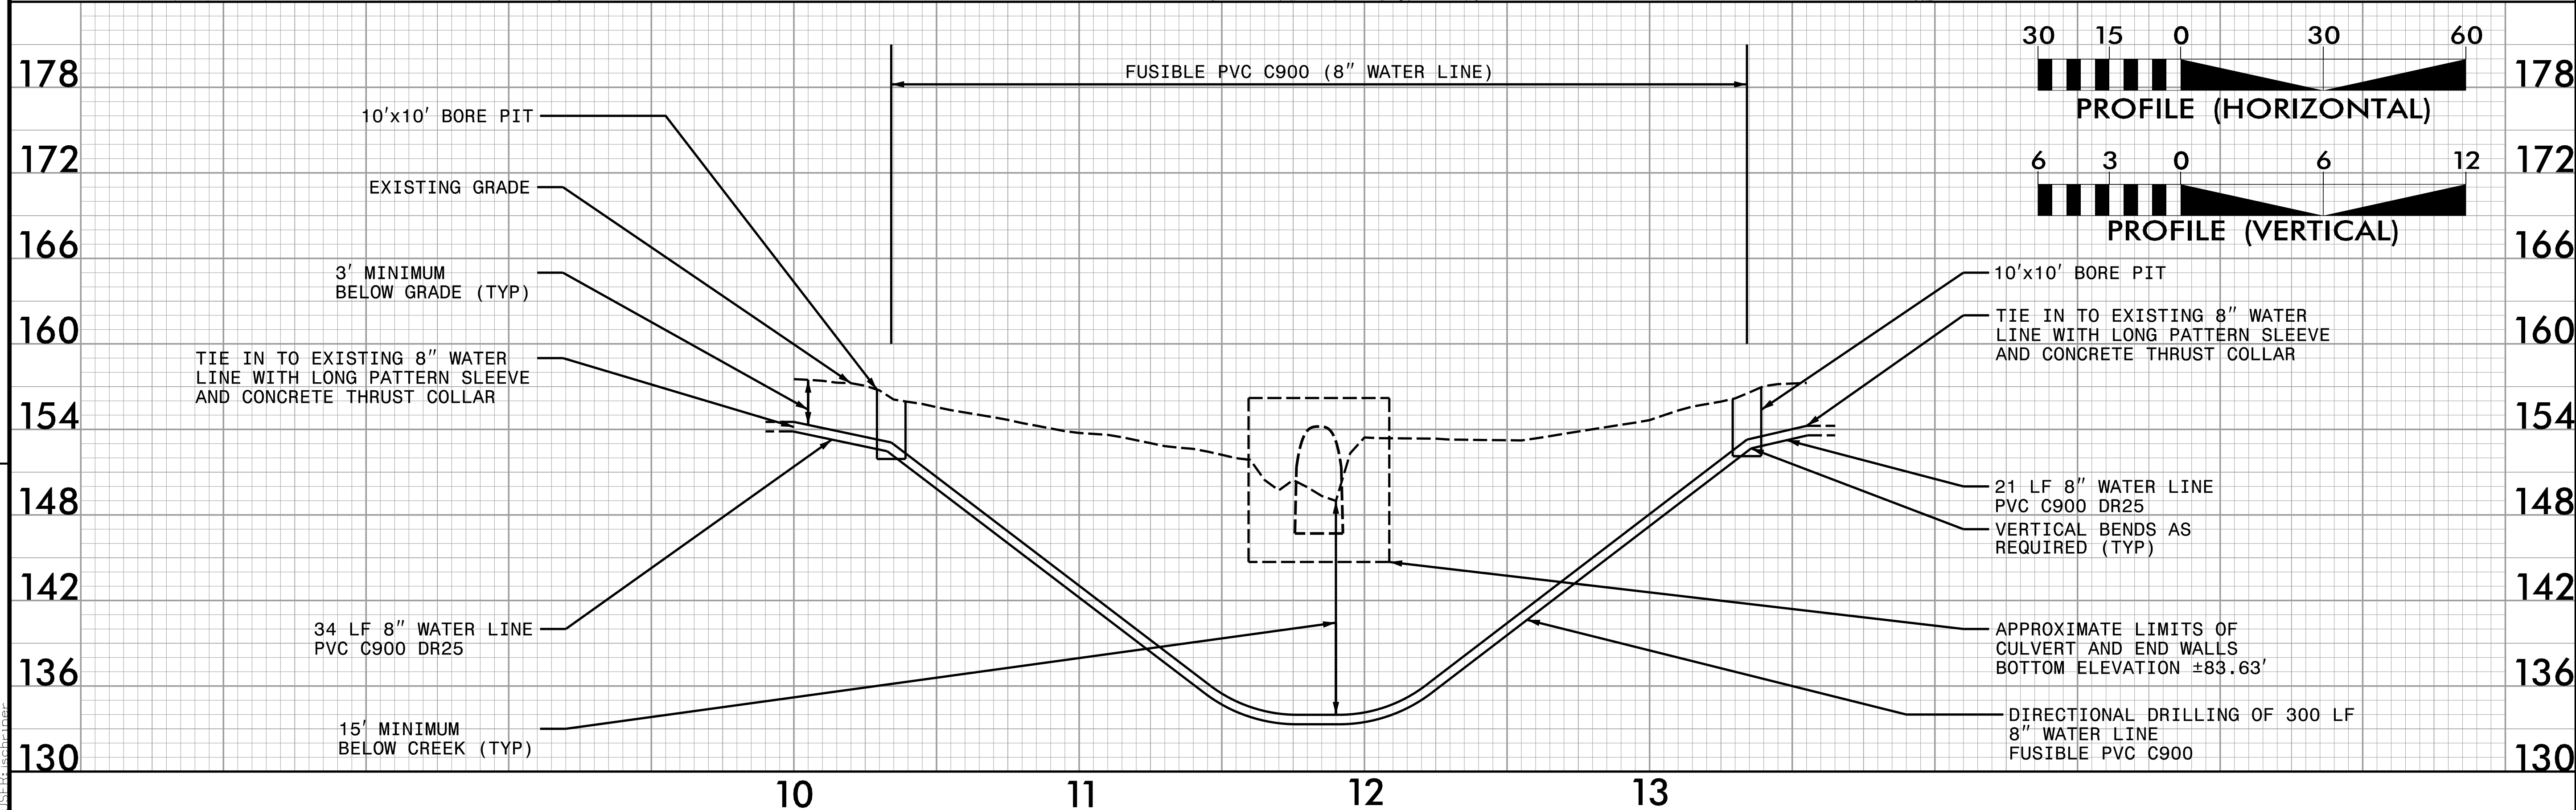

REVISIONS

11/15/2023 BP4.R028.ut-UC-4_PSH.dgn

