Plan for the Proposed

I-5404


US HWY 70 BUSINESS (Market Street) Roadway Improvements


Smithfield, North Carolina
Johnston County

Type of Work: Grading, Paving, Drainage, Erosion Control, Pavement Marking, Signing & Traffic Control April 13, 2011

AREA A



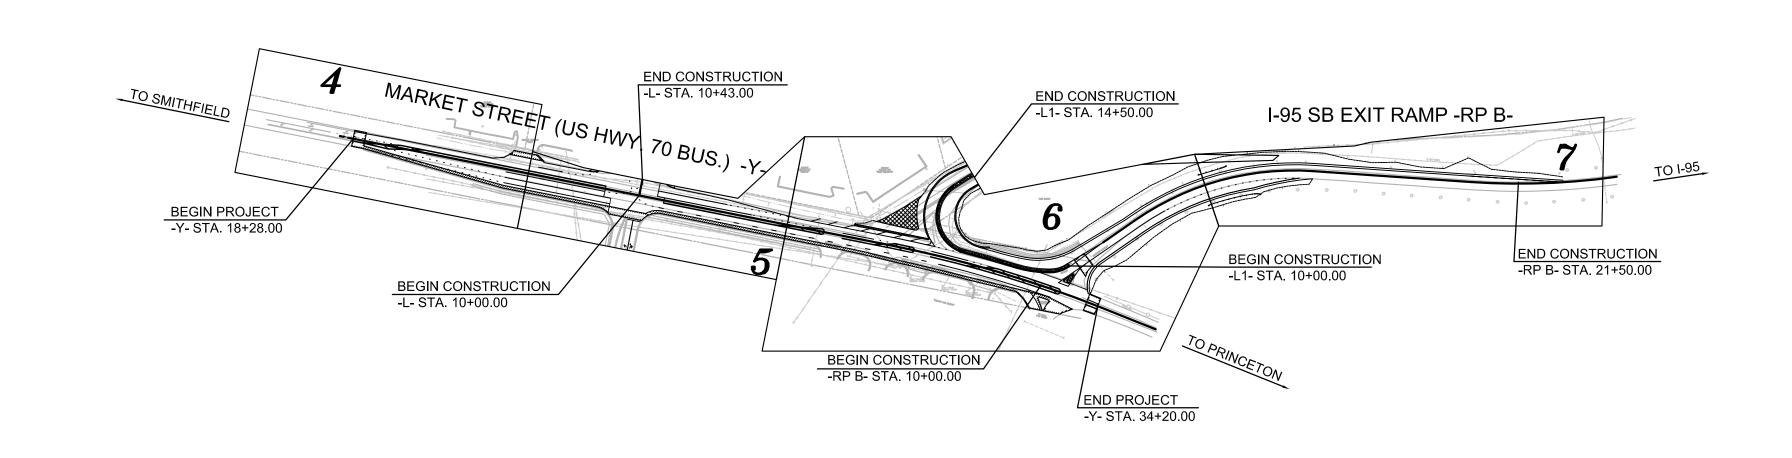

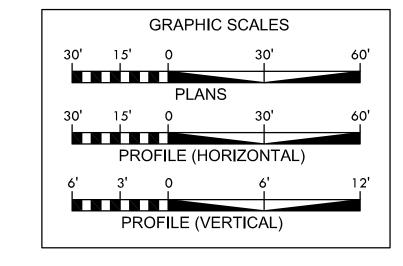

PROJECT LENGTH

LENGTH ROADWAY -L- = 0.008 mi.

TOTAL LENGTH OF TIP PROJECT I-5404 = 0.008 mi.

DESIGN DATA

ADT 2005 = 17,200

ADT 2031 = 37,100

DHV = 10%


D = 60%

T = 5%

V = 40 mph

* TTST 2% DUAL 3%

THIS PROJECT IS TO BE CONSTRUCTED IN ACCORDANCE WITH THE NORTH CAROLINA DEPARTMENT OF TRANSPORTATION STANDARD SPECIFICATIONS FOR ROADS AND STRUCTURES BOOK, DATED JULY 2006, AND THE NORTH CAROLINA DEPARTMENT OF TRANSPORTATION ROADWAY STANDARD DRAWINGS, DATED JULY 2006.

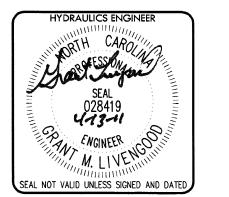

DRAINAGE & EROSION CONTROL DESIGN BY:



ROADWAY ENGINEER

CAROL

SESSION

SEAL

244 16

CONTINUE

SCOTT

GRADING, PAVING, PAVEMENT MARKING, SIGNING & TRAFFIC CONTROL DESIGN BY:



Faringdon Place, Suite 100
Raleigh, NC 27609
P: 919.872.5115 F: 919.878.5416
www. rameykemp.com

SHEET 1B SURVEY INFORMATION SHEETS 2 thru 2B TYPICAL SECTIONS SHEETS 2C thru 2E MISCELLANEOUS DETAILS

SHEET 3-A DRAINAGE, GUARDRAIL, AND LUMP SUM GRADING SUMMARY

SHEETS 4 thru 7 ROADWAY PLAN, STORM DRAINAGE & PROFILE

SHEETS D-1 thru D-4 **ROADWAY & DRAINAGE DETAIL SHEETS**

SHEETS EC-1 thru EC-2 EROSION CONTROLS SHEETS PM-1 thru PM-4 PAVEMENT MARKING PLANS

SHEETS S-1 thru S-14 SIGNING PLANS

SHEETS X-7 hru X-9 **CROSS SECTIONS**

UTILITY CONTACTS:

Planning Department Town Hall - Town of Smithfield 350 E. Market St. Smithfield, NC 27577 P: 919.934.2116 ext. 1114 Contact: Paul Embler, Planning Director

Smithfield Public Utilities Dept.

Town of Smithfield **Operations Center** 230 Hospital Rd. Smithfield, NC 27577 P: 919.934.2798

Electric

Progress Energy 221 US Hwy. 70 E. Selma, NC 27576 P: 919.965.9264

Town of Smithfield **Operations Center** 230 Hospital Rd. Smithfield, NC 27577 P: 919.934.2230 Contact: Rodney Johnson

Call " NC ONE CALL" BEFORE YOU DIG: 1-800-632-4949



Natural Gas

Piedmount Natural Gas 5520 Dillard Dr. Suite 240 Cary, NC 27518 P: 919.235.6005 Contact: Ed Lyman

Water & Sewer Town of Smithfield **Operations Center** 230 Hospital Rd. Smithfield, NC 27577 P: 919.934.2438

Contact: Danny Baker

Telephone

Embarq 1330 E Broad Street Fuquay Varina, NC 27526 P: 919.552.0900

Cable Television


Time Warner Cable 114 US Hwy 70 W. Selma, NC 27576 P: 866.489.2669

NCDOT


Highway Division 4 509 Ward Blvd. Wilson, NC 27895 Contact: Bobby Lewis, PE P: 252.237.6164

LIST OF APPLICABLE NORTH CAROLINA DEPARTMENT OF TRANSPORTATION STANDARD DRAWINGS

200.02 METHOD OF CLEARING - METHOD II GUIDE FOR GRADING SUBGRADE - INTERSTATE AND FREEWAY GUIDE FOR GRADING SUBGRADE - SECONDARY AND LOCAL METHOD OF OBTAINING SUPERELEVATION - TWO LANE PAVEMENT METHOD OF GRADING SIGHT DISTANCE AT INTERSECTIONS 225.06 ASPHALT SHOULDERS - MILLED RUMBLE STRIPS 700.05 TYING PROPOSED PAVEMENT TO EXISTING PAVEMENT BRICK CATCH BASIN 12" THRU 54" PIPE 840.02 CONCRETE CATCH BASIN 840.03 FRAME, GRATES, AND HOOD 840.14 CONCRETE DROP INLET BRICK DROP INLET 12" THRU 30" PIPE DROP INLET FRAME AND GRATES 840.1*7* CONCRETE GRATED DROP INLET TYPE 'A' FRAMES AND WIDE SLOT SAG GRATES BRICK GRATED DROP INLET TYPE 'A' - 12" THRU 72" PIPE 840.31 CONCRETE JUNCTION BOX 840.32 BRICK JUNCTION BOX PRECAST MANHOLE 4', 5', AND 6' DIAMETER MANHOLE FRAME AND COVER 840.71 CONCRETE AND BRICK PIPE PLUG CONCRETE CURB, GUTTER AND CURB & GUTTER 848.01 CONCRETE SIDEWALK 848.02 DRIVEWAY TURNOUT 848.04 STREET TURNOUT 848.05 WHEELCHAIR RAMP CONCRETE ISLANDS METHOD FOR PLACEMENT OF DROP INLETS IN GRASSED MEDIAN MEDIAN CURB FOR CATCH BASIN METHOD FOR PLACEMENT OF DROP INLETS IN CONCRETE ISLANDS MEDIAN CONSTRUCTION - WITH CURB AND GUTTER GUARDRAIL PLACEMENT GUARDRAIL INSTALLATION 862.03 STRUCTURE ANCHOR UNITS 866.02 WOVEN WIRE FENCE - WITH WOOD POST 901.10 TYPE 'A' SIGNS TYPE 'B' SIGNS VHB TAPE CONSTRUCTION - FOR TYPE 'A' SIGNS VHB TAPE CONSTRUCTION - FOR TYPE 'B' SIGNS ARROWS AND SHIELDS SIGN STRINGERS AND SUPPORT SPACING SIGN MOUNTING DETAILS - FOR TYPE 'A' AND TYPE 'B' SIGNS GROUND MOUNTED SIGN SUPPORTS 903.20 WOOD SIGN SUPPORTS ORIENTATION OF GROUND MOUNTED SIGNS 1101.01 WORK ZONE ADVANCE WARNING SIGNS 1101.02 TEMPORARY LANE CLOSURES 1101.03 TEMPORARY ROAD CLOSURES 1101.04 TEMPORARY SHOULDER CLOSURES 1101.11 TRAFFIC CONTROL DESIGN TABLES 1110.01 STATIONARY WORK ZONE SIGNS - MOUNTING HEIGHT & LATERAL CLEARANCE 1110.02 PORTABLE WORK ZONE SIGNS - MOUNTING HEIGHT & LATERAL CLEARANCE 1115.01 FLASHING ARROW PANELS 1130.01 DRUM 1135.01 CONES 1145.01 BARRICADES - TYPE III 1150.01 FLAGGING DEVICES 1205.01 PAVEMENT MARKINGS - LINE TYPES AND OFFSETS 1205.02 PAVEMENT MARKINGS - DIVIDED AND UNDIVIDED ROADWAYS 1205.04 PAVEMENT MARKINGS - INTERSECTIONS 1205.05 PAVEMENT MARKINGS - TURN LANES 1205.06 PAVEMENT MARKINGS - THRU LANE DROPS 1205.07 PAVEMENT MARKINGS - PEDESTRIAN CROSSWALKS 1205.08 PAVEMENT MARKINGS - SYMBOLS AND WORD MESSAGES 1205.09 PAVEMENT MARKINGS - PAINTED ISLANDS 1250.01 PAVEMENT MARKER SPACING 1251.01 RAISED PAVEMENT MARKERS - PERMANENT AND TEMPORARY 1261.01 GUARDRAIL AND BARRIER DELINEATOR SPACING 1261.02 GUARDRAIL AND BARRIER DELINEATOR TYPES 1262..01 GUARDRAIL END DELINEATION 1264.01 OBJECT MARKERS 1264.02 PLACEMENT OF OBJECT MARKERS 1605.01 TEMPORARY SILT FENCE

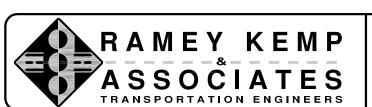

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Smithfield Crossings Roadway Improvements Smithfield, North Carolina

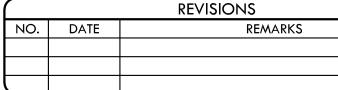SHEET INDEX, UTILITY CONTACTS & STANDARD DRAWINGS

1607.01 GRAVEL CONSTRUCTION ENTRANCE

SCALE N.T.S.

DATE: 02/04/1 DWN BY: CHKD BY:

07098

ROADWAY ENGINEER

PROJECT NO. SHEET NO. DRAWING SmCr_SURV01

NOTES:

- 1. TOPOGRAPHIC SURVEY PERFORMED BY:
 STEPHEN R. WOLFE, PLS
 NC PLS # 3259
 JOYNER KEENY, PLLC
 P.O. BOX 7533
 209 NORTH PEARL STREET
 ROCKY MOUNT, NORTH CAROLINA 27804
 252-977-3124 (OFFICE)
 252-985-6024 (FAX)
- 2. BOUNDARY SURVEY PERFORMED BY:
 JIMMY C. BARBOUR, PLS
 NC PLS # 2855
 JIMMY BARBOUR SURVEYING, PA
 P.O. BOX 28
 213 S. SECOND STREET
 SMITHFIELD, NORTH CAROLINA 27577
 919-989-6642 (OFFICE)
 919-989-6643 (FAX)
- 3. THE INITIAL COORDINATES FOR THIS PROJECT WERE PRODUCED FROM GPS OBSERVATIONS UTILIZING TRIMBLE R8 GNSS DUAL FREQUENCY RECEIVERS AND ARE BASED ON NORTH CAROLINA GEODETIC SURVEY MONUMENT (NCGS) STAMPED "JCC 1998" (PID DF9071) HAVING NAD83/2001 PUBLISHED POSITIONS OF NORTH 639181.92 FEET, EAST 2199405.54 FEET. COORDINATES SHOWN ARE LOCALIZED HOLDING THIS MONUMENT WITH AN AVERAGE COMBINED FACTOR OF 0.999880557 (GROUND TO GRID).
- 4. ELEVATION DATUM IS NAVD 1988 DATUM AND IS BASED ON NCGS MONUMENT "JOH 26" WITH A PUBLISHED ELEVATION OF 151.86 FEET.
- 5. THERE HAS BEEN NO DETERMINATION OF WETLANDS OR HAZARDOUS WASTE ON THIS PROPERTY.
- 6. SURVEYOR DOES NOT GUARANTEE THAT ALL UNDERGROUND STRUCTURES SUCH AS UTILITIES, TANKS, AND PIPES ARE LOCATED HEREON.
- 7. DATE OF (TOPOGRAPHIC) FIELD SURVEY: 15 JAN 2008 THRU 20 FEB 2008 16 APR 2008 THRU 29 APR 2008 09 JUL 2008 THRU 30 JUL 2008
- 8. FIELD BOOK # 126, 163, 172 AND 173
- 9. 1 FOOT CONTOUR INTERVAL

LEGEND

R/W	ROAD RIGHT-OF-WAY
R/W MON.	RIGHT-OF-WAY MONUMENT
RCP	REINFORCED CONC. PIPE
NV	PIPE INVERT
X 153.24	TYPICAL GROUND SHOT
	OVERHEAD UTILITY WIRES
	PIPES (SIZE & MATERIAL AS SHOWN)
	FIBER OPTIC LINE
	GAS LINE
a magamagada salagi inaka a pagamaga ka da da maka salah naka salah maka salah mana a da da maka salah salah s	WATER LINE
	SANITARY SEWER LINE
	STORM DRAIN LINE
	TELEPHONE LINE
	FENCE (SIZE & MATERIAL AS SHOWN)
0.00 pd vjp//d.by//child Wilsonia Tibble ad Tible at Tibble at	UNDERGROUND ELECTRIC LINE
	WOODSLINE


SYMBOLS LEGEND


- > FES FLARED END SECTION
- ☆ LP LIGHT POLE
- WV WATER VALVE
- T.PED TELEPHONE PEDESTAL
- SIGN SIGN (INFORMATION SHOWN ON SIGN)
- FOC-SIGN FIBER OPTIC MARKER
- → FH FIRE HYDRANT
- WM WATER METER
- ☐ JB ELECTRIC JUNCTION BOX
- SAN.MH SANITARY SEWER MANHOLE
- O CO SEWER CLEAN OUT
- RBC REBAR AND CAP
- ∅ POLE POWER POLE
- TLP TRAFFIC LIGHT POLE
- **TO PPT POWER POLE WITH TRANSFORMER**
- GUY GUY WIRE
- TEL.MH TELEPHONE MAN HOLE
- TRAFFIC LIGHT SIGNAL BOX
- MAILBOX
- FAUCET WATER FAUCET
- o BOLLARD
- CB CATCH BASIN
- POST 4" x 4" GUARD POST ± 3.8' HIGH
- D SD.MH STORM DRAIN MAN HOLE
- DI DROP INLET
- O EIP EXISTING IRON PIPE
- O SD SATELLITE DISH

REVISIONS
NO. DATE REMARKS

SCALE


PAVEMENT SCHEDULE PROP. APPROX. 1-1/2" ASPHALT CONCRETE SURFACE COURSE, TYPE S9.5B, AT AN AVERAGE RATE OF 168 LBS. PER SQ. YD. PROP. APPROX. 3" ASPHALT CONCRETE SURFACE COURSE, TYPE S9.5B. AT AN AVERAGE RATE OF 168 LBS. PER SQ. YD. IN EACH OF TWO LAYERS PROP. APPROX. 2" ASPHALT CONCRETE SURFACE COURSE, TYPE S9.5B, AT AN AVERAGE RATE OF 224 LBS. PER SQ. YD. PROP. APPROX. 1-1/2" STAMPED COLORED ASPHALT CONCRETE SURFACE COURSE, TYPE S9.5B, AT AN AVERAGE RATE OF 168 LBS. PER SQ. YD. PROP. VARIABLE DEPTH ASPHALT CONCRETE SURFACE COURSE, TYPE S9.5B, AT AN AVERAGE RATE OF 112 LBS. PER SQ. YD. PER 1" DEPTH, TO BE PLACED IN LAYERS NOT LESS THAN 1-1/2" IN DEPTH OR GREATER THAN 2" IN DEPTH. PROP. APPROX. 4" ASPHALT CONCRETE INTERMEDIATE COURSE, TYPE 119.0B. AT AN AVERAGE RATE OF 456 LBS. PER SQ.YD. PROP. VARIABLE DEPTH ASPHALT CONCRETE INTERMEDIATE COURSE, TYPE I19.0B, AT AN AVERAGE RATE OF 114 LBS. PER SQ. YD. PER 1" DEPTH, TO BE PLACED IN LAYERS NOT LESS THAN 2-1/2" IN DEPTH OR GREATER THAN 4" IN DEPTH. PROP. APPROX. 3" ASPHALT CONCRETE BASE COURSE, TYPE B25.0B, AT AN AVERAGE RATE OF 342 LBS. PER SQ. YD. PROP. APPROX. 5" ASPHALT CONCRETE BASE COURSE, TYPE B25.0B, AT AN AVERAGE RATE OF 570 LBS. PER SQ. YD. PROP. VARIABLE DEPTH ASPHALT CONCRETE BASE COURSE, TYPE B25.0B, AT AN AVERAGE RATE OF 114 LBS. PER SQ. YD. PER 1" DEPTH, TO BE PLACED IN LAYERS NOT LESS THAN 3" IN DEPTH OR GREATER THAN 5-1/2" IN DEPTH. PROPOSED 12" COMPACTED AGGREGATE BASE COURSE PROPOSED 8" COMPACTED AGGREGATE BASE COURSE 2'-6" CONCRETE CURB AND GUTTER 5" MONOLITHIC CONCRETE ISLAND (R3) 4" CONCRETE ISLAND COVER S 4" CONCRETE SIDEWALK (T) EARTH MATERIAL (COMPACTION REQUIRED) U EXISTING PAVEMENT (U1) EXISTING CURB AND GUTTER (V) MILLED RUMBLE STRIPS VARIABLE DEPTH ASPHALT PAVEMENT - APPLY AS NECESSARY (SEE WEDGING DETAIL ON SHEET 2)

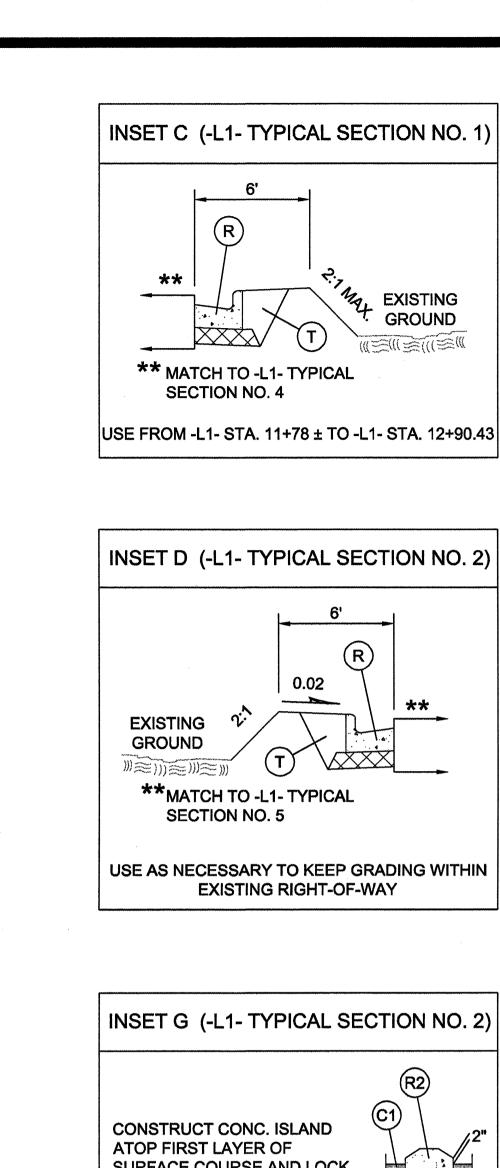


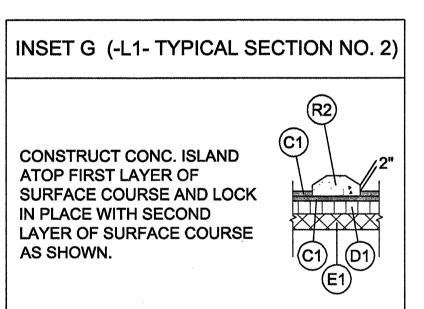


1/24 EXISTING


GROUND

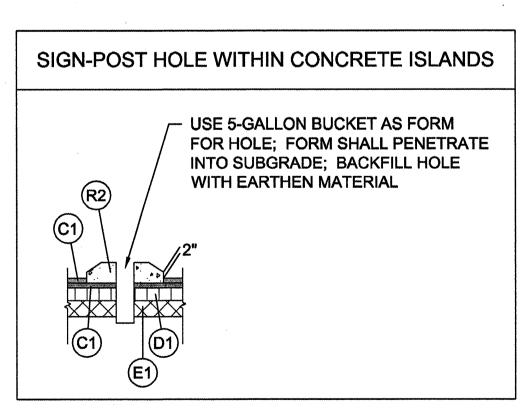

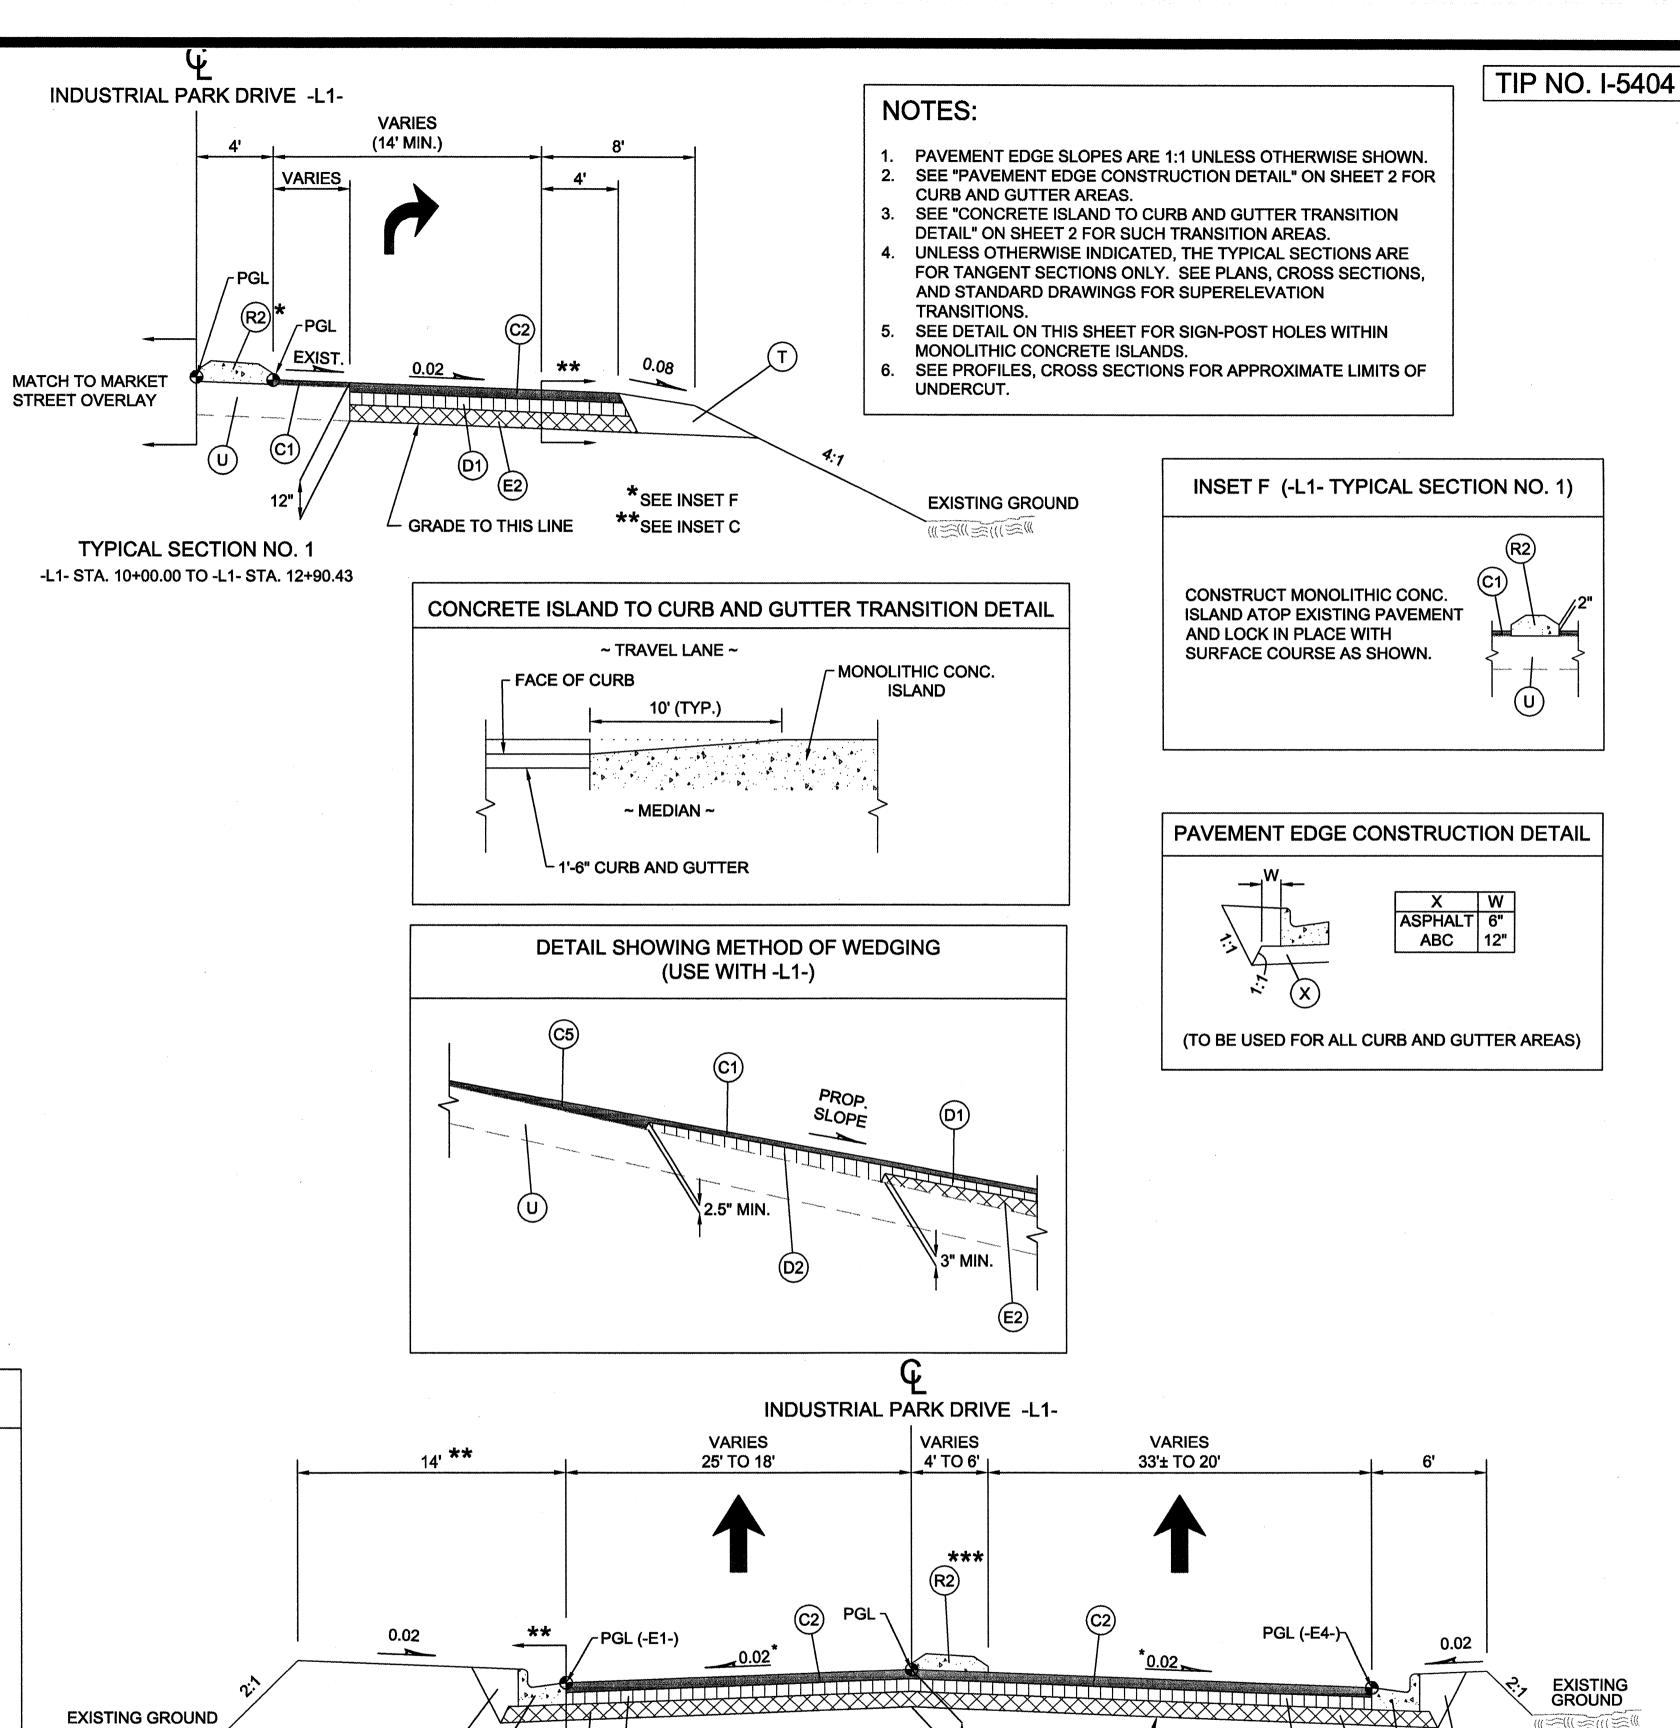

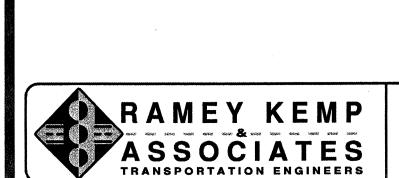



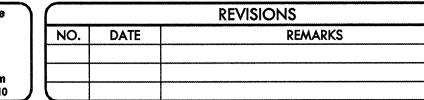

Smithfield Crossings Roadway Improvements Smithfield, North Carolina

DATE: 02/04/11

SCALE

N.T.S.


SHEET NO. PROJECT NO. 07098 DRAWING

SmCr_TYP01

SEE INSET D E2 R *SEE INSET G TYPICAL SECTION NO. 2 -L1- STA. 12+90.43 TO -L1- STA. 14+50 ☐ GRADE TO THIS LINE

TYPICAL SECTIONS

ROADWAY ENGINEER

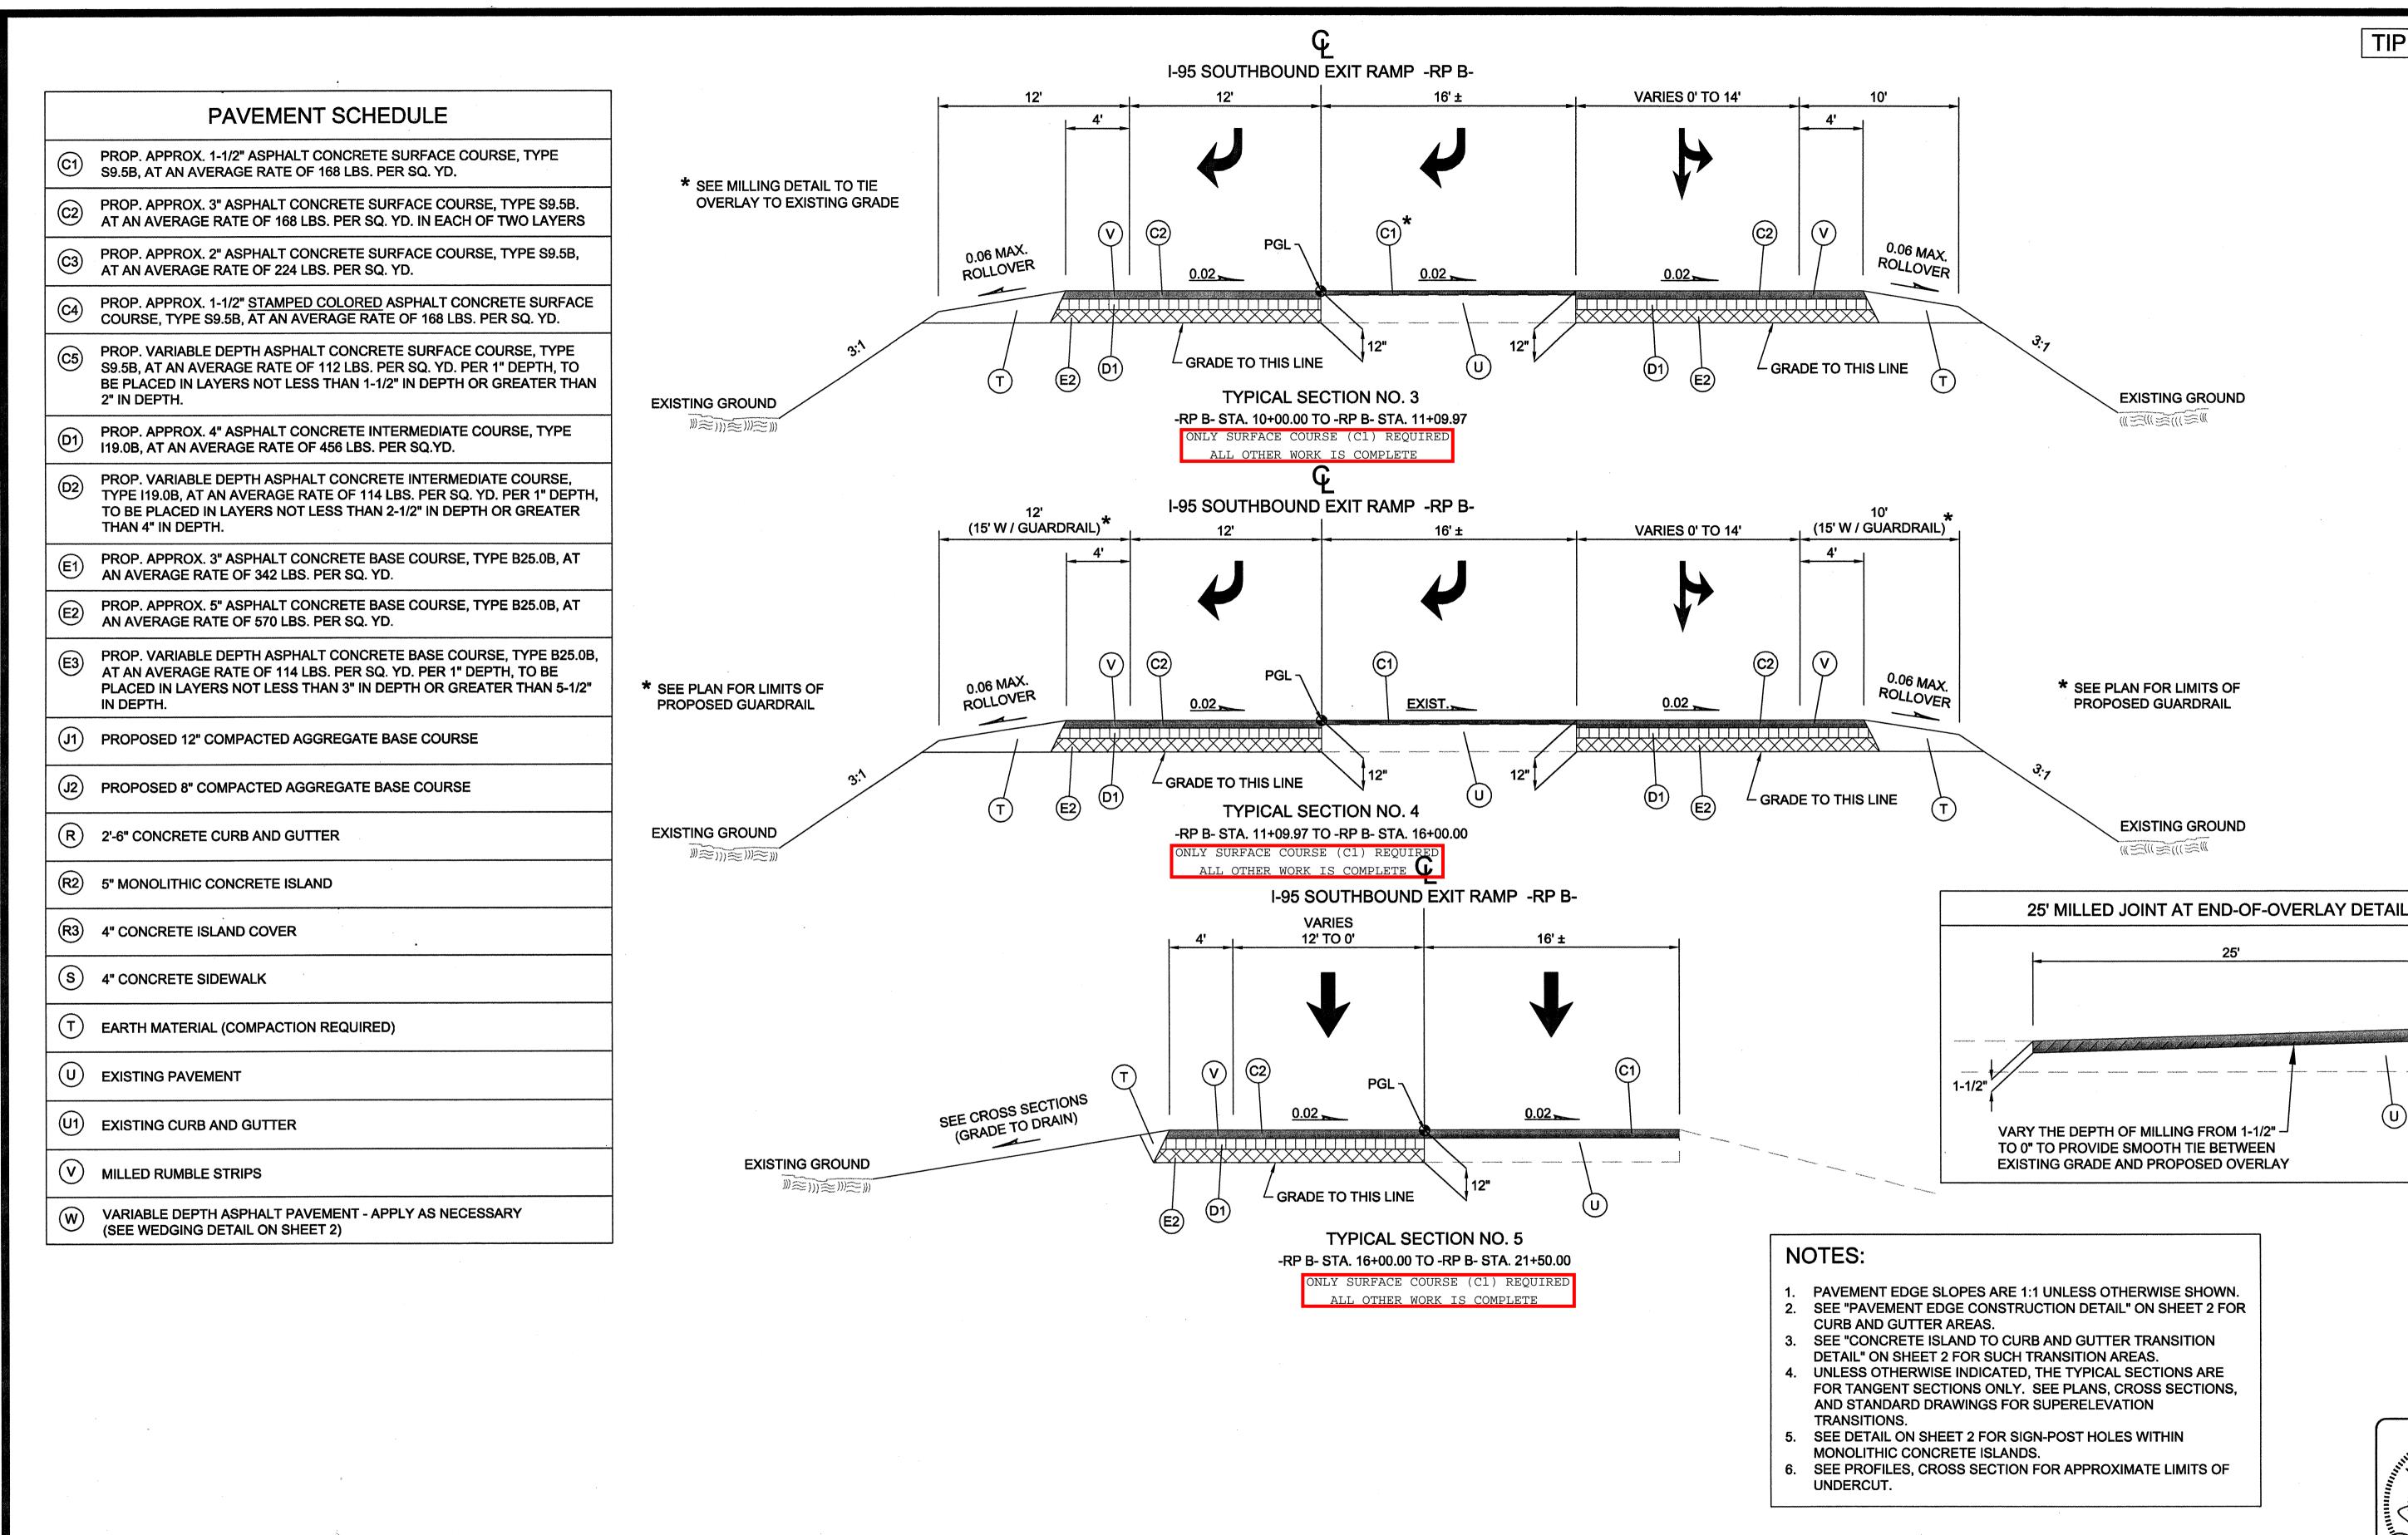



Raleigh, NC 27609 P: 919.872.5115 F: 919.878.5416 www.rameykemp.com

REVISIONS NO. DATE REMARKS

Smithfield, North Carolina

TYPICAL SECTIONS

SCALE

DATE: 02/04/11

PROJECT NO. 07098 **DRAWING**

SHEET NO. \$mCr_TYP01

ROADWAY ENGINEER

(C1)

TIP NO. I-5404


Smithfield Crossings Roadway Improvements

N.T.S.

DWN BY: JPS CHKD BY: MSC


PAVEMENT SCHEDULE

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- PROPOSED 12" COMPACTED AGGREGATE BASE COURSE
- J2 PROPOSED 8" COMPACTED AGGREGATE BASE COURSE
- 2'-6" CONCRETE CURB AND GUTTER
- 5" MONOLITHIC CONCRETE ISLAND
- R3 4" CONCRETE ISLAND COVER
- 4" CONCRETE SIDEWALK
- EARTH MATERIAL (COMPACTION REQUIRED)
- **EXISTING PAVEMENT**
- **EXISTING CURB AND GUTTER**
- MILLED RUMBLE STRIPS
- VARIABLE DEPTH ASPHALT PAVEMENT APPLY AS NECESSARY (SEE WEDGING DETAIL ON SHEET 2)

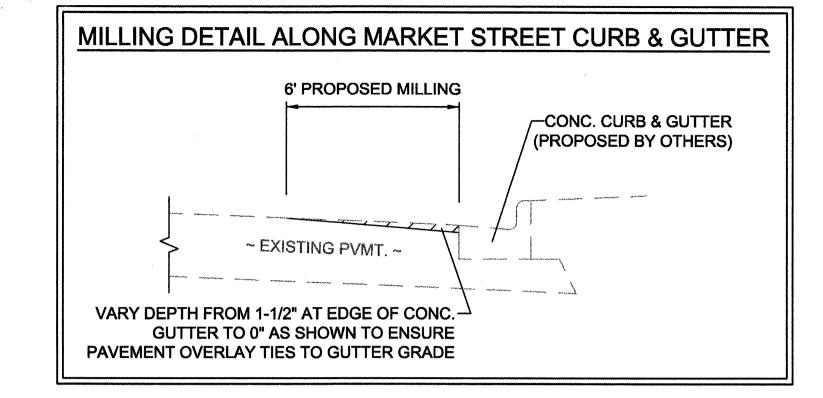

NOTES:

- 1. PAVEMENT EDGE SLOPES ARE 1:1 UNLESS OTHERWISE SHOWN. 2. SEE "PAVEMENT EDGE CONSTRUCTION DETAIL" ON SHEET 2 FOR
- **CURB AND GUTTER AREAS.**
- 3. SEE "CONCRETE ISLAND TO CURB AND GUTTER TRANSITION DETAIL" ON SHEET 2 FOR SUCH TRANSITION AREAS.
- 4. UNLESS OTHERWISE INDICATED, THE TYPICAL SECTIONS ARE FOR TANGENT SECTIONS ONLY. SEE PLANS, CROSS SECTIONS, AND STANDARD DRAWINGS FOR SUPERELEVATION TRANSITIONS.
- 5. SEE DETAIL ON SHEET 2 FOR SIGN-POST HOLES WITHIN MONOLITHIC CONCRETE ISLANDS.
- 6. SEE PROFILES, CROSS SECTIONS FOR APPROXIMATE LIMITS OF UNDERCUT.

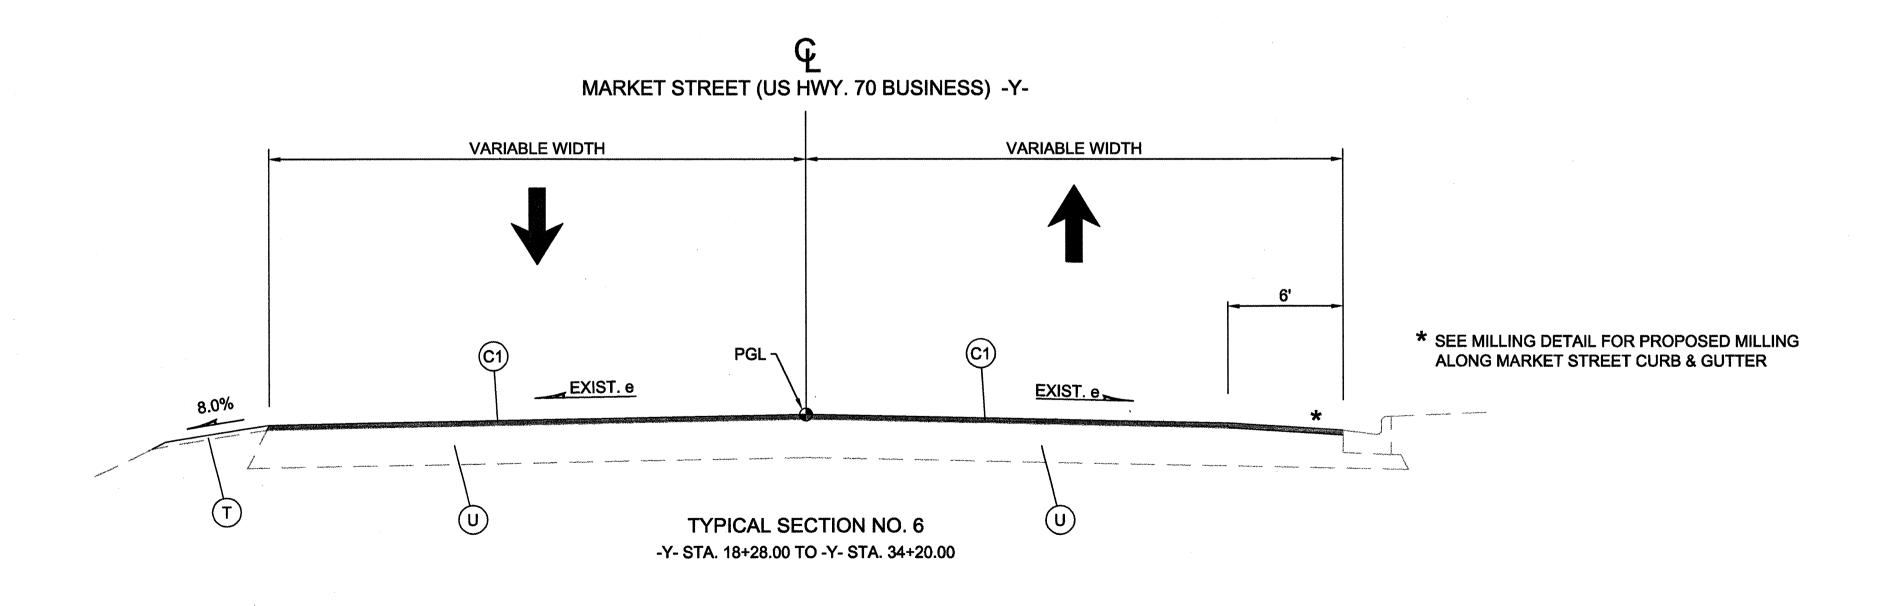



RAMEY KEMP

5808 Faringdon Place Suite 100 Raleigh, NC 27609 P: 919.872.5115 F: 919.878.5416 **REVISIONS** NO. DATE REMARKS

Smithfield Crossings Roadway Improvements Smithfield, North Carolina

TYPICAL SECTIONS

N.T.S.

SCALE


DATE: 02/04/11 DWN BY: JPS CHKD BY: MSC

PROJECT NO. DRAWING SmCr_TYP01

SHEET NO.

ASSOCIATES TRANSPORTATION ENGINEERS

PROJ. REFERENCE NO. SHEET NO 2-C

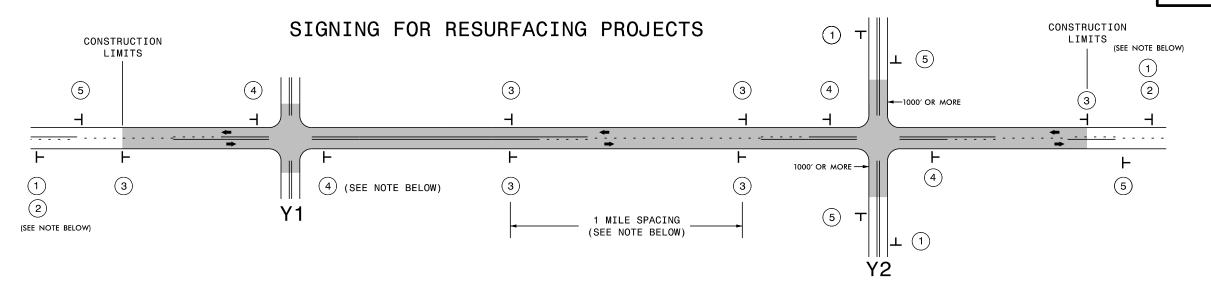

LEGEND

- STATIONARY SIGN

← DIRECTION OF TRAFFIC FLOW

MAINLINE (-L-) SIGNING

-Y- LINE SIGNING

PLACE 1000' PRIOR TO BEGINNING OF CONSTRUCTION LIMITS. ROAD ONLY USED ON -Y- LINES IF RESURFACING LIMITS EXTEND 1000' ALONG -Y- LINE. WORK NOTES AND PER DIRECTION AHEAD W20-1 #2 SIGN ONLY USED WHEN RESURFACING LIMITS ARE 2 OR MORE MILES IN LENGTH. (2) ROUND UP TO NEXT WHOLE NUMBER. (NO FRACTIONAL OR DECIMAL NUMBERS) PLACE INITIALLY AT THE CONSTRUCTION LIMITS AND SPACED 1 MILE APART LOW/SOFT (3) THEREAFTER. IF NO -Y- LINES EXIST, PLACE 2ND SET 1/2 MILE FROM THE SHOULDER CONSTRUCTION LIMITS AND THEN SPACE 1 MILE THEREAFTER. SIGNING PLACEMENT P THESE ARE FOR -Y- LINES THAT ARE "THROUGH" ROADWAYS. DEAD END AND SUBDIVISION ROADS ARE NOT "THROUGH" ROADWAYS. INSTALL 500' +/- FROM ROAD` EACH -Y- LINE APPROACH AS SHOWN ABOVE. FOR MULTIPLE -Y- LINES THAT (4) UNDER ARE SEPARATED BY 0.25 MILES OR LESS, TREAT AS A SINGLE UNIT AND INSTALL CONST/ WITHIN 500' OF EACH APPROACH. A MAXIMUM OF 2 SIGN SETS PER MILE. DO NOT INSTALL WHEN -Y- LINES ARE WITHIN 0.5 MILES FROM "END ROAD WORK" SIGN. PLACE 500' FOLLOWING THE END OF CONSTRUCTION LIMITS. ROAD WORK G20-2 A 48" X 24"

NO REQUIRED STATIONARY SIGNING FOR THE FOLLOWING -Y- LINE CONDITIONS:

- 1) LESS THAN 1000' OF RESURFACING ALONG -Y- LINE
- 2) SUBDIVISION ROADS
- 3) DEAD END ROADS

WHEN PAVING/CONSTRUCTION ACTIVITIES PROCEED ACROSS AN UNSIGNED -Y- LINE, ADVANCE WARNING PORTABLE SIGNS SHALL BE USED ALONG THE

-Y- LINE AS SHOWN BELOW. REMOVE UPON COMPLETION OF WORK.






PLACED 500' IN ADVANCE OF FLAGGER. PLACED 250' IN ADVANCE OF FLAGGER



RESURFACING ADVANCE WARNING SIGNS FOR RURAL AND SUBURBAN 2 LANE ROADWAYS

PROJ. REFERENCE NO. SHEET NO.

URBAN / SUBURBAN WORKZONES

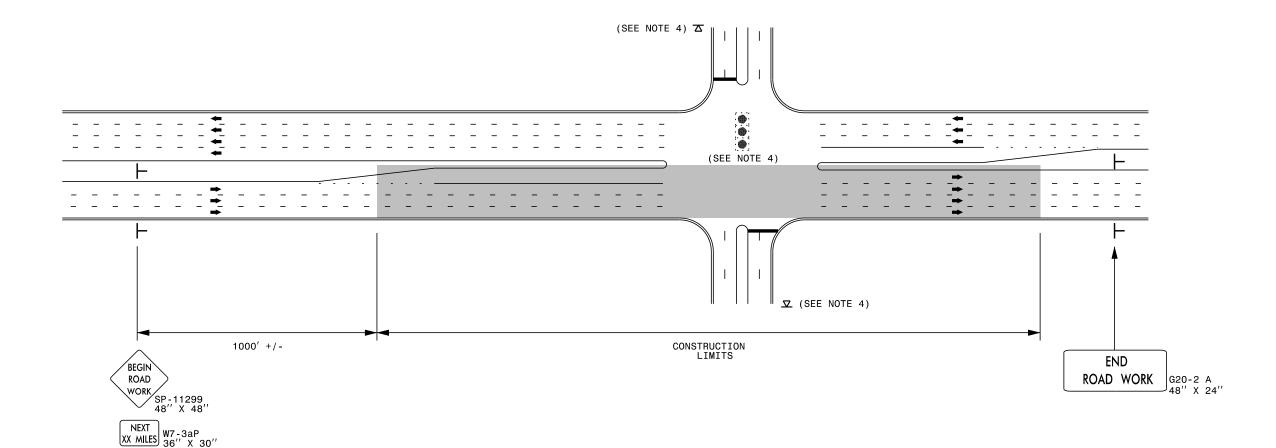


NOTES:

- 1) $48" \times 48"$ SIZED SIGNS (SP- 11299) MAY BE REDUCED TO $36" \times 36"$ ON ROADWAYS WITH SPEED LIMITS OF 40 MPH OR LESS.
- 2) MOUNT SIGNS THAT ARE LARGER THAN 10 SQUARE FEET IN AREA ON TWO OR MORE WOOD OR U-CHANNEL SUPPORTS. PERFORATED SQUARE TUBING SUPPORT SYSTEMS MAY SUPPORT LARGER AREAS ON A SINGLE SUPPORT. FOLLOW MANUFACTURER'S RECOMMENDATIONS. THESE SYSTEMS SHALL BE NCHRP 350 COMPLIANT AND NCDOT APPROVED.
- 3) ADVANCE WARNING SIGNS NOT REQUIRED ON NON-SIGNALIZED SIDE STREETS.
- 4) USE LAW ENFORCEMENT TO CONTROL TRAFFIC AT SIGNALIZED INTERSECTIONS AND PROVIDE PORTABLE "ROAD WORK AHEAD" (W20-1) SIGNS 500' IN ADVANCE ALONG BOTH APPROACHES FROM THE SIDE STREETS WHEN PAVING PROCEEDS THROUGH THE INTERSECTION.
- 5) LATERAL CLEARANCE AT ALL SIGN LOCATIONS SHALL BE 2' AS MEASURED FROM THE EDGE OF PAVEMENT OR THE FACE OF THE CURB. WHEN UNABLE TO OBTAIN THE LATERAL CLEARANCE WITHIN THE MEDIAN AREA USE SHOULDER MOUNTS ONLY.
- 6) SIGN MOUNT LOCATIONS SHALL NOT BLOCK SIDEWALKS OR DRIVEWAYS.
- 7) IF STATIONARY GENERAL WARNING SIGNS ARE USED, THEY WILL BE PAID FOR PER SECTION 104 OF THE NCDOT STANDARD SPECIFICATIONS AS EXTRA WORK.
- 8) IF MILLED AREAS ARE NOT PAVED BACK BY THE END OF THE WORK DAY, PORTABLE SIGNS SHALL BE USED TO WARN DRIVERS OF THE PRESENT CONDITIONS. THESE ARE TO INCLUDE, BUT NOT LIMITED TO "ROUGH ROAD" W8-8, "UNEVEN LANES" W8-11, "GROOVED PAVEMENT" W8-15 w/MOTORCYCLE PLAQUE MOUNTED BELOW. THESE ARE TO BE DOUBLE INDICATED ON MULTI-LANE ROADWAYS WITH SPEED LIMITS 45 MPH AND GREATER WHERE LATERAL CLEARANCE CAN BE OBTAINED WITHIN THE MEDIAN AREAS.THESE PORTABLE SIGNS ARE INCIDENTAL TO THE OTHER ITEMS OF WORK INCLUDED IN THE TEMPORARY TRAFFIC CONTROL (LUMP SUM) PAY ITEM.





RESURFACING ADVANCE WARNING SIGNS FOR URBAN / SUBURBAN FACILITIES

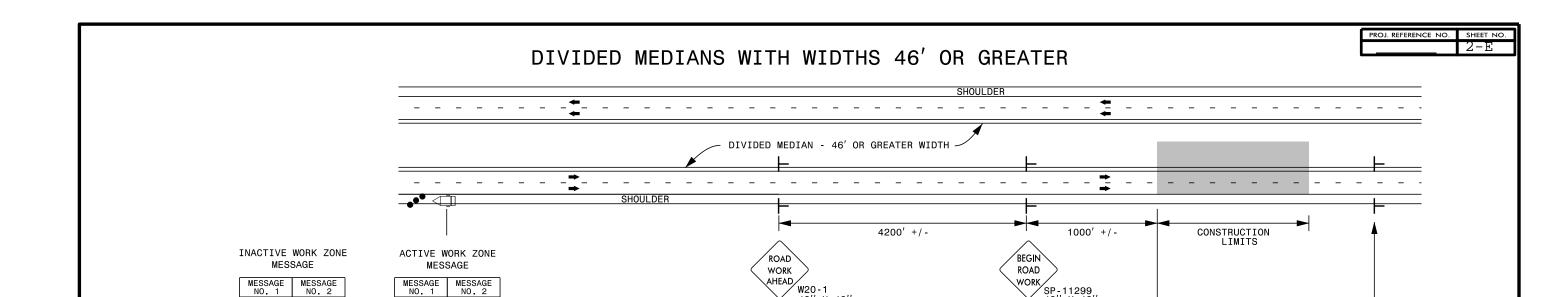

DIVIDED MEDIANS WITH WIDTHS LESS THAN 46' OR WITH PERMANENT MEDIAN BARRIER


2 MILES TO PROJECT LIMITS

W20-1

SP-11299 48'' X 48'

XX MILES W7-3aP 36" X 30"

NEXT

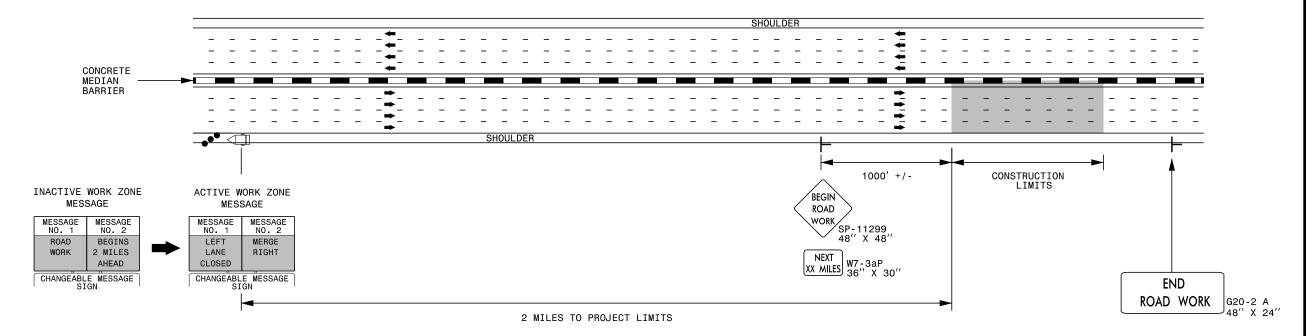

NOTES:

2 MILES

AHEAD

CHANGEABLE MESSAGE SIGN


MERGE

LEFT

CLOSED

CHANGEABLE MESSAGE SIGN

- 1) LATERAL CLEARANCE AT ALL SIGN LOCATIONS SHALL BE 6' AS MEASURED FROM THE EDGE OF PAVEMENT.
- 2) MOUNT SIGNS THAT ARE LARGER THAN 10 SQUARE FEET IN AREA ON TWO OR MORE WOOD OR U-CHANNEL SUPPORTS. PERFORATED SQUARE TUBING SUPPORT SYSTEMS MAY SUPPORT LARGER AREAS ON A SINGLE SUPPORT. FOLLOW MANUFACTURER'S RECOMMENDATIONS. THESE SYSTEMS SHALL BE NCHRP 350 COMPLIANT AND NCDOT APPROVED.
- 3) FOR MEDIAN WIDTHS LESS THAN 46' (MEASURED EDGELINE TO EDGELINE) USE THE BOTTOM DRAWING.
- 4) IF STATIONARY GENERAL WARNING SIGNS ARE USED, THEY WILL BE PAID FOR PER SECTION 104 OF THE NCDOT STANDARD SPECIFICATIONS AS EXTRA WORK.
- 5) INSTALL "ROAD WORK AHEAD" (W20-1) ALONG ENTRANCE RAMPS 500' PRIOR TO RAMP TERMINAL, AND "END ROAD WORK" (G20-2a) AT THE END OF EXIT RAMPS WITHIN THE WORK ZONE.
- 6) IF MILLED AREAS ARE NOT PAVED BACK BY THE END OF THE WORK DAY, PORTABLE SIGNS SHALL BE USED TO WARN DRIVERS OF THE PRESENT CONDITIONS. THESE ARE TO INCLUDE, BUT NOT LIMITED TO "ROUGH ROAD" W8-8, "UNEVEN LANES" W8-11, "GROOVED PAVEMENT" W8-15 w/MOTORCYCLE PLAQUE MOUNTED BELOW. THESE ARE TO BE DOUBLE INDICATED ON MULTI-LANE ROADWAYS WITH SPEED LIMITS 45 MPH AND GREATER AND WITH DIVIDED MEDIANS OF 46' OR GREATER. THESE PORTABLE SIGNS ARE INCIDENTAL TO THE OTHER ITEMS OF WORK INCLUDED IN THE TEMPORARY TRAFFIC CONTROL (LUMP SUM) PAY ITEM.

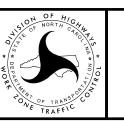

RESURFACING ADVANCE WARNING SIGNS FOR HIGH SPEED FACILITIES ≥ 60 MPH

END ROAD WORK

G20-2 A

LEGEND

DIRECTION OF TRAFFIC

CHANGEABLE MESSAGE

- STATIONARY SIGN

TRAFFIC DRUM

NOTE: Invert Elevations are for Bid Purposes only and shall not be used for project construction stakeout. See "Standard Specifications For Roads and Structures, Section 300-5".

STATE OF NORTH CAROLINA DIVISION OF HIGHWAYS

PROJECT REFERENCE NO. SHEET NO. 3-A

SUB-REGIONAL & REGIONAL LIST OF PIPES, ENDWALLS, ETC. (FOR PIPES 48" & UNDER)

STATION	N (LT,RT, OR CL)	STRUCTURE NO.	ATION	(ELEVATION	KIIICAL		DRAI (RCP, CS	INAGE PII P, CAAP,	PE HDPE)				C.S. P	PE			R.C. PII (CLASS	PE III)			R.C. PIPE (CLASS IV)		, CONTRACTOR DESIGN PIPE , CONTRACTOR DESIGN PIPE		STD. 838. STD. 838. OR STD. 838 (UNLES NOTEE OTHERW	.01, .11 .80 S	FOR STF * TOTAL	A Z QUANTITY SHALL BE COL.	2.840.02				TRANSITIONAL SECTION	D. 840.16		GRATE STD. 840.24 TWO GRATES STD. 840.24		DI IN CONCRETE	.METER (IN.)	3	G, C.Y. STD. 840.71		C.B. N.D.I. D.I. G.D.I. G.D.I.	CATO NARI DROI GRA	REVIATIONS CH BASIN ROW DROP INLET P INLET TED DROP INLET TED DROP INLET ROW SLOT)	
SIZE	OCATIO		OP ELEV		AVERT E	12"	15" 18'	24" 30"	36" 42'			٦. آث	12" 15"	18" 24	36" 42	2" 48" 1	15" 18"	24" 30"	36" 42"	48" 12	2" 15" 18	3" 24" 30"	36" 42"	48" (> SS	CULVERTS, C	H H	CU. YD	S. 5	_ —	В	OR STI					RATE ST	IH TWO	WE WITH	OR 840	CEMENT 2.06	7d NOI.		IPE PLUC	Fa. 5	J.B. M.H.	MAN	CTION BOX IHOLE	
THICKNESS OR GAUGE	ROM	5		= :						1 !	NOT USE RCP	끯ᆝ끯	.064	.064	920.	.109								i PPE	i Ple	DE DR		C.S.P.	E ∑	~	TD. 840.01	TYPE (OF GRATE	CH BASIN	P INLET	STD. 840.14 FRAME & G	FRAME W	N.S.) FRA/ (N.S.) FRA/	STD. 840.31	HOD OF PLAC	ED END SECT	0	C. & BRICK P	REMOVAL LIN	T.B.D. T.B.J.E		FIC BEARING DROP INLE	
											8 8	0 0												** ". R.	* * * * 	15" S 18" S		9	PER EA(5.0' TH	10.0'	C.B. S	E F	G	A DIA		N.D.I.	G.D.I. I	G.D.I	J.B. S	METH ISLAN	FLARI	Č	<u>x</u> 0	PIPE		RE	EMARKS	
-L1- 13+20	RT. 060)1	150.45																										1		1	1																
	RT. 060	0602	147	7.90 147	7.83		24'																																									
-L1- 12+85	RT. 060)2	150.27																									1	1		1	1																
	060	0603	147	7.94 147	7.83		36'																																									
-L1- 12+65	CL. 060)3	151.08																										1							1 1				1								
	060	0604	147	7.83 147	7.70		40'																																									
-L1- 12+10	RT. 060)4																																							15"							
-RP B - 11+15	LT. 060)5																																							18"							
	060.	5 0606	140	5.24 146	5.06		28	,																																								
											$\perp \! \! \perp$																														1 15	,						
TOTALS							100' 28																					3	3		2	2				1 1				1	1 - 15' 1 - 18'	"						

"N" = DISTANCE FROM EDGE OF LANE TO FACE OF GUARDRAIL.

TOTAL SHOULDER WIDTH = DISTANCE FROM EDGE OF TRAVEL LANE TO SHOULDER BREAK POINT.

FLARE LENGTH = DISTANCE FROM LAST SECTION OF PARALLEL GUARDRAIL TO END OF GUARDRAIL. W = TOTAL WIDTH OF FLARE FROM BEGINNING OF TAPER TO END OF GUARDRAIL.


G = GATING IMPACT ATTENUATOR TYPE 350

GUARDRAIL SUMMARY

110 – 11011	GATING IMPACT ATT	LINGATOR TITE 330		1			1															IMPACT REMOVE
SURVEY	DEC STA	EVID CTA	LOCATION		LENGTH		WARR.	ANT POINT	"N" DIST.	TOTAL	FLARE LENGTH		,	W			Al	NCHORS				ATTENUATOR SINGLE REMOVE AND
LINE	BEG. STA.	END STA.	LOCATION	STRAIGHT	SHOP CURVED	DOUBLE FACED	APPROACH END	TRAILING END	FROM E.O.L.	SHOUL. WIDTH	APPROACH END	TRAILING END	APPROACH END	TRAILING END	XI XI	GRAU 350	M-350	XIII	CAT-1	VI MOD	BIC AT-1	
-RP B-	13+93.75	15+18.75	RT.	125.00'			15+18.75		12'	15'	50'					1			1			
-RP B-	13+93.75	14+56.25	LT.	62.50'			14+56.25		12'	15'	50'					1			1			
SUBTOTAL				187.50'			DEDUCTION FOI	ANCHOR UNITS:														
DEDUCTIONS	FOR ANCHOR UNI	TS:		112.50'			2 GRAU-350 @	50.00' = 100.00'														
							2 CAT-1 @ 6.25	5' = 12.50'				10 ADDI1	TIONAL POSTS	ò								
								112.50'														
TOTAL				75.00'			PR	OJECT TOTAL														

UNCLASSIFIED EXCAVATION......250 CY BORROW EXCAVATION......1250 CY REM. OF EXISTING ASP. PAVEMENT......300 SY FINE GRADING......2550 SY

NOTE: APPROXIMATE QUANTITES ONLY. CLEARING AND GRUBBING, UNCLASSIFIED EXCAVATION, BORROW EXCAVATION, REMOVAL OF EXISTING ASPHALT PAVEMENT AND FINE GRADING WILL BE PAID FOR AT THE CONTRACT LUMP SUM PRICE FOR "GRADING"

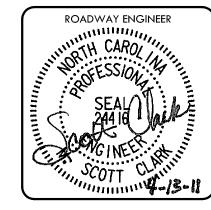



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		REVISIONS	
У О.	DATE	REMARKS	ı
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Smithfield Crossings Roadway Improvements Smithfield, North Carolina

QUANTITY SUMMARIES


SCALE	DATE: 02/
	DAIL: 02/
N.T.S.	DWN BY:
4.1.5.	CHKD BY:

PROJECT NO. 2/04/11 07098 DRAWING

SHEET NO. SmCr_SURV01

TIP NO. I-5404 NOTES: **LEGEND** STANDARD FEATURES 1. ALL RADIUS RETURN CALLOUTS ARE TO EDGE OF PROPOSED FULL-DEPTH 1) 2'-6" CURB & GUTTER (NCDOT STD. 846.01) PAVEMENT. PAVEMENT SECTION 2. SEE "MILLING DETAIL ALONG MARKET STREET 5' CONCRETE SIDEWALK (NCDOT STD. 848.01) CURB & GUTTER" ON SHEET 2 FOR MILLING AREAS. PROPOSED CONCRETE WHEELCHAIR RAMP (NCDOT STD. 848.05) PAVEMENT REMOVAL; GRADE, SEED & MULCH CURB CUT ONLY (FOR FUTURE WC RAMP) **OVERLAY ONLY** CONCRETE ISLAND COVER (NCDOT STD. 852.10) 5" MONOLITHIC CONC. ISLAND (VARIABLE WIDTH) (NCDOT STD. 852.01) PROPOSED PAVEMENT MILLING & OVERLAY

> **END PAVING** TIE TO EXISTING GRADE MILLING DEPTH VARIES 1-1/2" TO 0" TO MILLING DEPTH VARIES 1-1/2" TO 0" TO-TIE OVERLAY TO EXISTING GRADE TIE OVERLAY TO EXISTING GRADE -Y- STA. 10+28 BEGIN PROJECT **BEGIN PAVING** TIE TO EXISTING PAVEMENT MARKET STREET -Y-SEE MILLING DETAIL-(US HWY. 70 BUS.) MARKET STREET WIDENING AND IMPROVEMENTS PROPOSED BY OTHERS

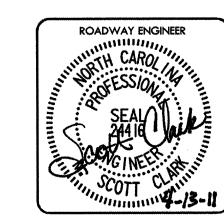

RAMEY KEMP

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REVISIONS NO. DATE **REMARKS**


Smithfield Crossings Roadway Improvements Smithfield, North Carolina


DATE: 02/04/11 CHKD BY: MSC


PROJECT NO. 07098 DRAWING SmCr_PLN01

SHEET NO.

ROADWAY IMPROVEMENT PLAN

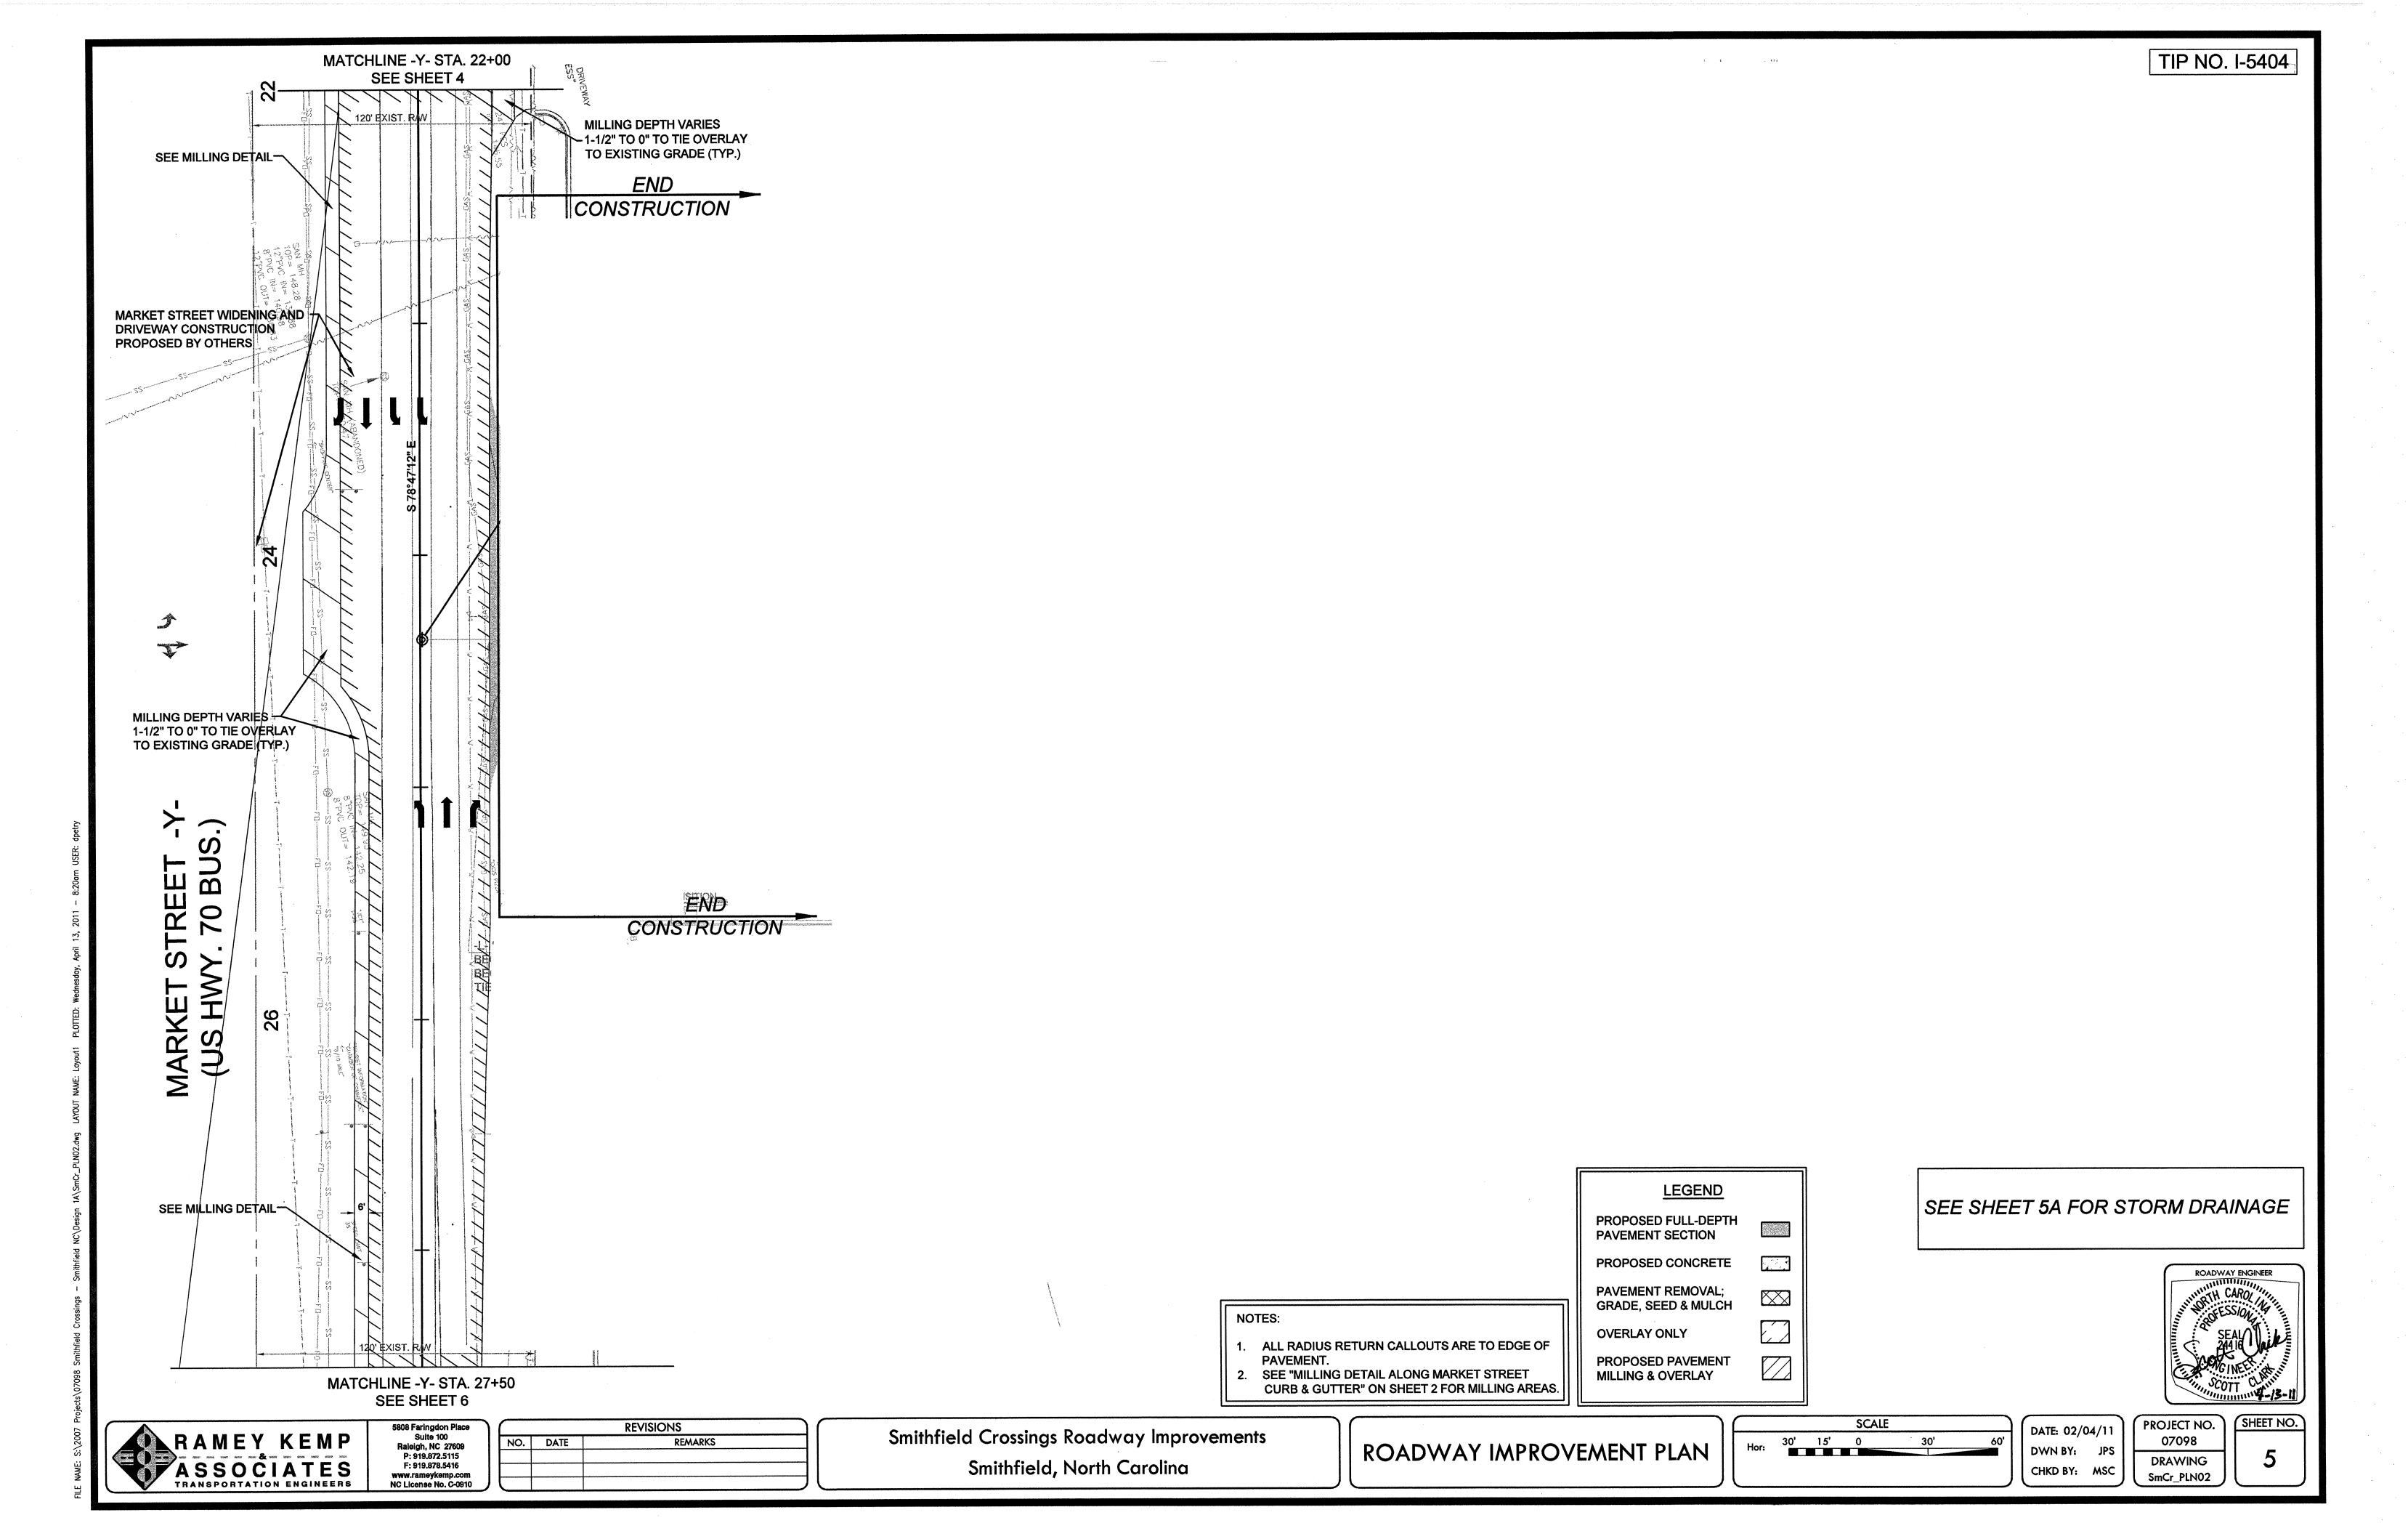

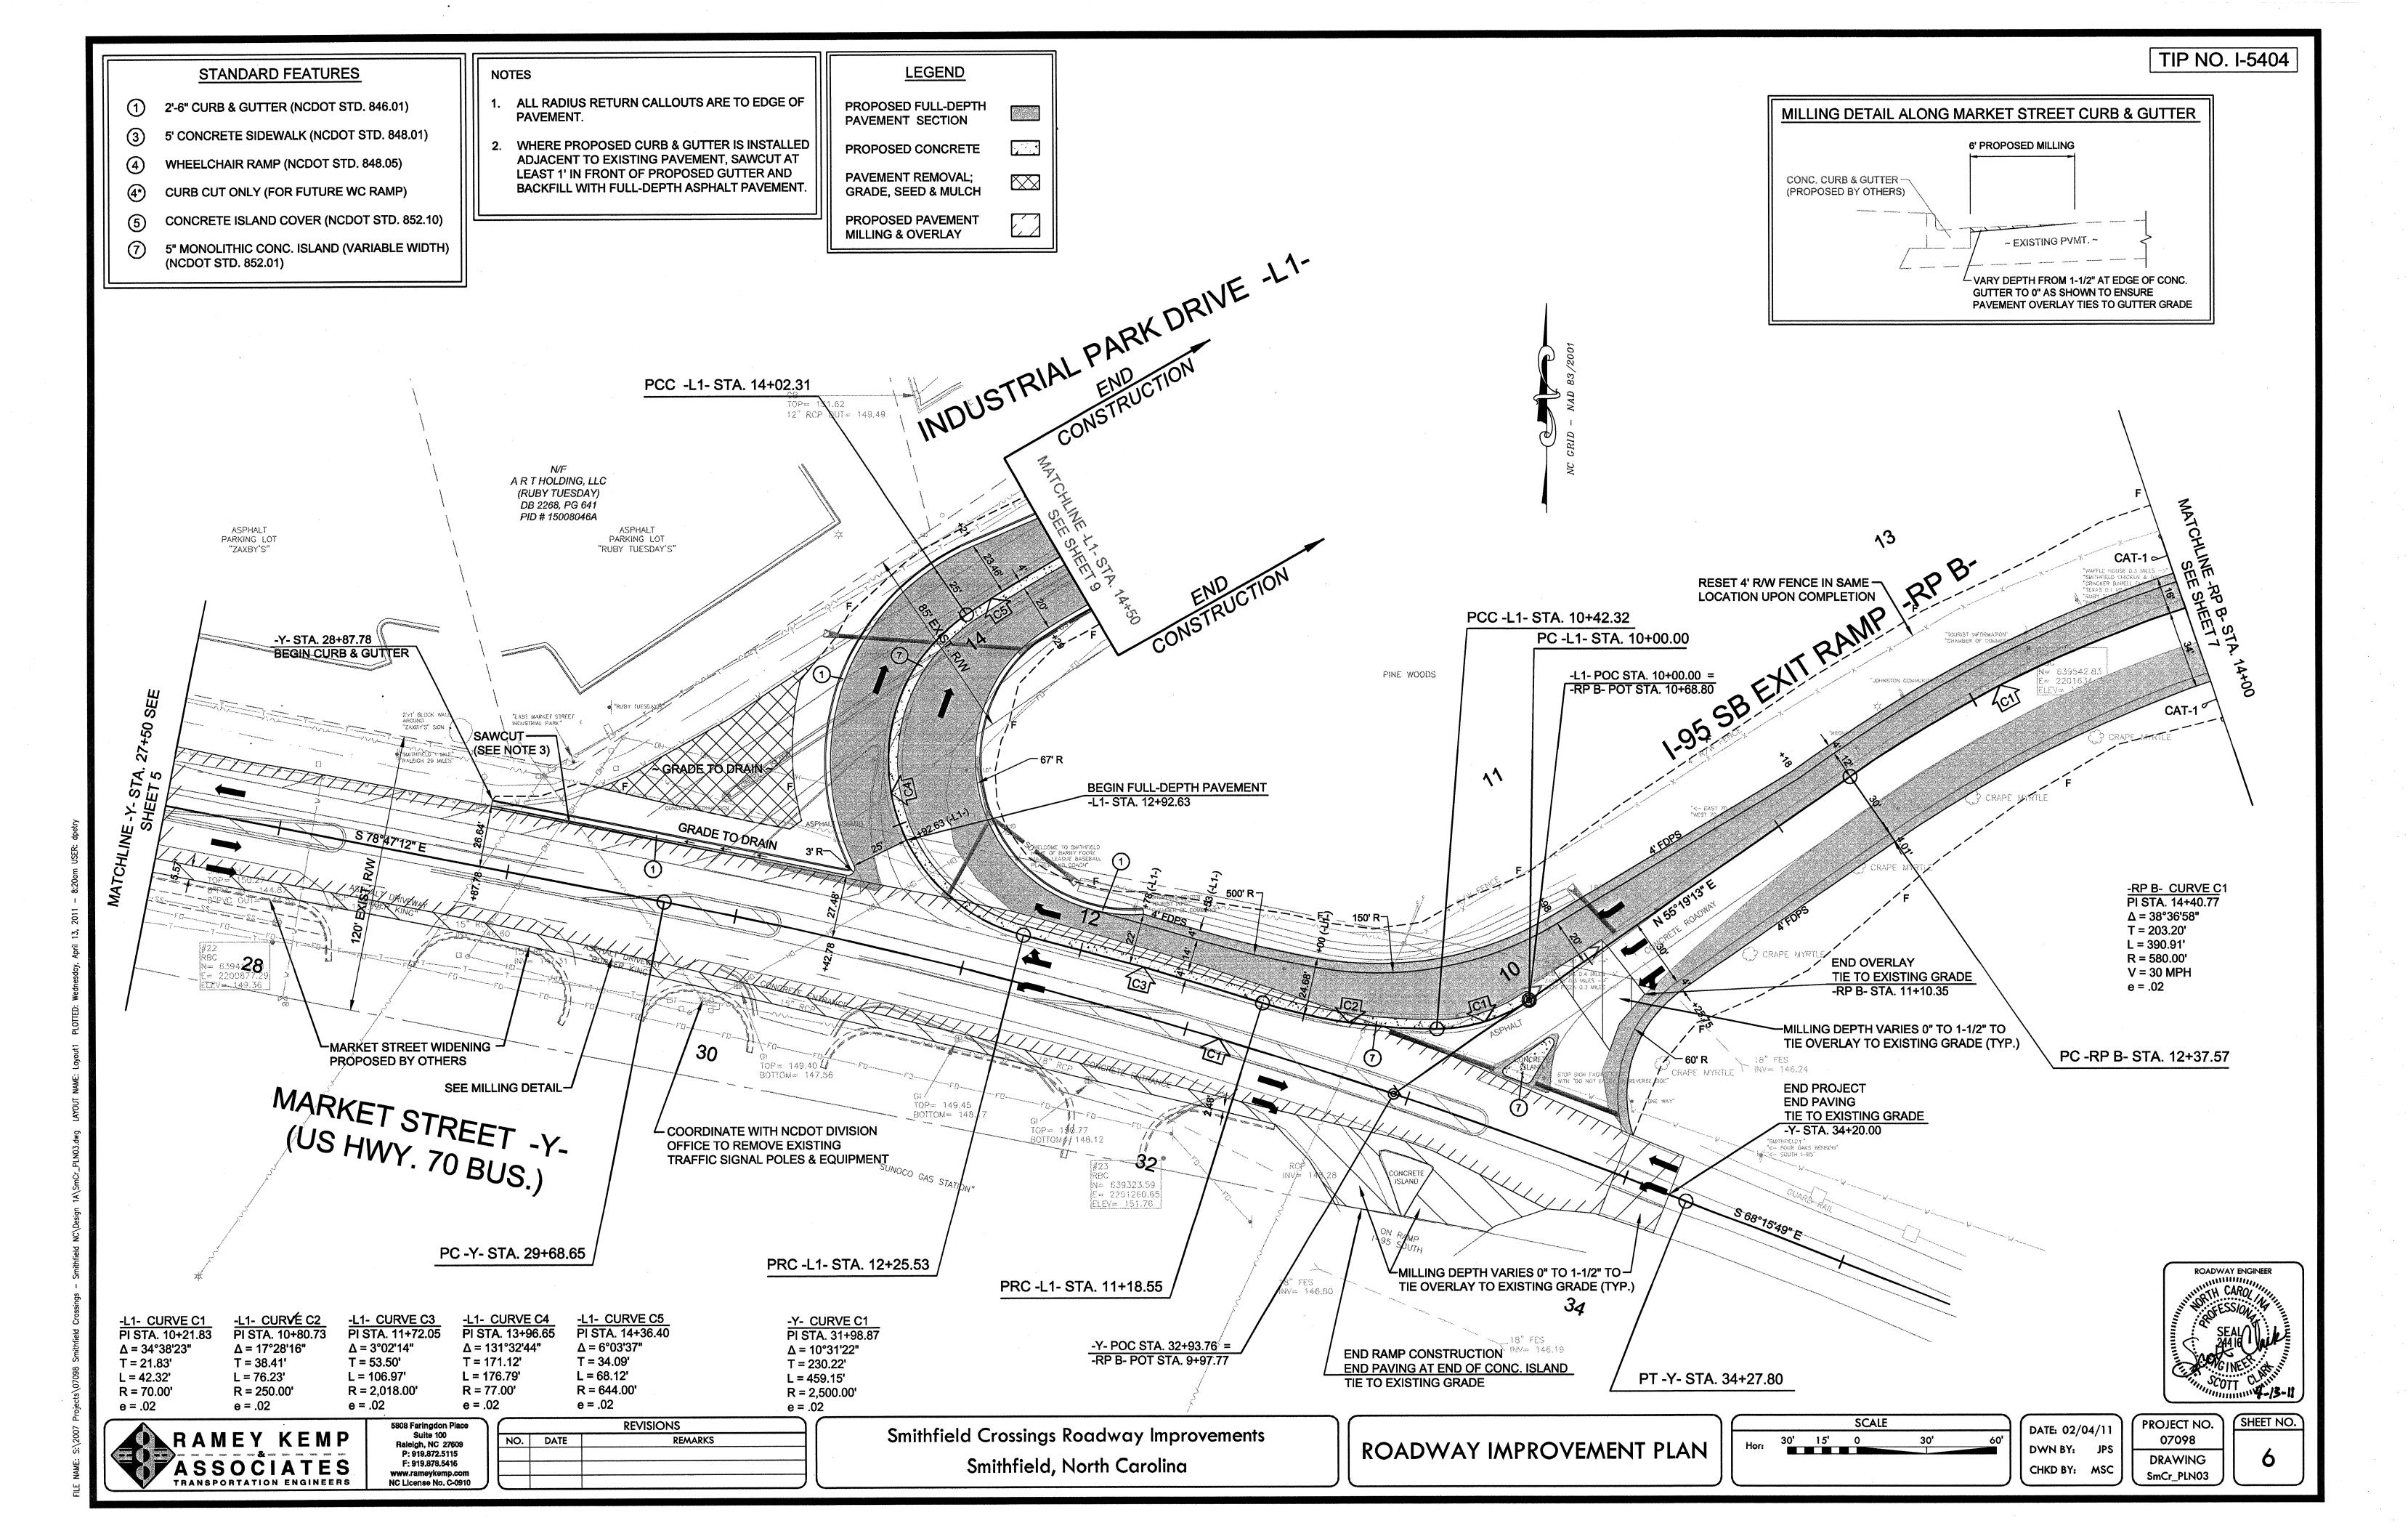

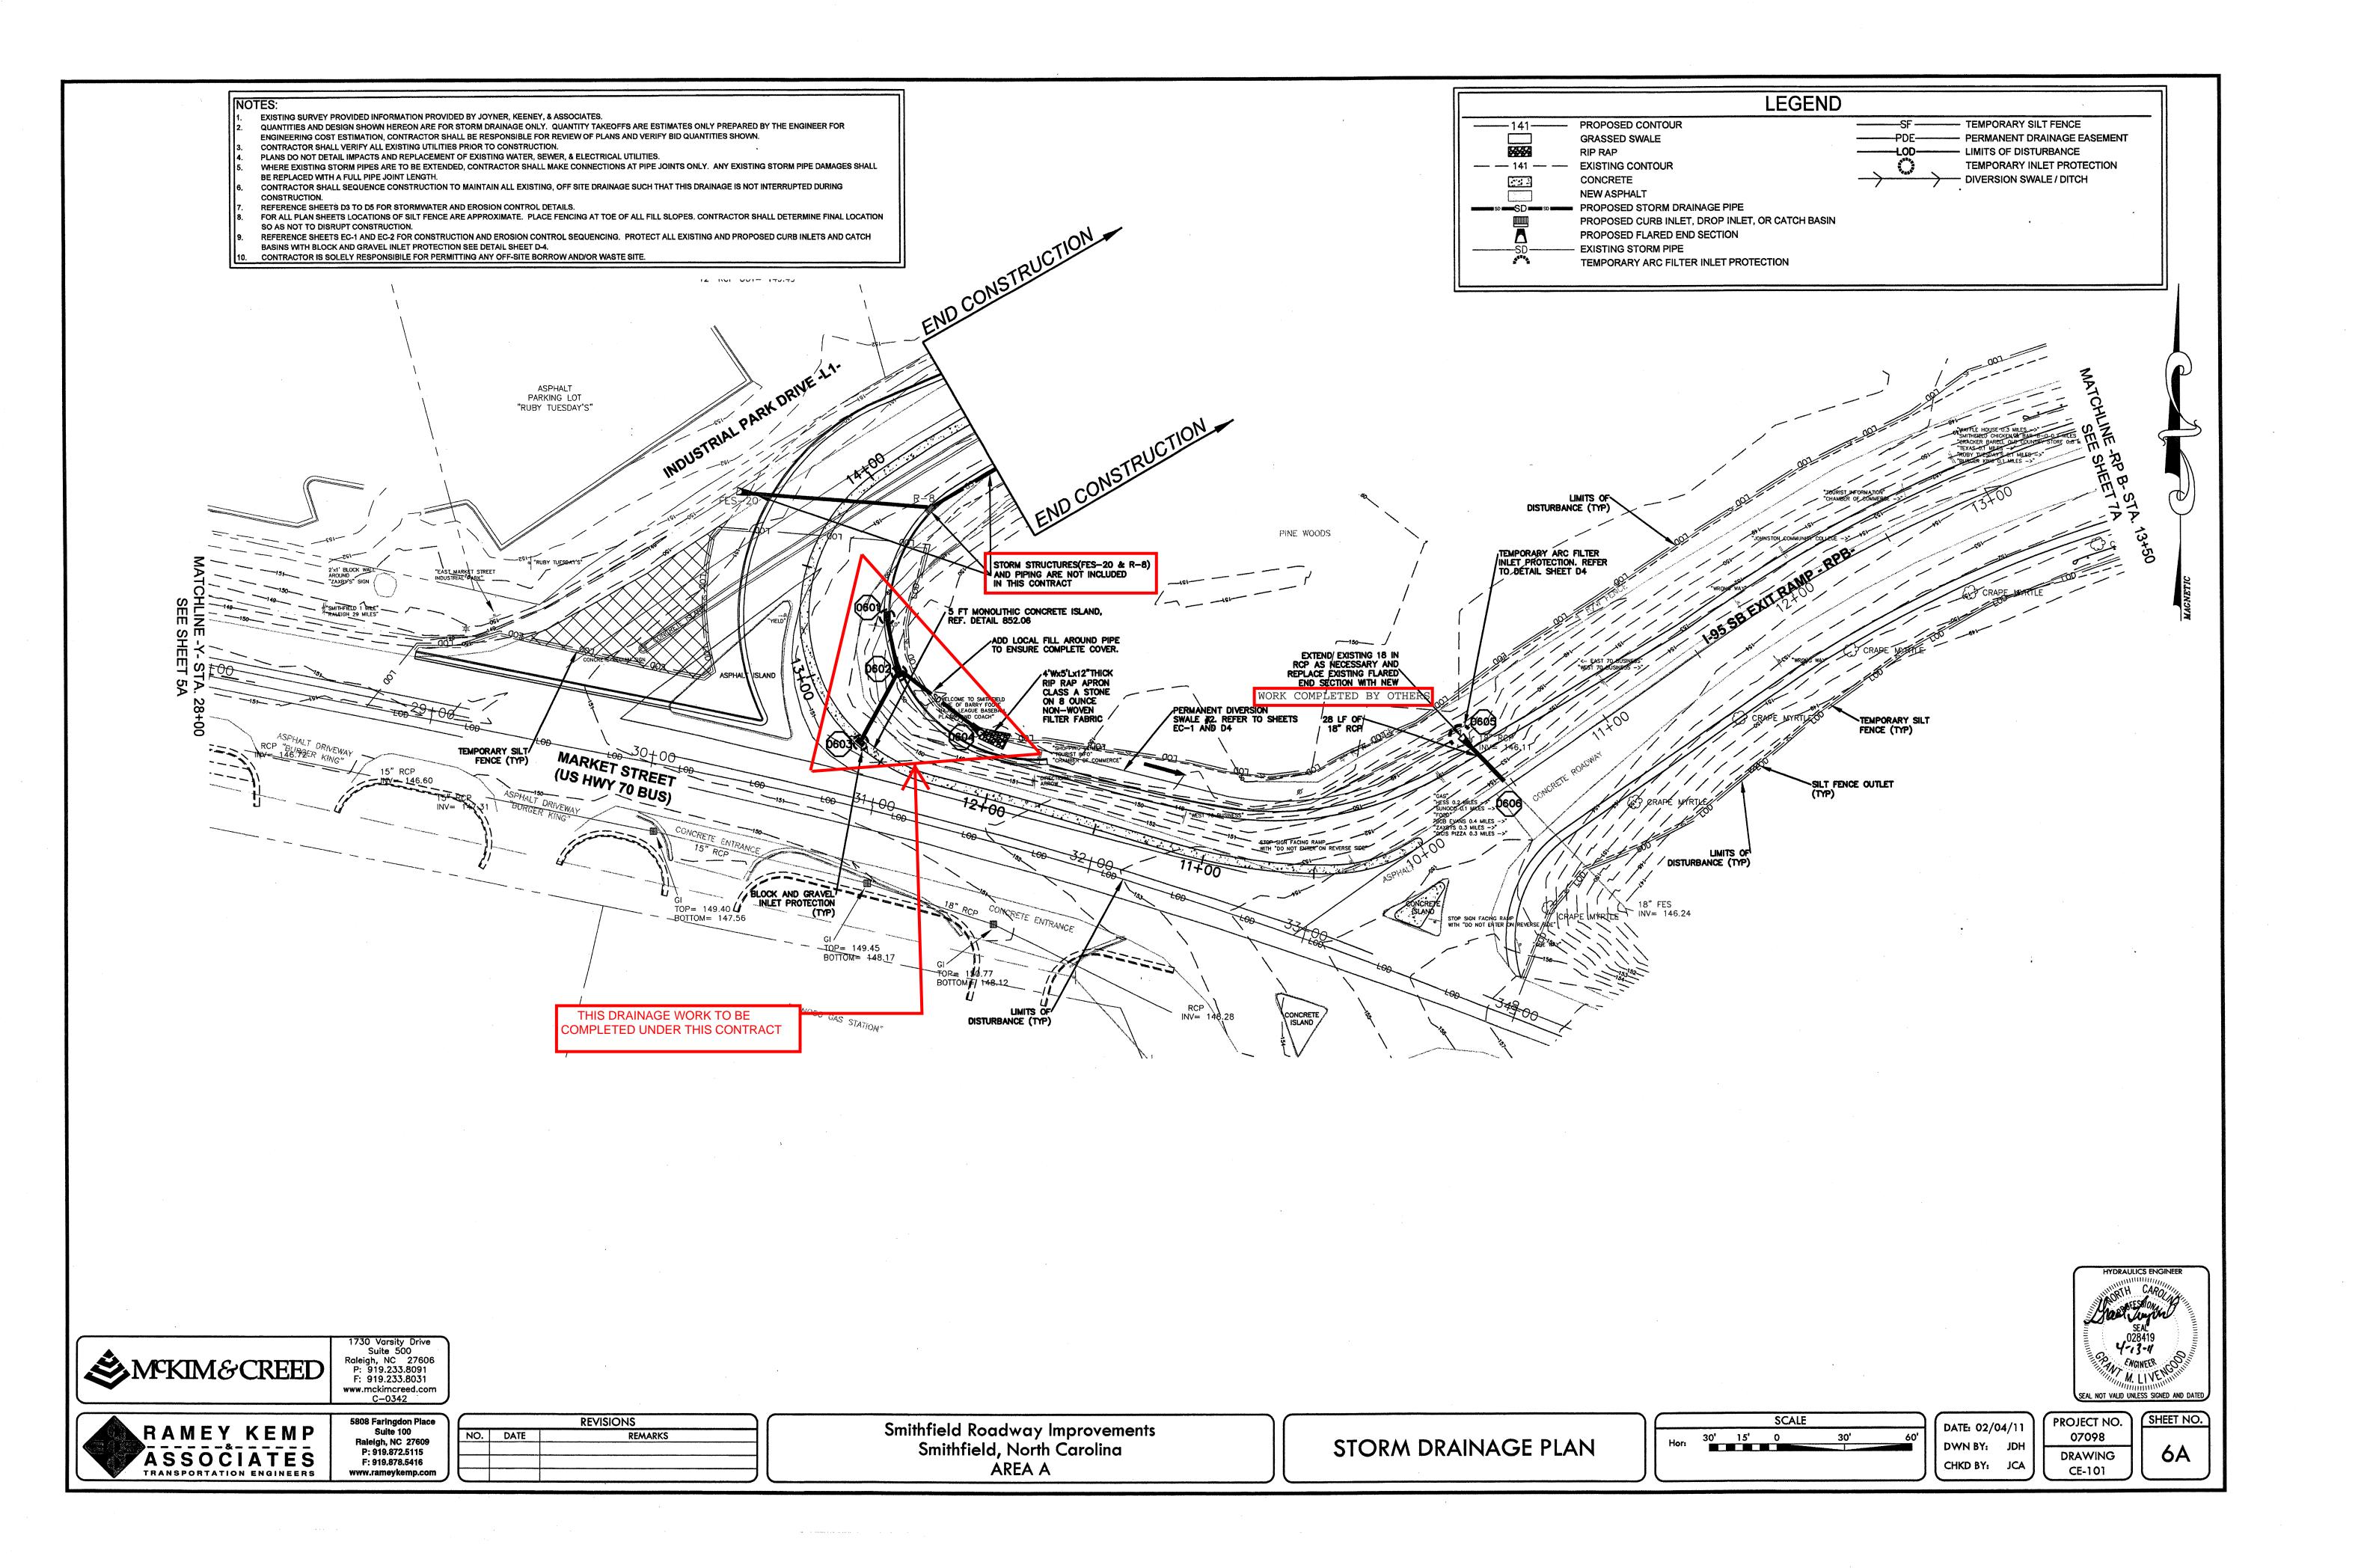


STANDARD FEATURES


- 2'-6" CURB & GUTTER (NCDOT STD. 846.01)
- 5' CONCRETE SIDEWALK (NCDOT STD. 848.01)
- CURB CUT ONLY (FOR FUTURE WC RAMP)
- CONCRETE ISLAND COVER (NCDOT STD. 852.10)
- 5" MONOLITHIC CONC. ISLAND (VARIABLE WIDTH) (NCDOT STD. 852.01)

NOTES:

- 1. ALL RADIUS RETURN CALLOUTS ARE TO EDGE OF PAVEMENT.
- 2. WHERE PROPOSED CURB & GUTTER IS INSTALLED ADJACENT TO EXISTING PAVEMENT, SAWCUT AT LEAST 1' IN FRONT OF PROPOSED GUTTER AND BACKFILL WITH FULL-DEPTH ASPHALT PAVEMENT.

TIP NO. I-5404

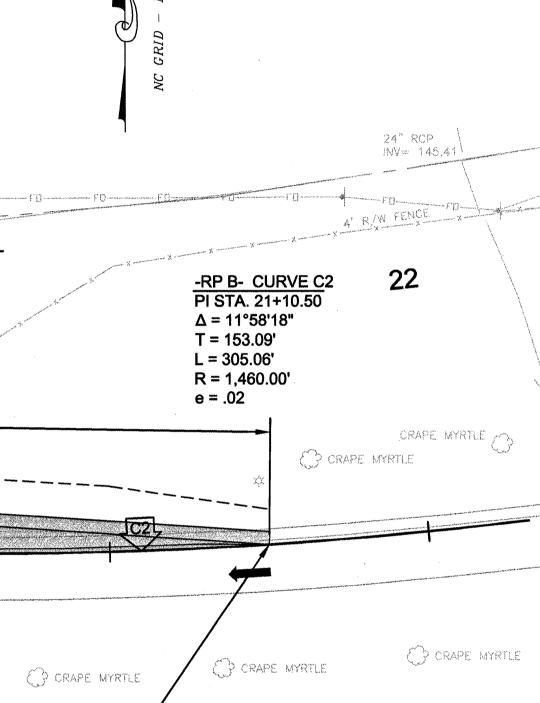

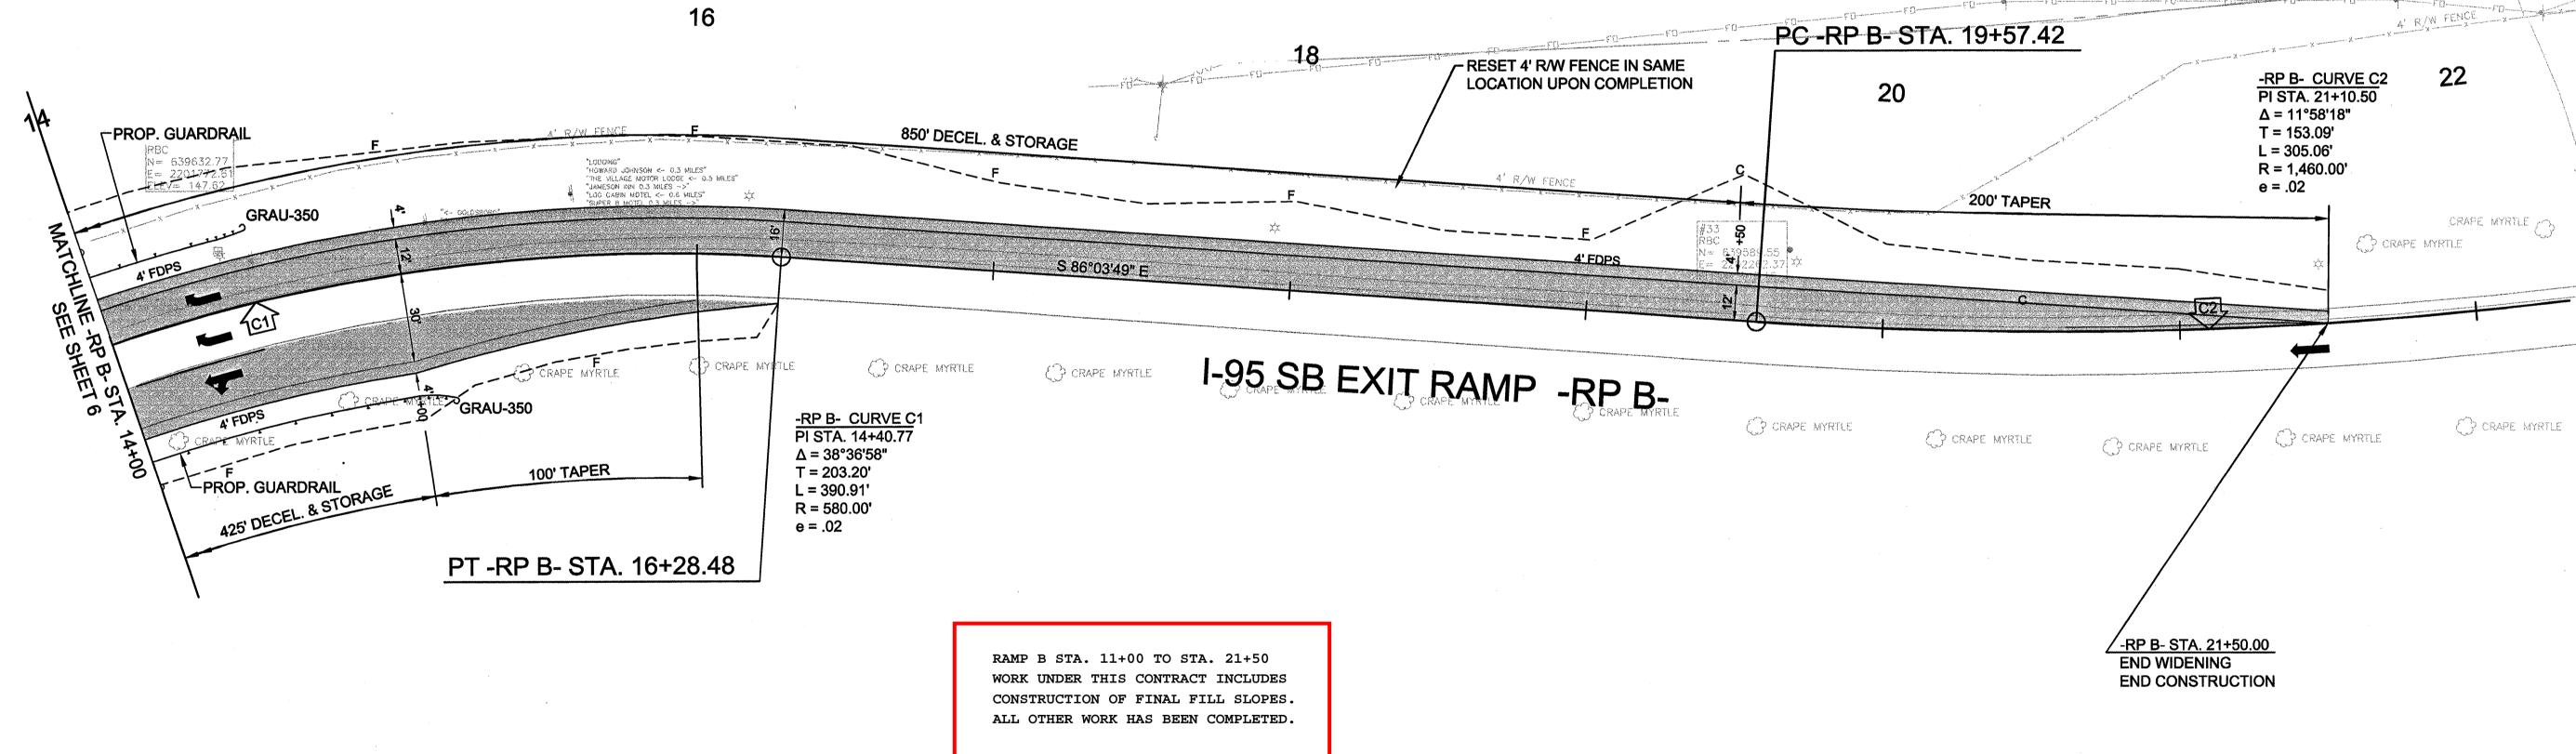



DATE: 02/04/11 CHKD BY: MSC

30' 15' 0


SHEET NO. PROJECT NO. 07098 DRAWING SmCr_PLN04

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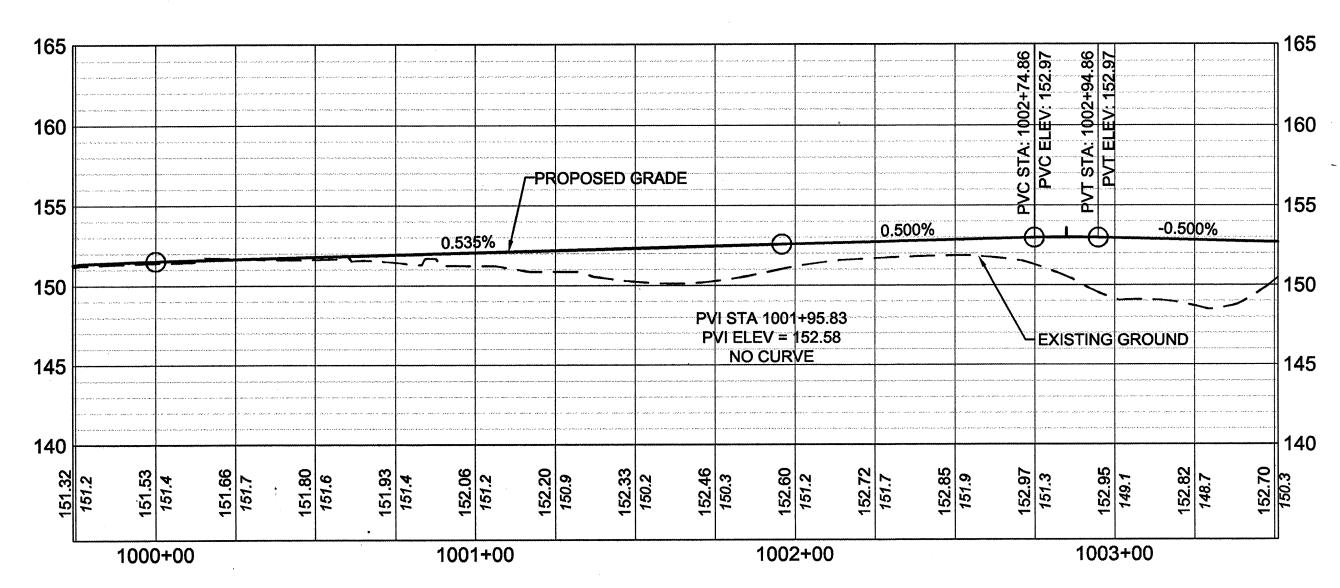
REVISIONS REMARKS NO. DATE

Smithfield Crossings Roadway Improvements Smithfield, North Carolina

ROADWAY IMPROVEMENT PLAN

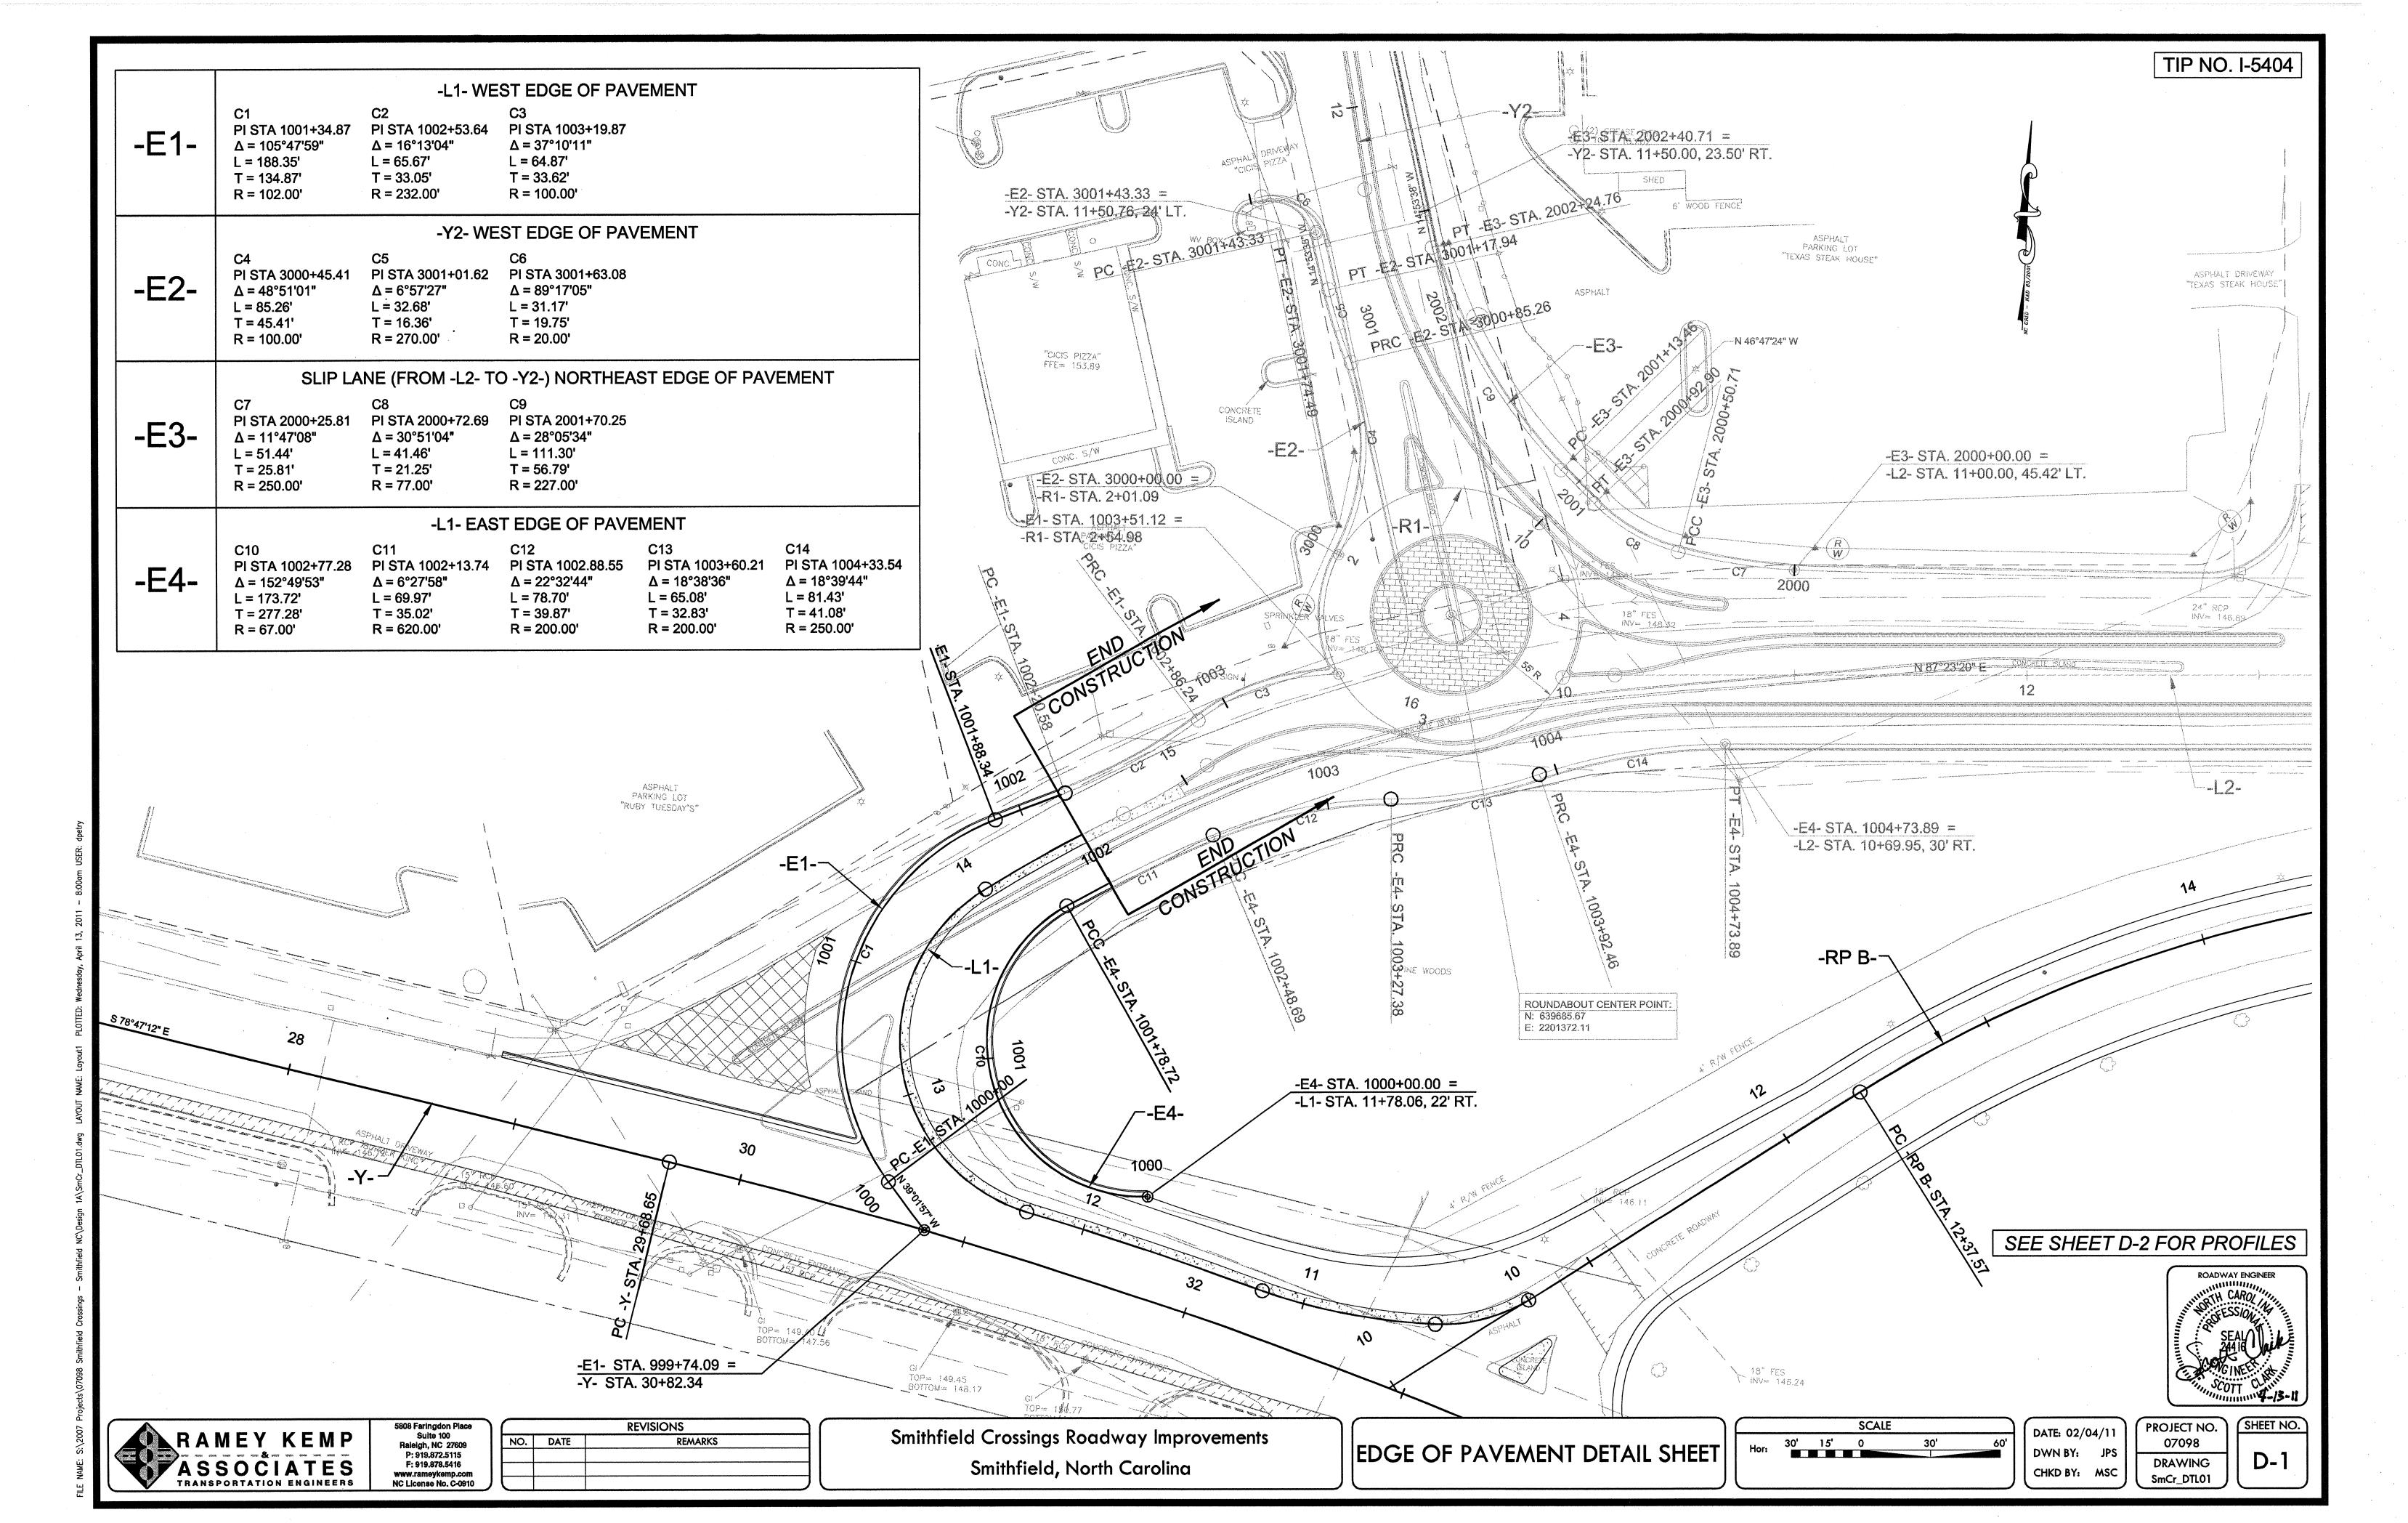


PVI STA 1002+84.86 **PVI ELEV = 153.02** L = 20.00'K = 20.00HIGH PT STA 1002+84.86 **HIGH PT ELEV = 153.00**




-L1- WEST EDGE OF PAVEMENT:

-E1- STA. 1000+00 TO -E1- STA. 1003+51.12

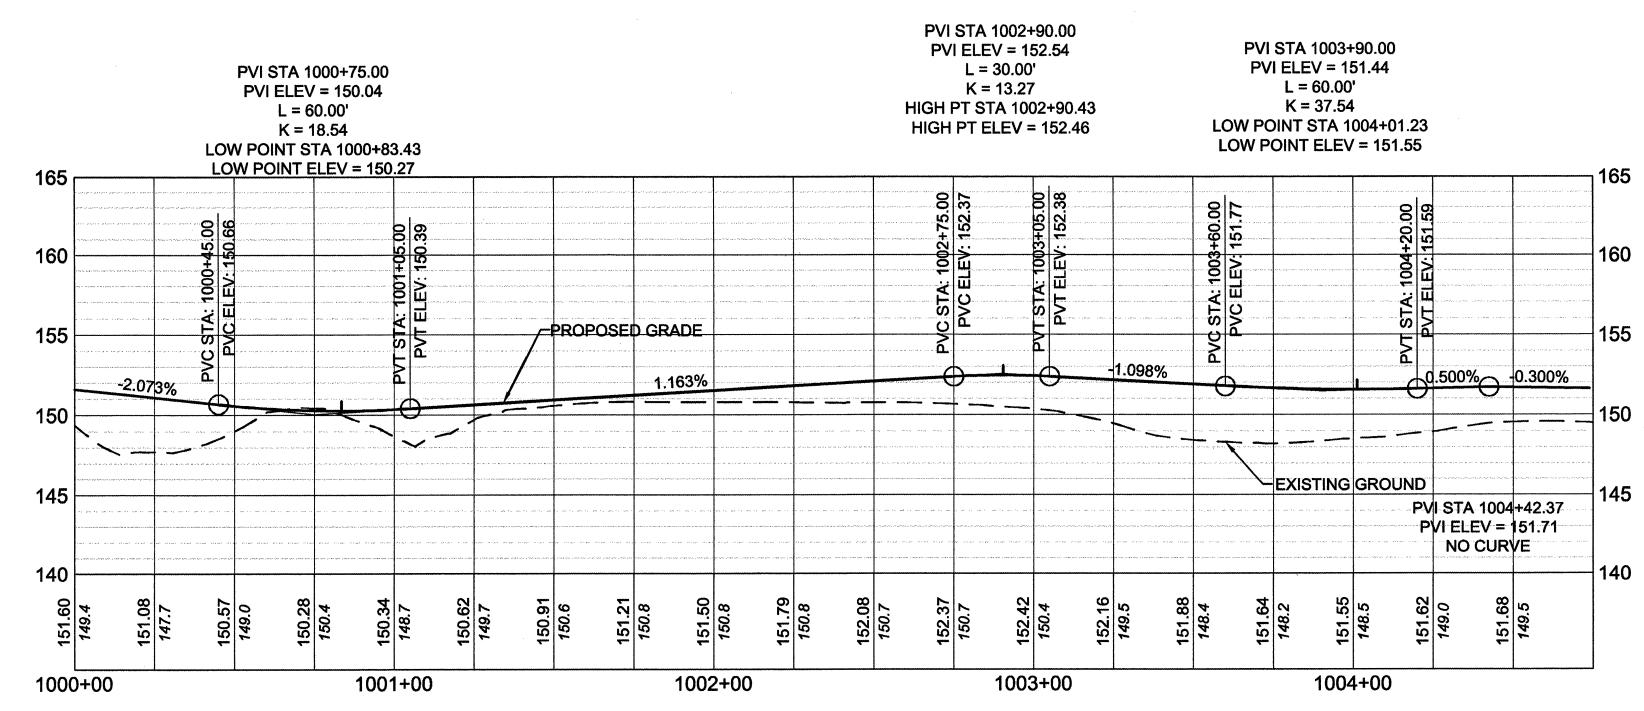

-L1- EAST EDGE OF PAVEMENT: -E4- STA. 1000+00 TO -E4- STA. 1004+75

SEE SHEET D-1 FOR PLAN LAYOUT

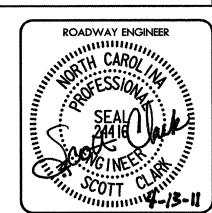


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REVISIONS REMARKS NO. DATE

Smithfield Crossings Roadway Improvements Smithfield, North Carolina


EDGE OF PAVEMENT DETAIL SHEET

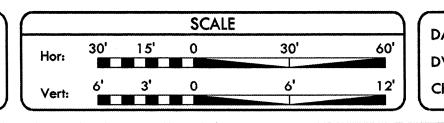



DATE: 09/29/10 CHKD BY: MSC


PROJECT NO. 07098 DRAWING SmCr_DTL02


SHEET NO. D-2

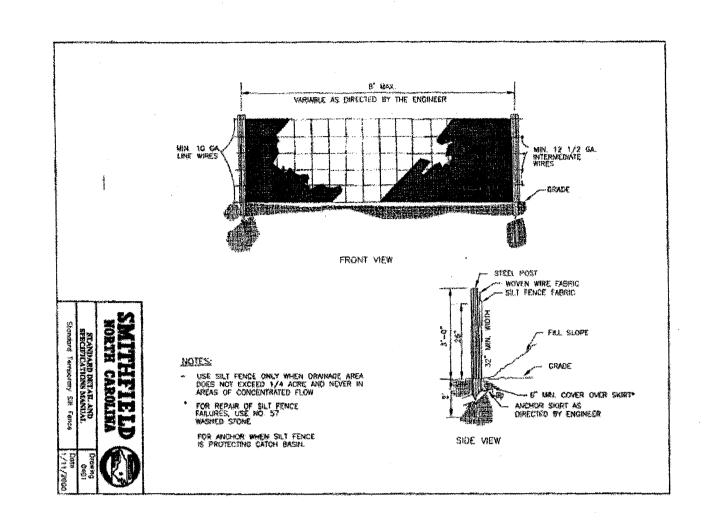


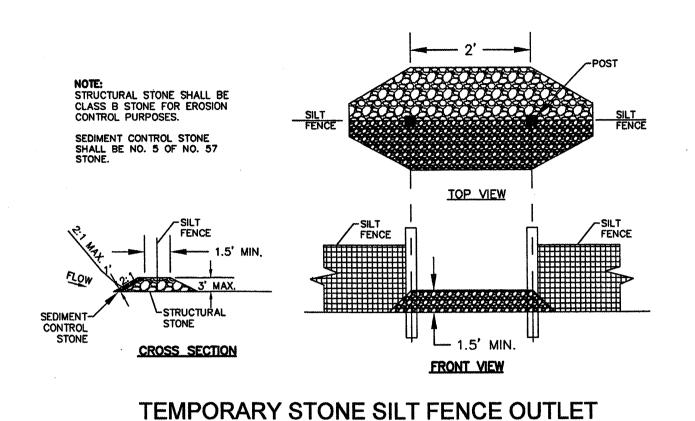


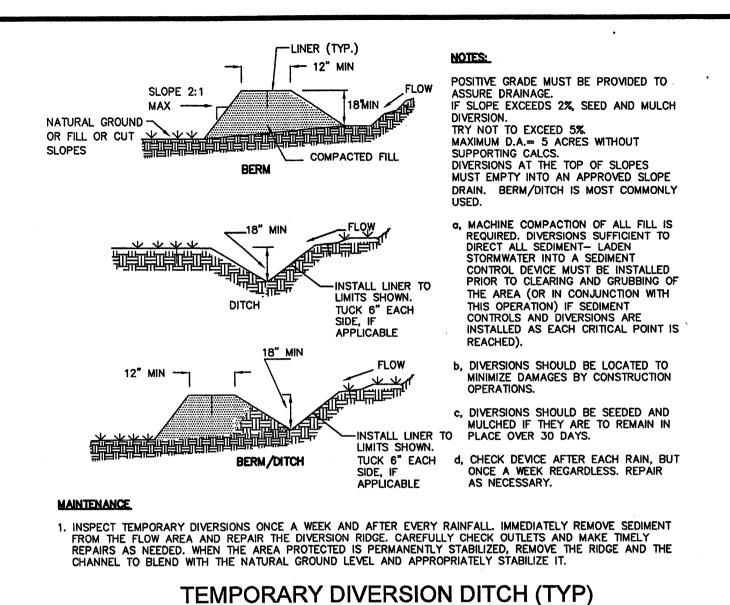

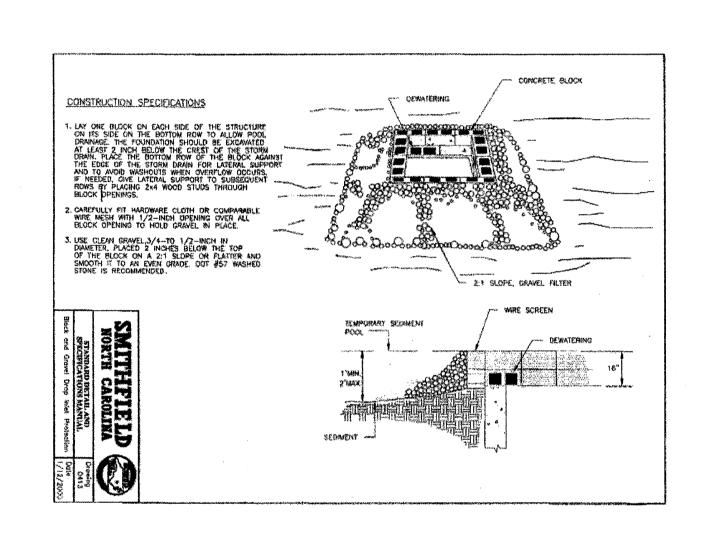

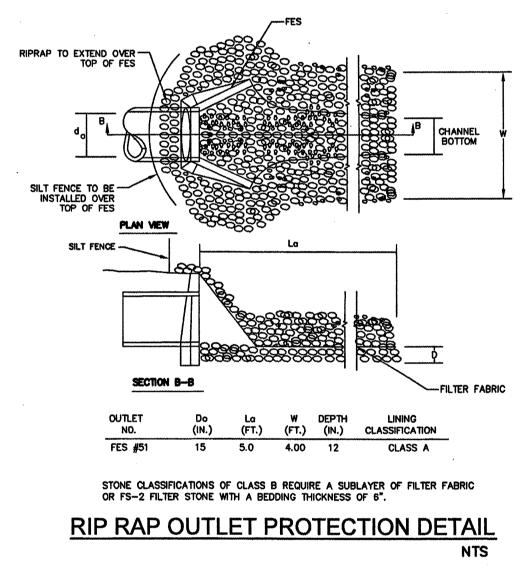

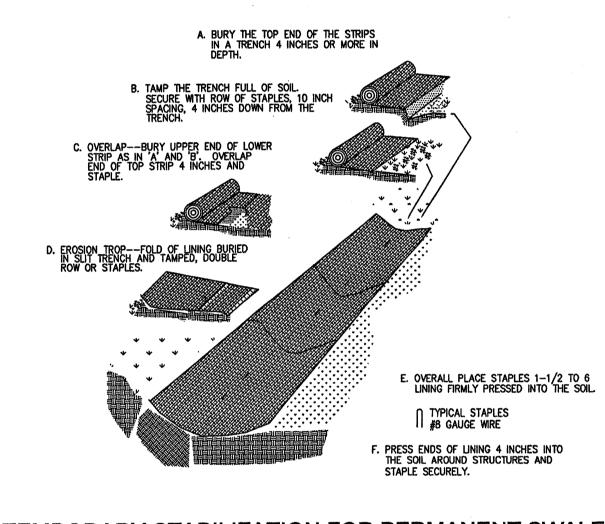


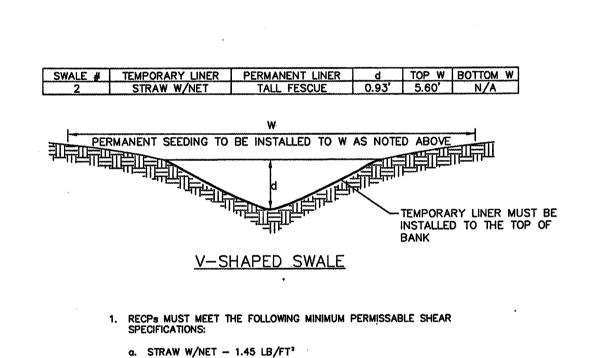



NTS

TEMPORARY STABILIZATION FOR PERMANENT SWALES


STANDARD PERMANENT V-SHAPED SWALE

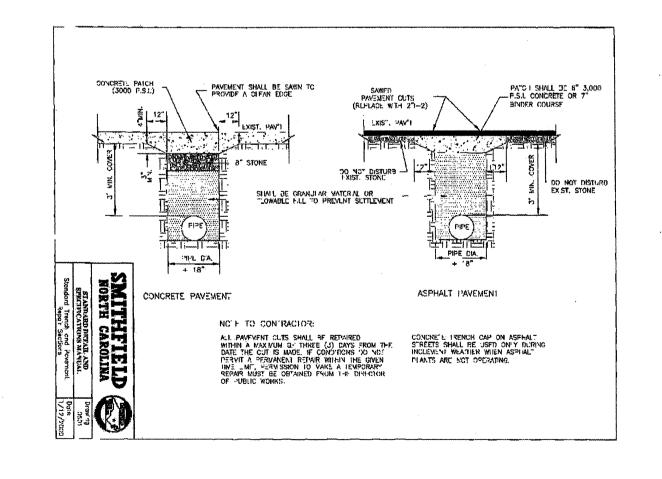

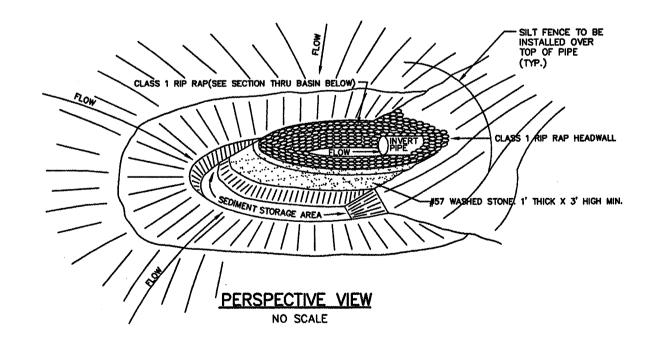

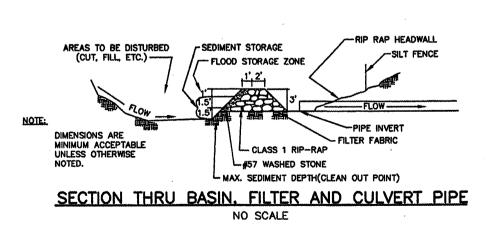

ARC FILTER INLET PROTECTION

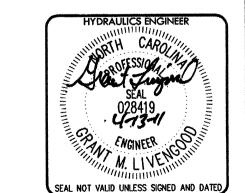

RAMEY KEMP ASSOCIATES
TRANSPORTATION ENGINEERS

SMCKIM&CREED

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www.mckimcreed.com
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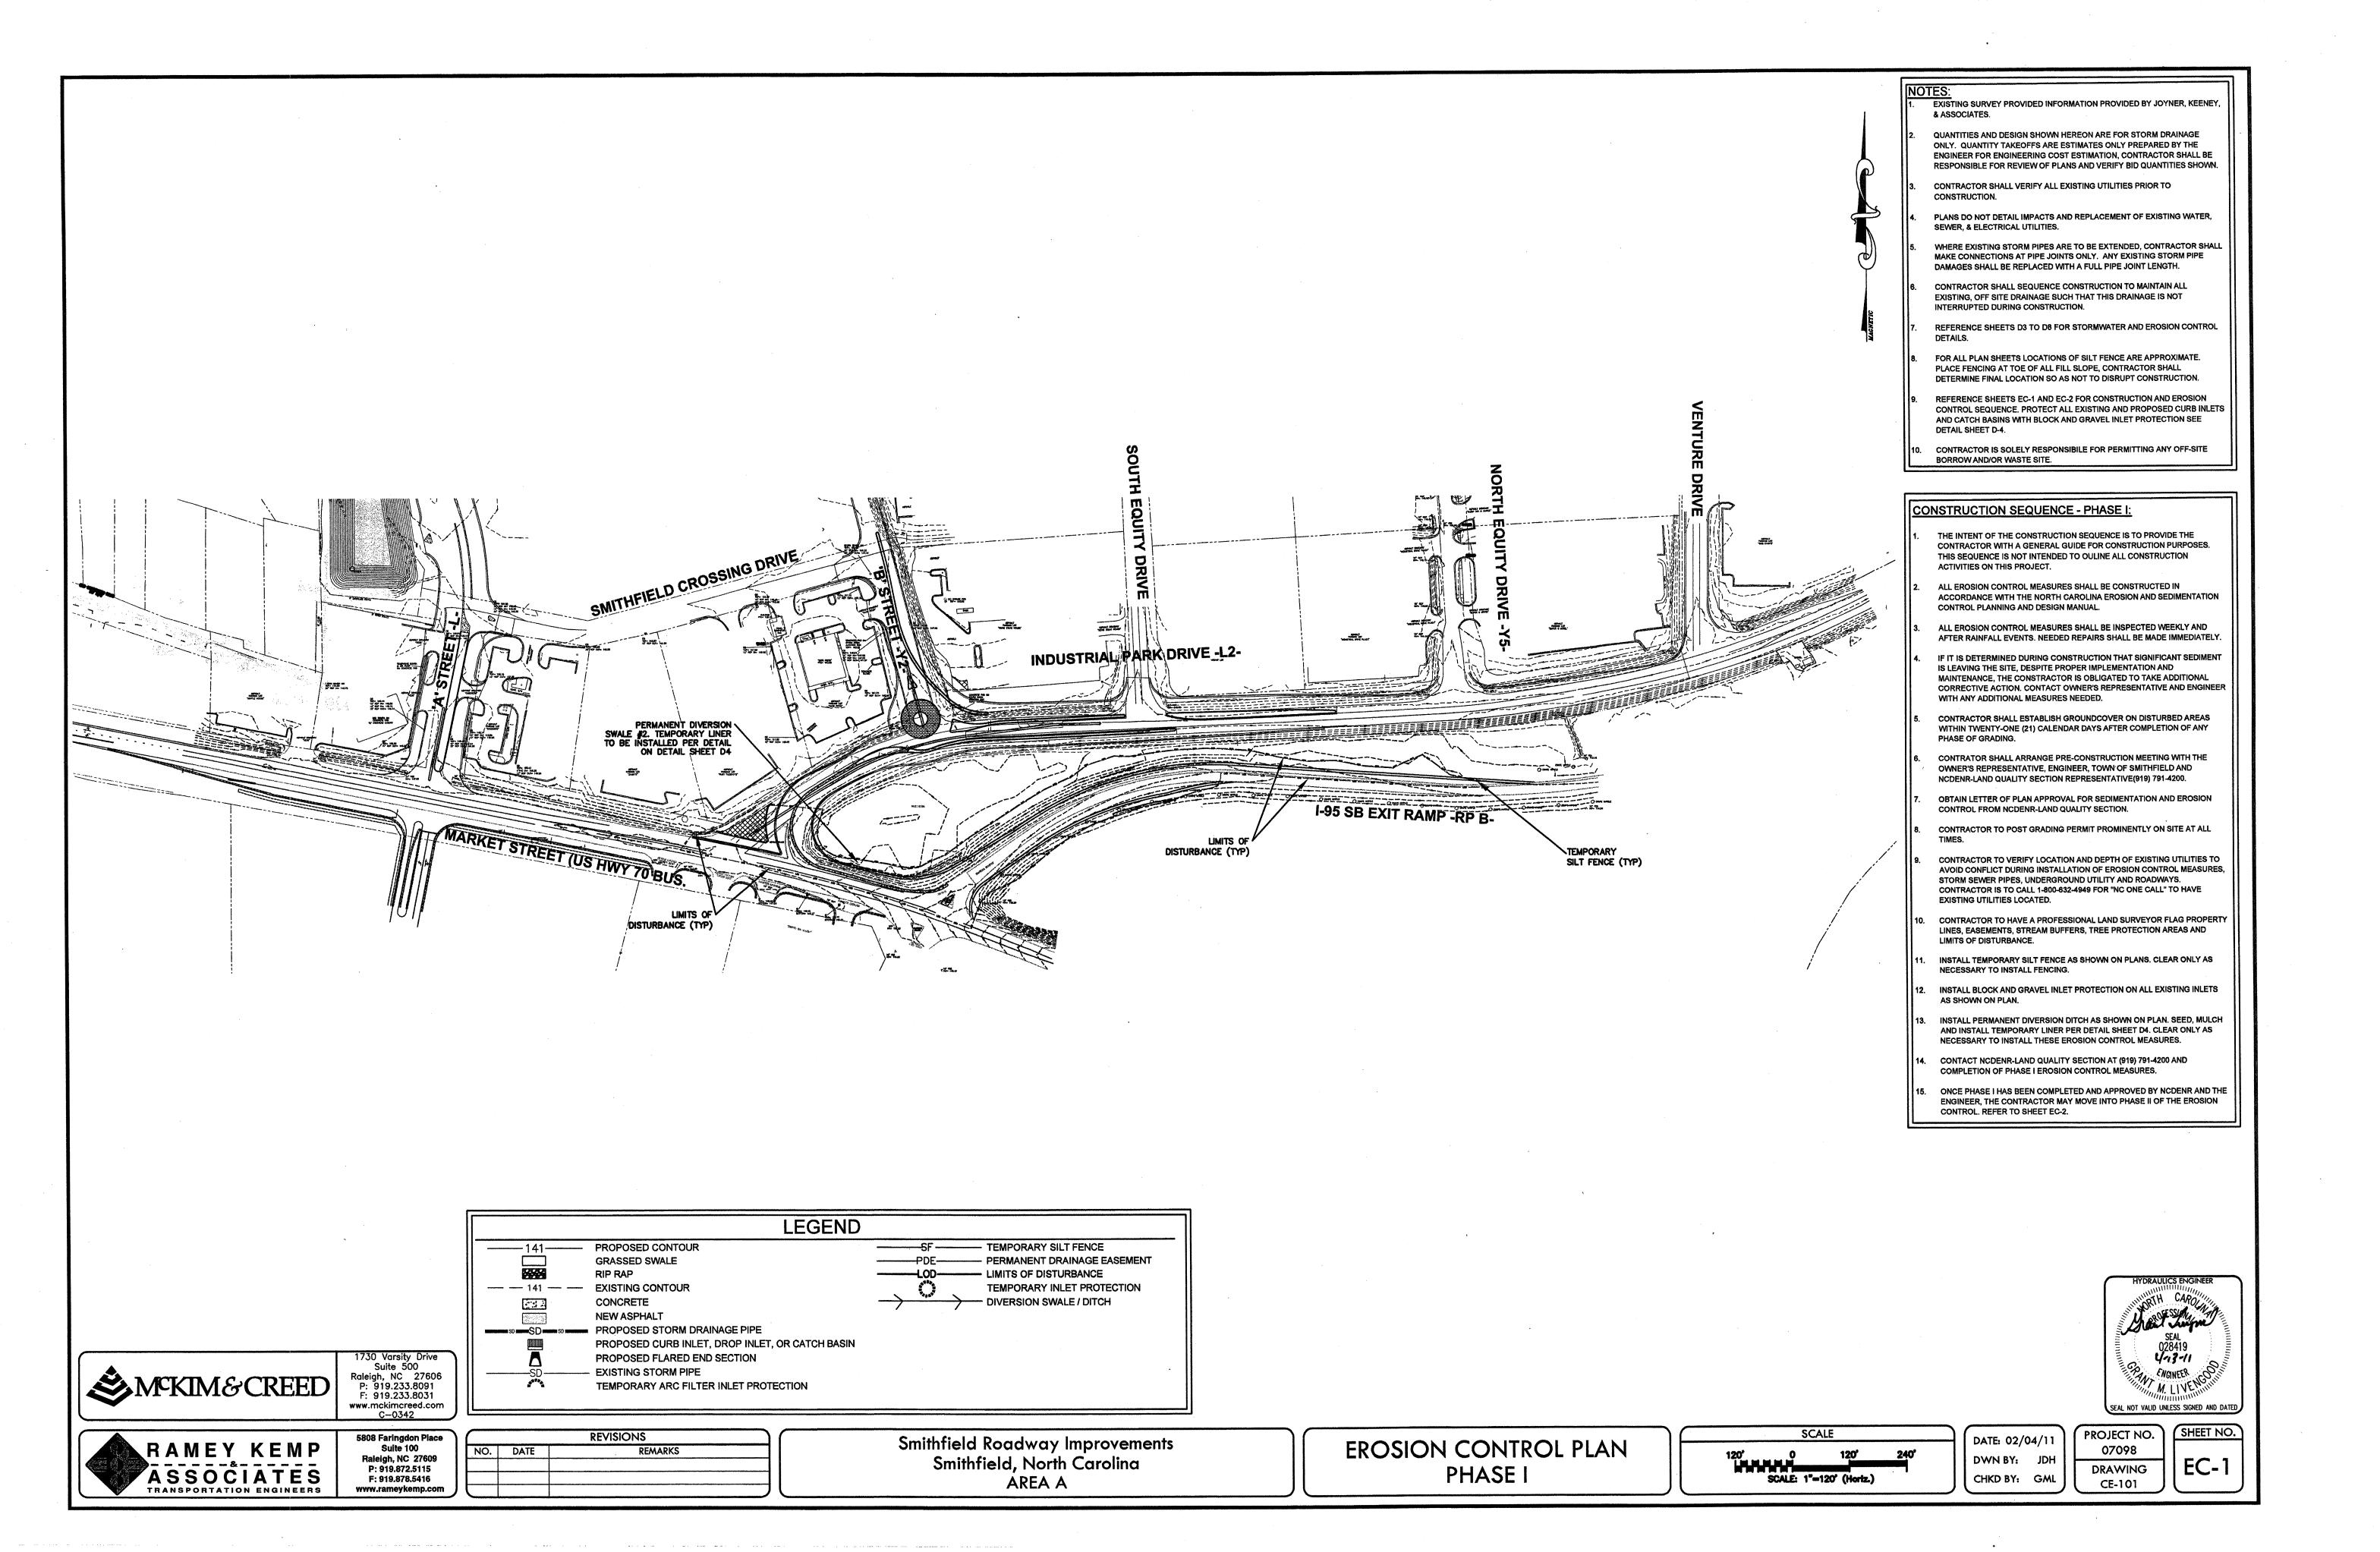
REVISIONS NO. DATE REMARKS **Smithfield Roadway Improvements** Smithfield, North Carolina AREA A


EROSION CONTROL DETAILS

DATE: 02/04/1 DWN BY: JDH CHKD BY: GML

PROJECT NO. 07098 DRAWING CE-101

SHEET NO. **D4**



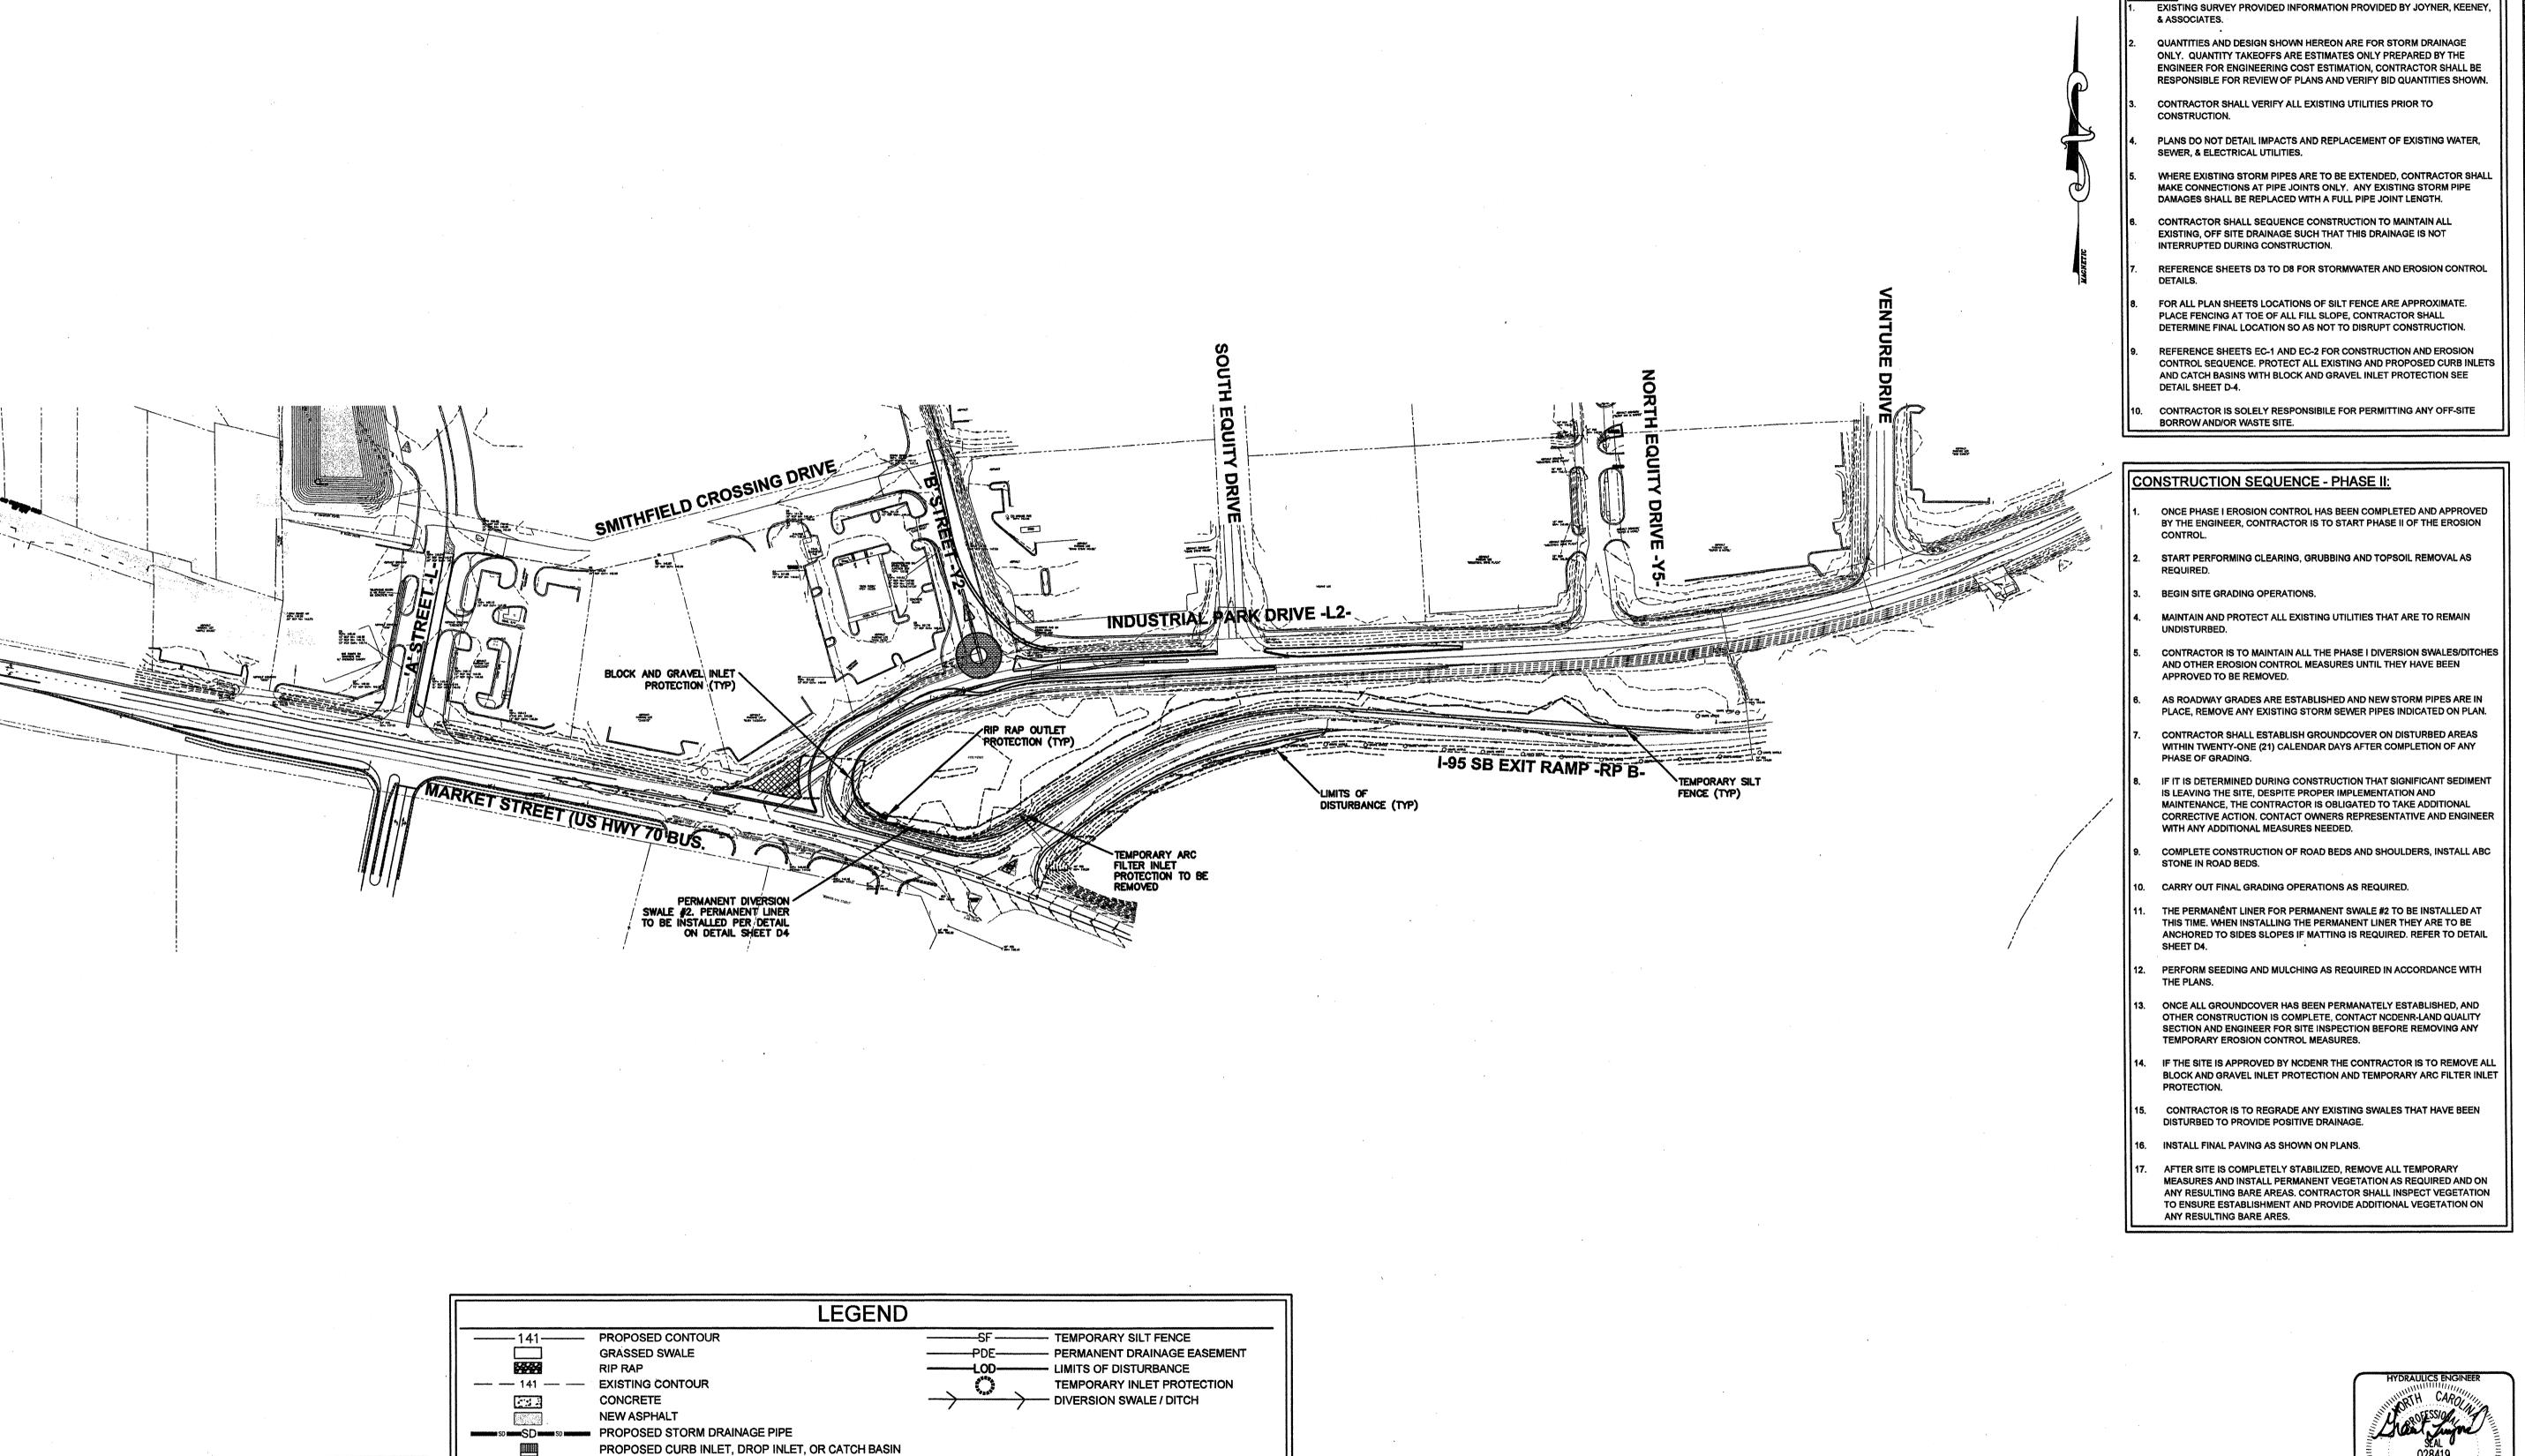

Si

SEAL NOT VALID UNLESS SIGNED AND DATED

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REVISIONS
NO. DATE REMARKS

PROPOSED FLARED END SECTION

TEMPORARY ARC FILTER INLET PROTECTION

EXISTING STORM PIPE

Smithfield Roadway Improvements Smithfield, North Carolina AREA A

EROSION CONTROL PLAN PHASE II SCALE

120' 0 120' 240'

SCALE: 1"=120' (Horiz.)

DATE: 02/04/11

DWN BY: JDH

CHKD BY: GML

PROJECT NO. 07098

DRAWING CE-101

SHEET NO.

EC-2

LEGEND - PAVEMENT MARKING LINES

----- THERMOPLASTIC (4", 90 mils)

TA - WHITE EDGE LINE TB - YELLOW EDGE LINE

----- THERMOPLASTIC (4", 120 mils)

TC - 10 ft. WHITE SKIP TD - 2 ft. WHITE MINI SKIP TE - WHITE SOLID LANE LINE

TF - YELLOW 10 ft. YELLOW SKIP TG - 2 ft. YELLOW MINI SKIP TH - YELLOW SINGLE CENTER LINE TI - YELLOW DOUBLE CENTER LINE

T8 - 2 ft. WHITE MINI SKIP, 8' GAP

----- THERMOPLASTIC (6", 120 mils)

T6 - WHITE EDGE LINE T7 - YELLOW EDGE LINE TJ - 10 ft. WHITE SKIP TK - 2 ft. WHITE MINI SKIP

TL - WHITE SOLID LANE LINE

----- THERMOPLASTIC (8", 90 mils) TP - WHITE GORE LINE

TQ - WHITE DIAGONAL TT - YELLOW DIAGONAL

----- THERMOPLASTIC (12", 90 mils) T10 - 2 ft. WHITE MINI SKIP, 3' GAP

----- THERMOPLASTIC (24", 120 mils) T2 - WHITE STOP BAR T3 - WHITE CROSSWALK LINE

----- PAINT (4") PA - WHITE LINE

LEGEND - PAVEMENT MARKING SYMBOLS

----- WHITE THERMOPLASTIC (90 mils)

UA - LEFT TURN ARROW

UB - RIGHT TURN ARROW UC - STRAIGHT ARROW

UD - COMBINATION STRAIGHT & LEFT TURN ARROW


UE - COMBINATION STRAIGHT & RIGHT TURN ARROW UF - COMBINATION LEFT & RIGHT TURN ARROW

----- WHITE THERMOPLASTIC (120 mils) UI - ALPHANUMERIC CHARACTER "ONLY"

UN - YIELD LINE (SEE DETAIL 'A')

NOTES:

- 1. ALL PAVEMENT MARKINGS SHALL BE IN ACCORDANCE WITH THE NCDOT STANDARD SPECIFICATIONS FOR ROADS AND STRUCTURES BOOK, DATED JULY 2006, AND THE NCDOT ROADWAY STANDARD DRAWINGS, DATED JULY 2006.
- 2. INSTALL RAISED PAVEMENT MARKERS WITHIN THE PROJECT LIMITS ALONG MARKET STREET (US HIGHWAY 70 BUSINESS) AND THE I-95 EXIT RAMP PER NCDOT ROADWAY STANDARD DRAWING 1250.01.
- 3. TIE PROPOSED PAVEMENT MARKING LINES TO EXISTING PAVEMENT MARKING LINES.
- 4. REMOVE / REPLACE ANY CONFLICTING / DAMAGED PAVEMENT MARKINGS AND MARKERS.
- 5. THE STOP BAR LOCATIONS SHOWN ON THE APPROVED TRAFFIC SIGNAL PLANS SHALL SUPERCEDE THOSE ON THIS PLAN.

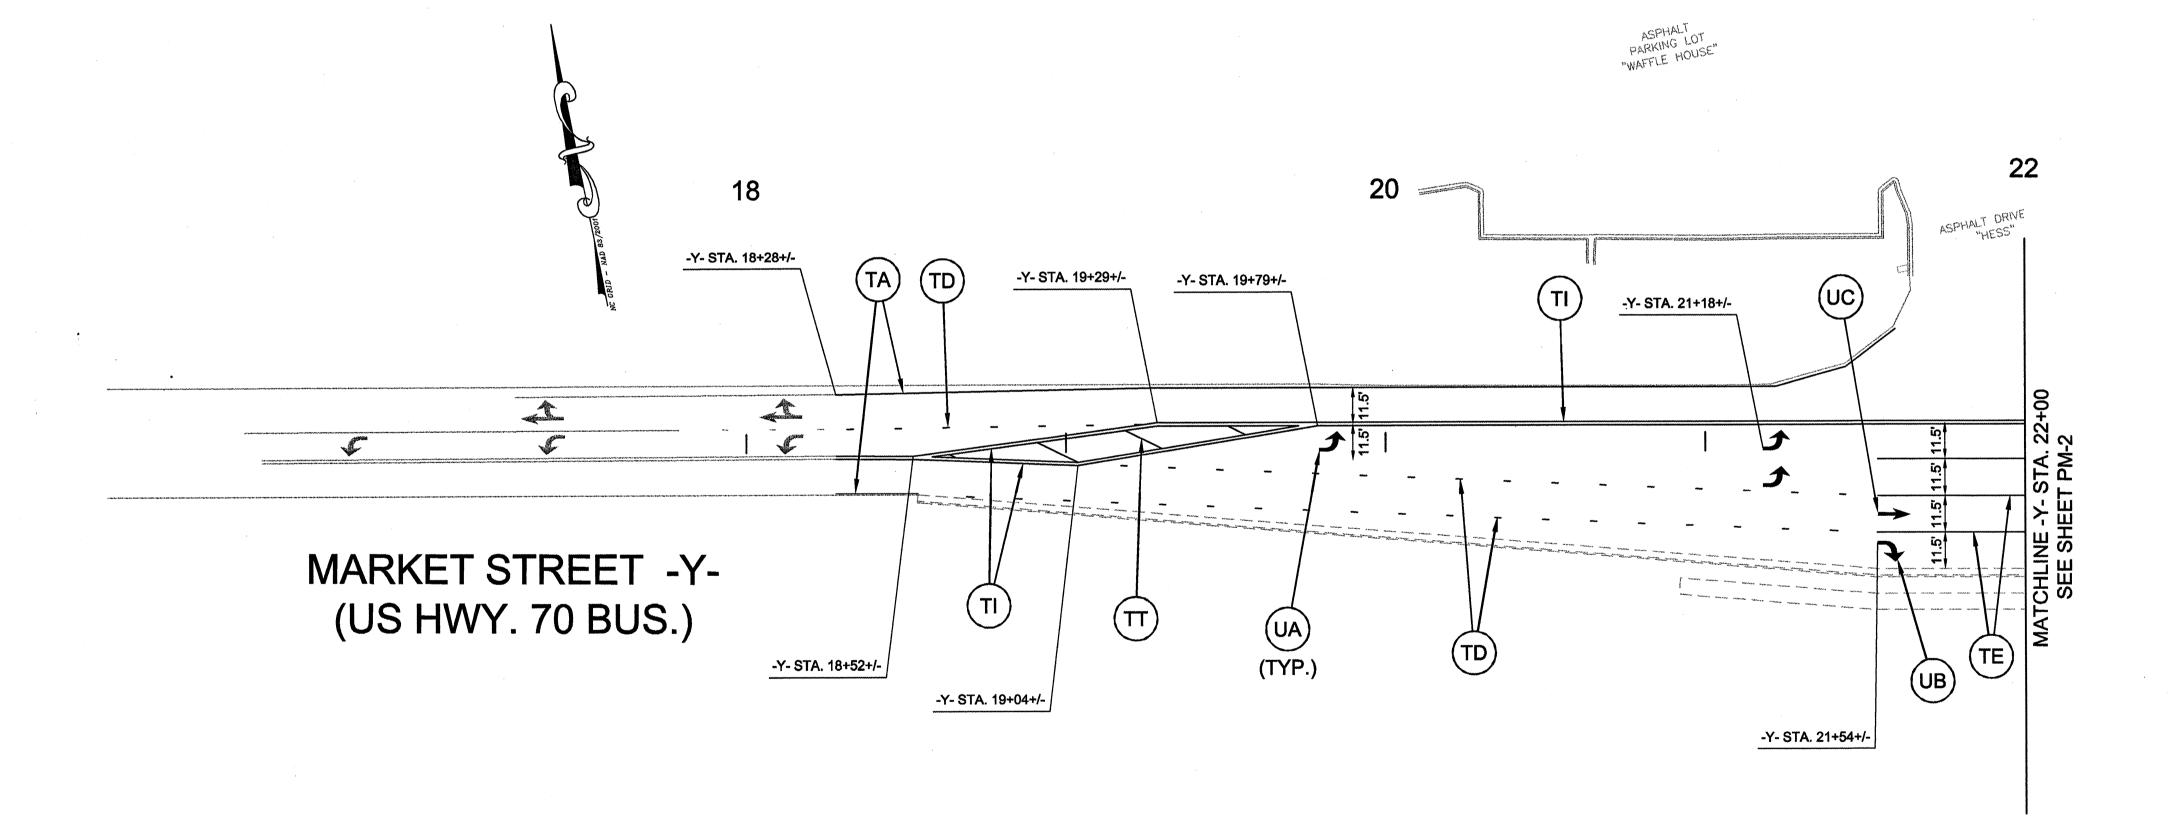




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REVISIONS NO. DATE

Smithfield Crossings Roadway Improvements Smithfield, North Carolina

PAVEMENT MARKING PLAN

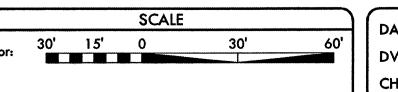

CHKD BY: MSC

07098 DRAWING

SHEET NO.

DATE: 02/04/11

TO

TIP NO. I-5404

LEGEND - PAVEMENT MARKING LINES

----- THERMOPLASTIC (4", 90 mils)

TA - WHITE EDGE LINE TB - YELLOW EDGE LINE

----- THERMOPLASTIC (4", 120 mils)

TC - 10 ft. WHITE SKIP TD - 2 ft. WHITE MINI SKIP

TE - WHITE SOLID LANE LINE

TF - YELLOW 10 ft. YELLOW SKIP

TG - 2 ft. YELLOW MINI SKIP TH - YELLOW SINGLE CENTER LINE

TI - YELLOW DOUBLE CENTER LINE

T8 - 2 ft. WHITE MINI SKIP, 8' GAP

----- THERMOPLASTIC (6", 120 mils)

T6 - WHITE EDGE LINE

T7 - YELLOW EDGE LINE

TJ - 10 ft. WHITE SKIP

TK - 2 ft. WHITE MINI SKIP TL - WHITE SOLID LANE LINE ----- THERMOPLASTIC (8", 90 mils)

TP - WHITE GORE LINE

TQ - WHITE DIAGONAL TT - YELLOW DIAGONAL

----- THERMOPLASTIC (12", 90 mils) T10 - 2 ft. WHITE MINI SKIP, 3' GAP

----- THERMOPLASTIC (24", 120 mils)

T2 - WHITE STOP BAR

T3 - WHITE CROSSWALK LINE

----- PAINT (4") PA - WHITE LINE

LEGEND - PAVEMENT MARKING SYMBOLS

----- WHITE THERMOPLASTIC (90 mils)

UA - LEFT TURN ARROW

UB - RIGHT TURN ARROW UC - STRAIGHT ARROW

UD - COMBINATION STRAIGHT & LEFT TURN ARROW

UE - COMBINATION STRAIGHT & RIGHT TURN ARROW

UF - COMBINATION LEFT & RIGHT TURN ARROW

----- WHITE THERMOPLASTIC (120 mils)
UI - ALPHANUMERIC CHARACTER "ONLY"

UN - YIELD LINE (SEE DETAIL 'A')



ASSOCIATES
TRANSPORTATION ENGINEERS


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MATCHLINE -Y- STA. 27+50 SEE SHEET PM-3

> **REVISIONS** NO. DATE REMARKS

Smithfield Crossings Roadway Improvements Smithfield, North Carolina

PAVEMENT MARKING PLAN

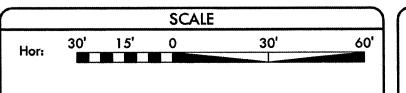


DATE: 02/04/11 CHKD BY: MSC

PROJECT NO. 07098 DRAWING

SmCr_PM01

PM-2

SHEET NO.

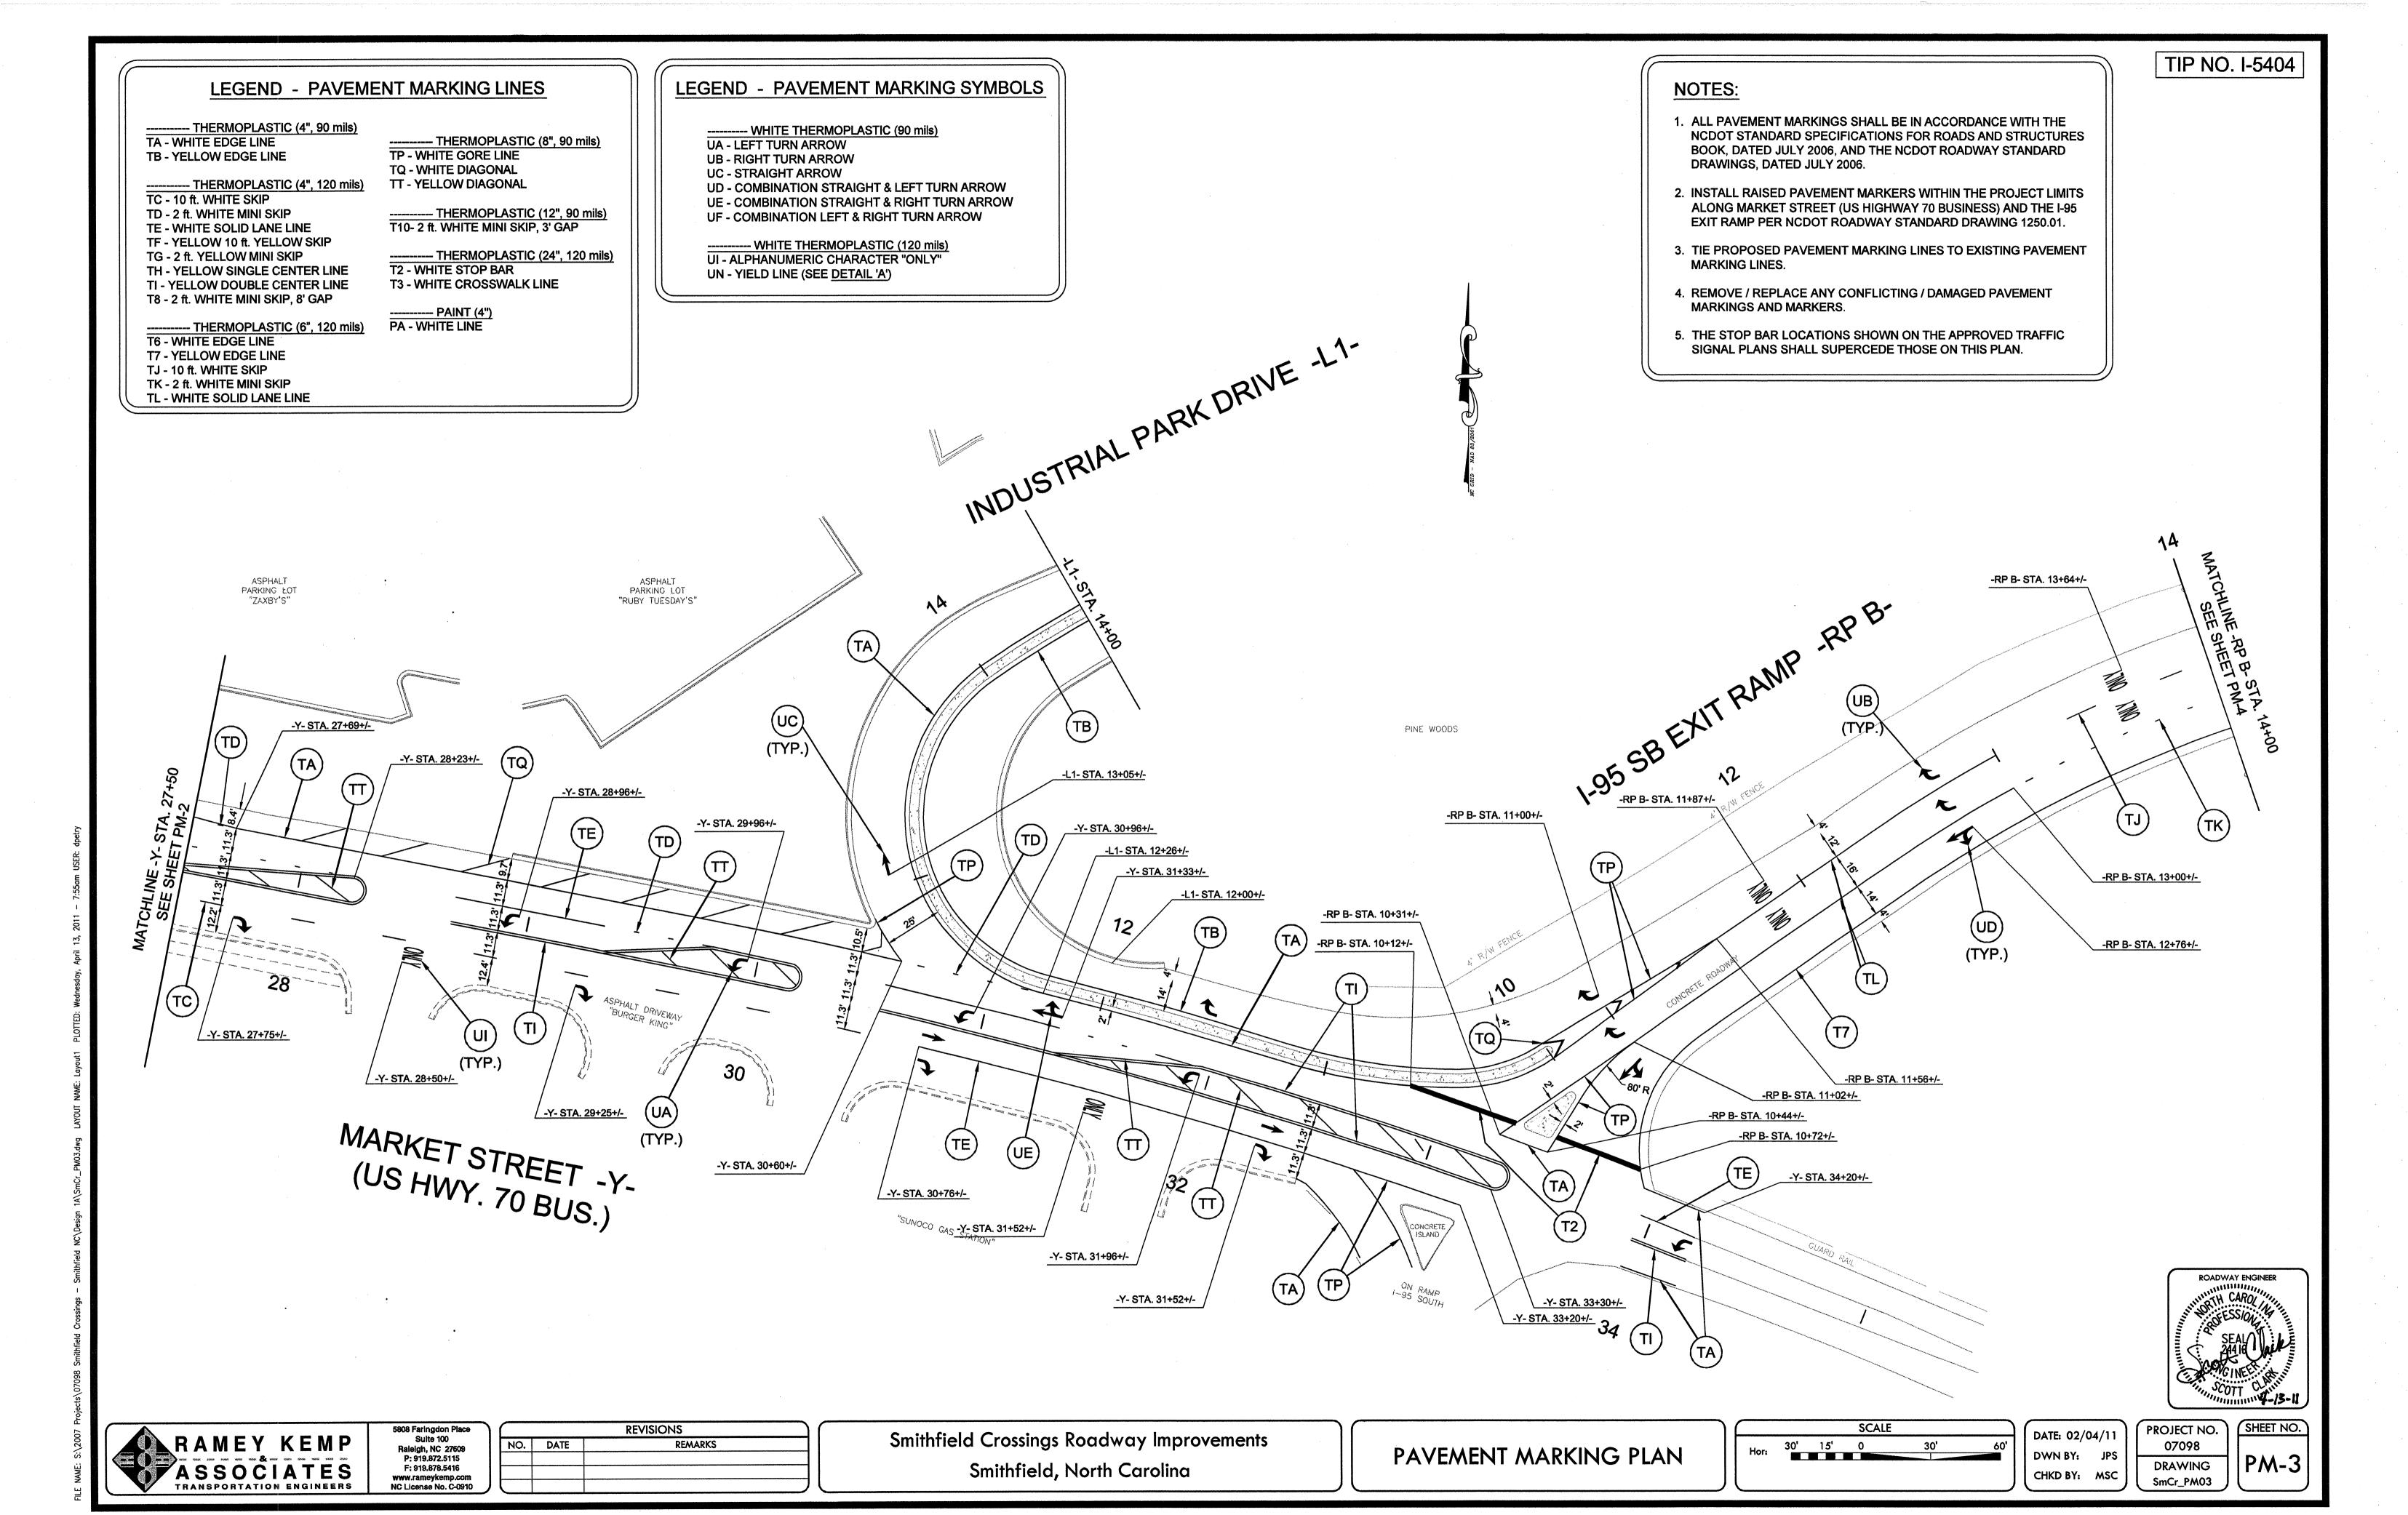

----- THERMOPLASTIC (4", 90 mils) TA - WHITE EDGE LINE

TB - YELLOW EDGE LINE

----- THERMOPLASTIC (4", 120 mils)

TC - 10 ft. WHITE SKIP TD - 2 ft. WHITE MINI SKIP

TE - WHITE SOLID LANE LINE TF - YELLOW 10 ft. YELLOW SKIP

TG - 2 ft. YELLOW MINI SKIP TH - YELLOW SINGLE CENTER LINE TI - YELLOW DOUBLE CENTER LINE

T8 - 2 ft. WHITE MINI SKIP, 8' GAP

----- THERMOPLASTIC (6", 120 mils)

T6 - WHITE EDGE LINE

T7 - YELLOW EDGE LINE TJ - 10 ft. WHITE SKIP

TK - 2 ft. WHITE MINI SKIP TL - WHITE SOLID LANE LINE

----- THERMOPLASTIC (8", 90 mils) TP - WHITE GORE LINE

TQ - WHITE DIAGONAL TT - YELLOW DIAGONAL

----- THERMOPLASTIC (12", 90 mils) T10 - 2 ft. WHITE MINI SKIP, 3' GAP

----- THERMOPLASTIC (24", 120 mils)

T2 - WHITE STOP BAR T3 - WHITE CROSSWALK LINE

----- PAINT (4") PA - WHITE LINE

LEGEND - PAVEMENT MARKING SYMBOLS

----- WHITE THERMOPLASTIC (90 mils)

UA - LEFT TURN ARROW

UB - RIGHT TURN ARROW

UC - STRAIGHT ARROW UD - COMBINATION STRAIGHT & LEFT TURN ARROW

UE - COMBINATION STRAIGHT & RIGHT TURN ARROW UF - COMBINATION LEFT & RIGHT TURN ARROW

----- WHITE THERMOPLASTIC (120 mils) UI - ALPHANUMERIC CHARACTER "ONLY"

UN - YIELD LINE (SEE DETAIL 'A')

NOTES:

1. ALL PAVEMENT MARKINGS SHALL BE IN ACCORDANCE WITH THE NCDOT STANDARD SPECIFICATIONS FOR ROADS AND STRUCTURES BOOK, DATED JULY 2006, AND THE NCDOT ROADWAY STANDARD DRAWINGS, DATED JULY 2006.

2. INSTALL RAISED PAVEMENT MARKERS WITHIN THE PROJECT LIMITS ALONG MARKET STREET (US HIGHWAY 70 BUSINESS) AND THE I-95 EXIT RAMP PER NCDOT ROADWAY STANDARD DRAWING 1250.01.

3. TIE PROPOSED PAVEMENT MARKING LINES TO EXISTING PAVEMENT MARKING LINES.

4. REMOVE / REPLACE ANY CONFLICTING / DAMAGED PAVEMENT MARKINGS AND MARKERS.

5. THE STOP BAR LOCATIONS SHOWN ON THE APPROVED TRAFFIC SIGNAL PLANS SHALL SUPERCEDE THOSE ON THIS PLAN.

(UB)(TYP.) -RP B- STA. 19+50+/-4' R/W FENCE 22 -RP B- STA. 20+50+/-20 I-95 SB EXIT RAMP -RP B--RP B- STA. 16+00+/-(T7)-RP B- STA. 15+00+/--RP B- STA. 14+50+/-




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Smithfield Crossings Roadway Improvements Smithfield, North Carolina

PAVEMENT MARKING PLAN



DATE: 02/04/11 CHKD BY: MSC PROJECT NO. 07098 DRAWING SmCr_PM04

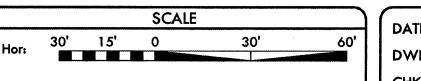TIP NO. I-5404

PM-4


STD. NO.	TITLE	
901.10	TYPE 'A' SIGNS	
901.20	TYPE `B' SIGNS	
901.30	VHB TAPE CONSTRUCTION - FOR TYPE `A' SIGNS	
901.40	VHB TAPE CONSTRUCTION - FOR TYPE `B' SIGNS	
901.50	ARROWS AND SHIELDS	
901.70	SIGN STRINGERS AND SUPPORT SPACING	
901.80	SIGN MOUNTING DETAILS - FOR TYPE A AND TYPE B SIGNS	
903.10	GROUND MOUNTED SIGN SUPPORTS	
903.20	WOOD SIGN SUPPORTS	
904.10	ORIENTATION OF GROUND MOUNTED SIGNS	

GENERAL NOTES

- . SIGNS FURNISHED BY CONTRACTOR
- . SIGNING PLANS DO NOT INCLUDE TEMPORARY CONSTRUCTION SIGNING OR PAVEMENT MARKINGS. SEE TRAFFIC CONTROL PLANS.
- . WHEN NOT STATIONED OR DIMENSIONED ON PLANS, ALL 'E' AND 'F' SIGNS SHALL BE FIELD LOCATED BY THE ENGINEER.
- . WHEN EXISTING SIGNS ARE REMOVED AND INSTALLED ON NEW SUPPORTS, THE RE-ERECTION SHALL IMMEDIATELY FOLLOW THE REMOVAL.
- . THE BACKGROUND FOR TYPE E & F SIGNS SHALL BE TYPE C REFLECTIVE SHEETING.
- . DO NOT BEGIN FABRICATION FOR TYPES A & B SIGNS MOUNTED ON OVERHEAD STRUCTURES OR STEEL SUPPORTS UNTIL "S" DIMENSIONS HAVE BEEN FIELD VERIFIED.
- . SEE ROADWAY PLANS FOR GUARD/GUIDE RAIL DETAILS.
- . ALL NEW INDIVIDUAL LOGO PANELS WILL BE SUPPLIED BY EACH PARTICIPATING BUSINESS AND INSTALLED BY NCDOT FORCES.
- .THE TOWN OF SMITHFIELD SHALL NOTIFY ALL BUSINESSES CURRENTLY PARTICIPATING IN THE NCDOT LOGO PROGRAM WHICH ARE AFFECTED BY THE GEOMETRIC REALIGNMENT OF THE ROADWAY, OF THE NEED FOR ANY ADDITIONAL LOGO PANELS AND ANY ASSOCIATED INCREASE IN ANNUAL PROGRAM COST.

INDEX

SHEET NO.	DESCRIPTION	
S-1 S-2	SIGNING GENERAL NOTES SUPPORT CHART	
S-8 S-9 S-10 S-11 - S-12 S-13 - S-14	SPECIFIC SERVICE SIGN LAYOUTS TYPE "E" SIGNS TYPE "F" SIGNS EXISTING SIGNING PLAN PROPOSED SIGNING PLAN	

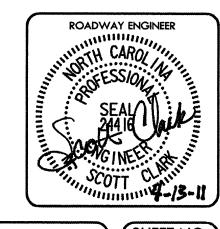



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REVISIONS NO. DATE REMARKS

Smithfield Crossings Roadway Improvements Smithfield, North Carolina

SIGNING GENERAL NOTES

N.T.S.

SCALE

DATE: 02/04/11 DWN BY: SPP CHKD BY: WJH PROJECT NO. 07098 DRAWING SmCr_SGN01

SHEET NO.

		I	SIGN						1		LENG	GTH (ft)		LEFT	SUPPOR	T (ft)	CENTE	R SUPP	ORT (ft)	RIGHT	SUPPOR	RT (ft)			B/A	SIMPLE			FIELD
SIGN	SIGN	I	SIZE	ROADWAY	NO.	BEAM	SUPPORT	ATTACH	NOUNTING	HORIZ.													FOOTING	FOOTING	SUPPORT	SUPPORT	REINF.	PLAIN	VERIFIED
NO.	TYPE	I	(in.)	STATION	OF	SECTION	TYPE	METHOD	METHOD	CLR.*	SNS HT	MTG HT	EMBED			TOTAL			TOTAL			TOTAL	DIAMETE	DEPTH	WEIGHTS	WEIGHTS	FTGS.	FTGS.	SEE NOTE
		w	x h		SUP.		BA or S		I	(ft.)	Н	C	MENT	S	L	LENGTH	S	L	LENGTH	S	L	LENGTH	(ft.)	(ft.)	(lbs.)	(lbs.)	(c.y.)	(c.y.)	(mm/dd/yy)
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		l					1	1	1																				\
1014	A	60	X 60	21+25 RT -Y-	2	S3x5.7	BA	N/A	N/A	2.00	5.00	7.11	3.5	0.00	12.11	15.61	0.00	0.00	0.00	-0.11	12.00	15.50	1	4	212.87	0.00	0.00	0.23	1/4/201
						<i>(</i>)																		\ \ \		J I			
102	В	48	X 54	30+25 LT -Y-	2	S3x5.7	BA	N/A	N/A	2.00	4.50	7.00	3	0.05	11.55	14.55	0.00	0.00	0.00	0.05	11.55	14.55	1	3.5	201.40	0.00	0.00	0.20	1/4/201
						-	/																	·>]	
103	B	48	X 72	11+50 LT -RP B	2 1	S3x5.7	/ BA	N/A	N/A	12.00	6.00	7.00	3.5	0.76	13.76	17.26	0.00	0.00	0.00	1.54	14.54	18.04	1	4	236.76	0.00	0.00	0.23	1/4/201
							\								10.05	40.05					44.05	47.05				ζ <u> </u>		>	
1044			X 60	27+25 LT -Y-	1 2 1	S3x5.7	BA	N/A	N/A	2.00	5.00	7.00	3.5	1.35	13.35	16.85	0.00	0.00	0.00	2.35	14.35	17.85		4	233.32	0.00	0.00	0.23	1/4/201
1.0.6			V 7.0	45.25 PT PD T		50-5 7	1			1.0.00		1 7 00]	2.06	15.06	10.56					14.70	10.20	4	1	245.06	7	/		1/4/201
106		48	X 72	15+75 RT -RP B	1 1	S3x5.7	BA	N/A 	N/A	12.00	6.00	7.00	3.5	2.06	15.06	18.56	0.00	0.00	0.00	1.70	14.70	18.20		4	245.06	0.00	0.00	0.23	1/4/201
107	λ	1	X 54	15+75 LT -RP B	1	S3x5.7	I BA	N/A	N/A	12.00	4.50	1 7.00		0 18	1 11 68	14 68	0 00	1 0.00	0.00	1.06	12.56	15.56		3.5	207.90	0.00	0.00	0.20	1/4/201
		54			1 1	3323.7	DA	I	II		4.30	1	1		1	14.00		1	0.00 	1.00	12.50	15.56			207.30 J	1.00		0.20	
109		1	X 108	17+00 LT -RP B	1 2 1	W6x12	l Bà	l N/A	N/A	12.00	1 9 00	17.00	1 451	0 69	16 69	21 19	0 00	0.00	0.00	1.79	17.79	22.29		5	607.12	0.00	0.65	0.00	1/4/2012
				109 for Support Size)			1	1																					
110			X 108	18+50 RT -RP B		W6x12	i BA	N/A	N/A	12.00	9.00	7.00	4.5	2.24	18.24	22.74	0.00	0.00	0.00	1.71	17.71	22.21	1.5	5	624.76	0.00	0.65	0.00	1/4/2012
					i i																								
111	A	90	X 108	18+50 LT -RP B	2 1	W6x12	BA	N/A	N/A	12.00	9.00	7.00	4.5	0.72	16.72	21.22	0.00	0.00	0.00	1.03	17.03	21.53	1.5	5	598.36	0.00	0.65	0.00	1/4/2012
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112	A		X 108	20+00 LT -RP B	2 1	W6x12	BA	N/A	N/A	12.00	9.00	7.00	4.5	0.89	16.89	21.39	0.00	0.00	0.00	1.25	17.25	21.75	1.5	5	603.04	0.00	0.65	0.00	1/4/201
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											NOTE:	ELIMINA	E HINGE C	CONNEC	TION FO	R SIGNS OF	N 1 BRE	AKAWAY	SUPPORT	Γ!						V	V		
																									TOTAL	TOTAL	TOTAL	TOTAL	
																									3770.61	0.00	2.62	1.34	
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																										Λ			

ROADWAY ENGINEER



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REVISIONS NO. DATE REMARKS

1 11-4-11 REMOVE LINE ITEMS
2 1-17-12 S DIMENSION FIELD VERIFICATION
3 2-8-12 SIGN SIZE MODIFICATION


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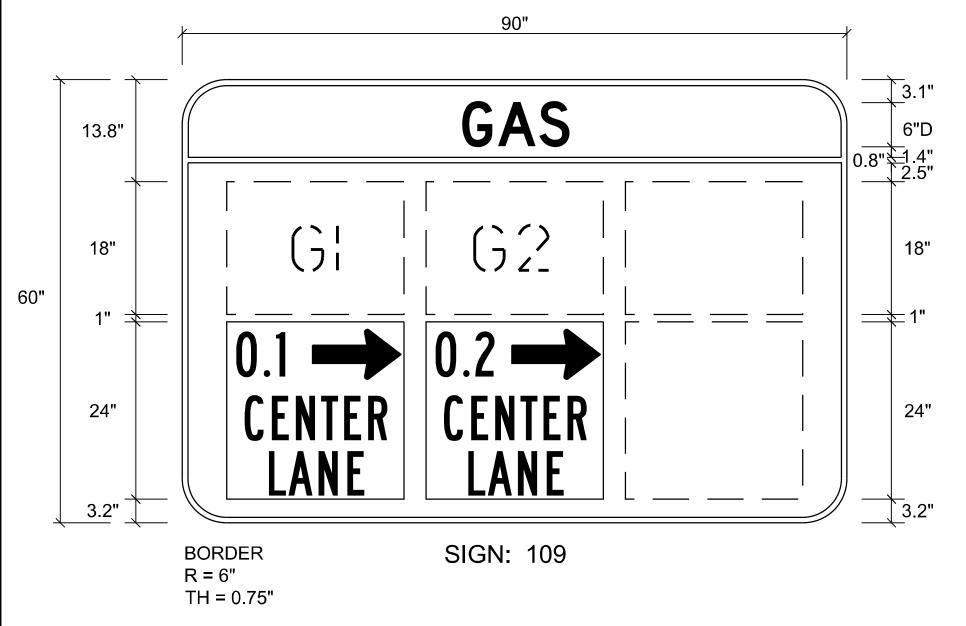
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SHEET NO. SmCr_SGN01





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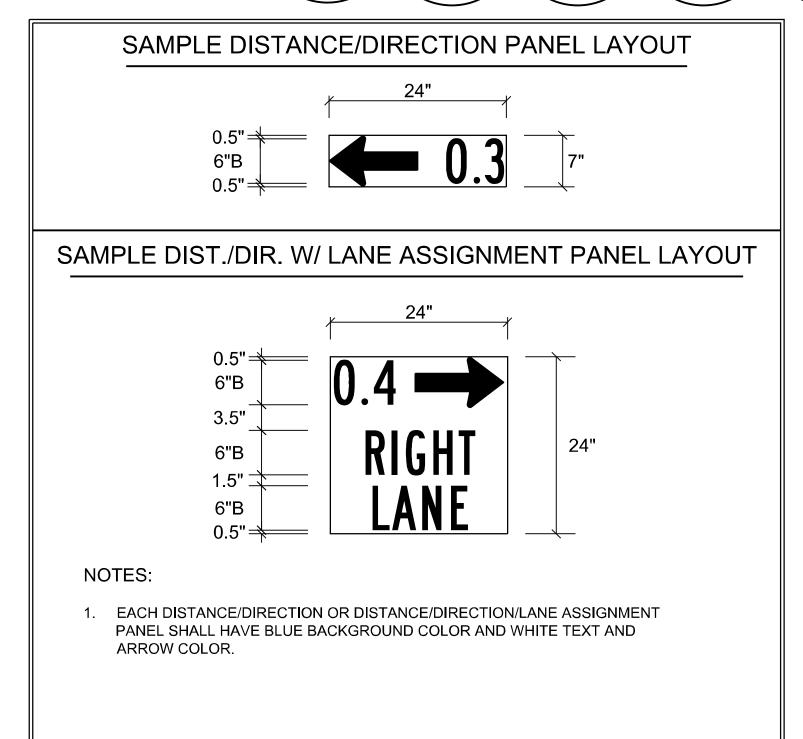
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LOGO PANEL	BUSINESS	DIST./DIR.	LANE ASSIGNMENT
12	THE VILLAGE MOTOR LODGE	0.5	
L3	LOG CABIN MOTEL	0.6	
L4	JAMESON INN	0.0	CENTER LANE
15	SUPER 8 MOTEL	0.3	RIGHT LANE
L6	SLEEP INN	0.4	RIGHT LANE
F1	TEXAS STEAKHOUSE	0.1	CENTER LANE
F2	RUBY TUESDAY	0.1	CENTER LANE
F3	BURGER KING	0,1	CENTER LANE
F4	WAFFLE HOUSE	0.3	CENTER LANE
F5	ZAXBY'S	0.3	CENTER LANE
F6	CICI'S PIZZA	0.3	CENTER LANE
F7	SMITHFIELD'S CHICKEN & BBQ	2.0 —	CENTER LANE
F8	BOB EVANS	0.4	RIGHT LANE
F9	CRACKER BARREL	0.8	RIGHT LANE
_		-	
G1	SUNOCO	0.1	CENTER LANE
G2	HESS	0.2	CENTER LANE
		-	
		-	

NOTES:

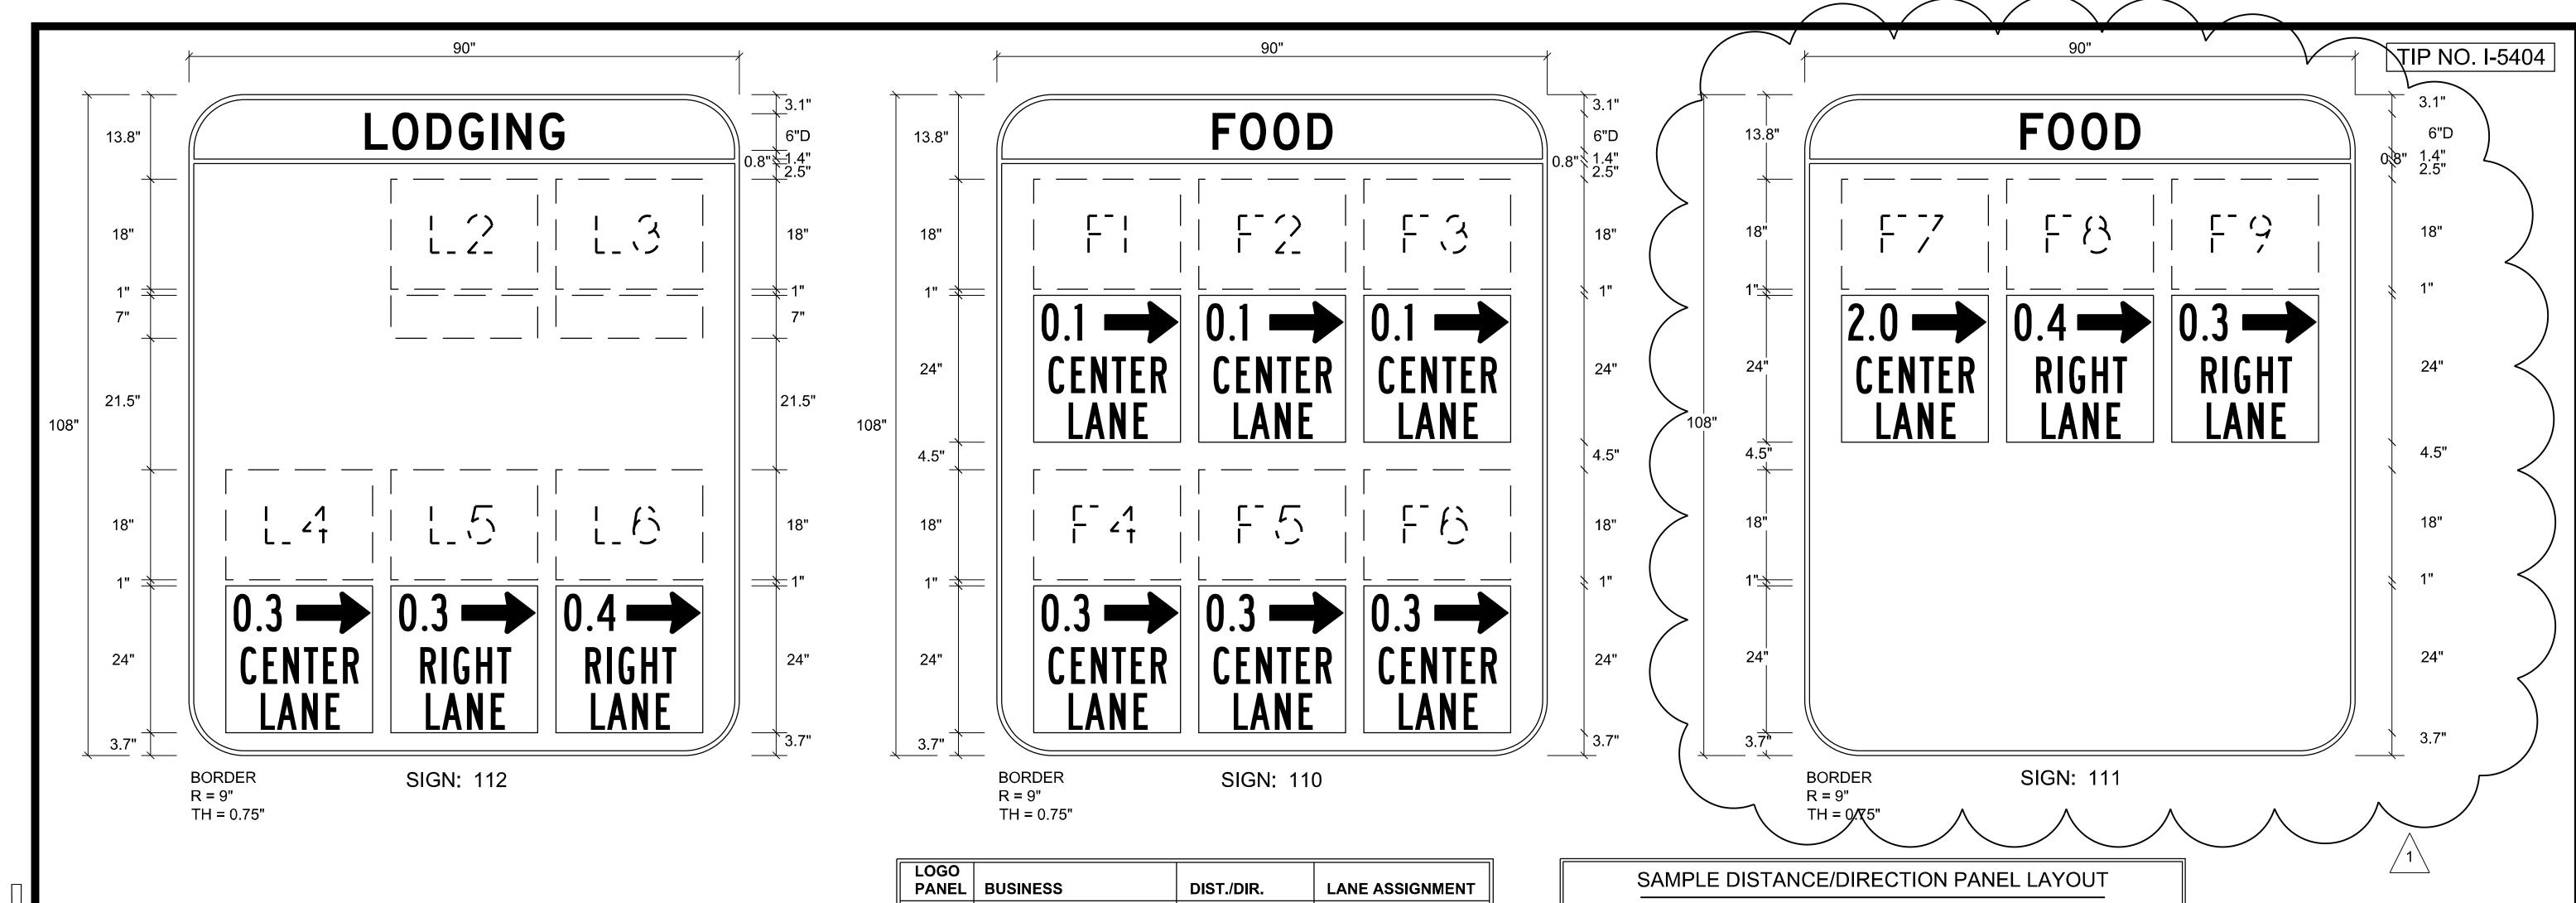- 1. LEGEND AND BORDER SHALL BE DIRECT APPLIED A SHEETING.
- 2. BACKGROUND SHALL BE GRADE C REFLECTIVE SHEETING.
- EACH SPECIFIC SERVICE SIGN SHALL HAVE BLUE BACKGROUND COLOR AND WHITE BORDER AND TEXT COLOR.
- 4. ALL LOGO PANELS ARE EXISTING AND SHOULD BE RE-USED ON THESE NEW SIGNS AS SHOWN.



RAMEY KEMP ASSOCIATES
TRANSPORTATION ENGINEERS

REVISIONS NO. DATE REMARKS 2-6-12 SIGN MODIFICATIONS

Smithfield Crossings Roadway Improvements Smithfield, North Carolina

SPECIFIC SERVICE SIGN LAYOUTS


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DATE: 02/04/1 DWN BY: SPP CHKD BY: WJH


SHEET NO. PROJECT NO. 07098 DRAWING

S-8 SmCr_SGN04

ROADWAY ENGINEER

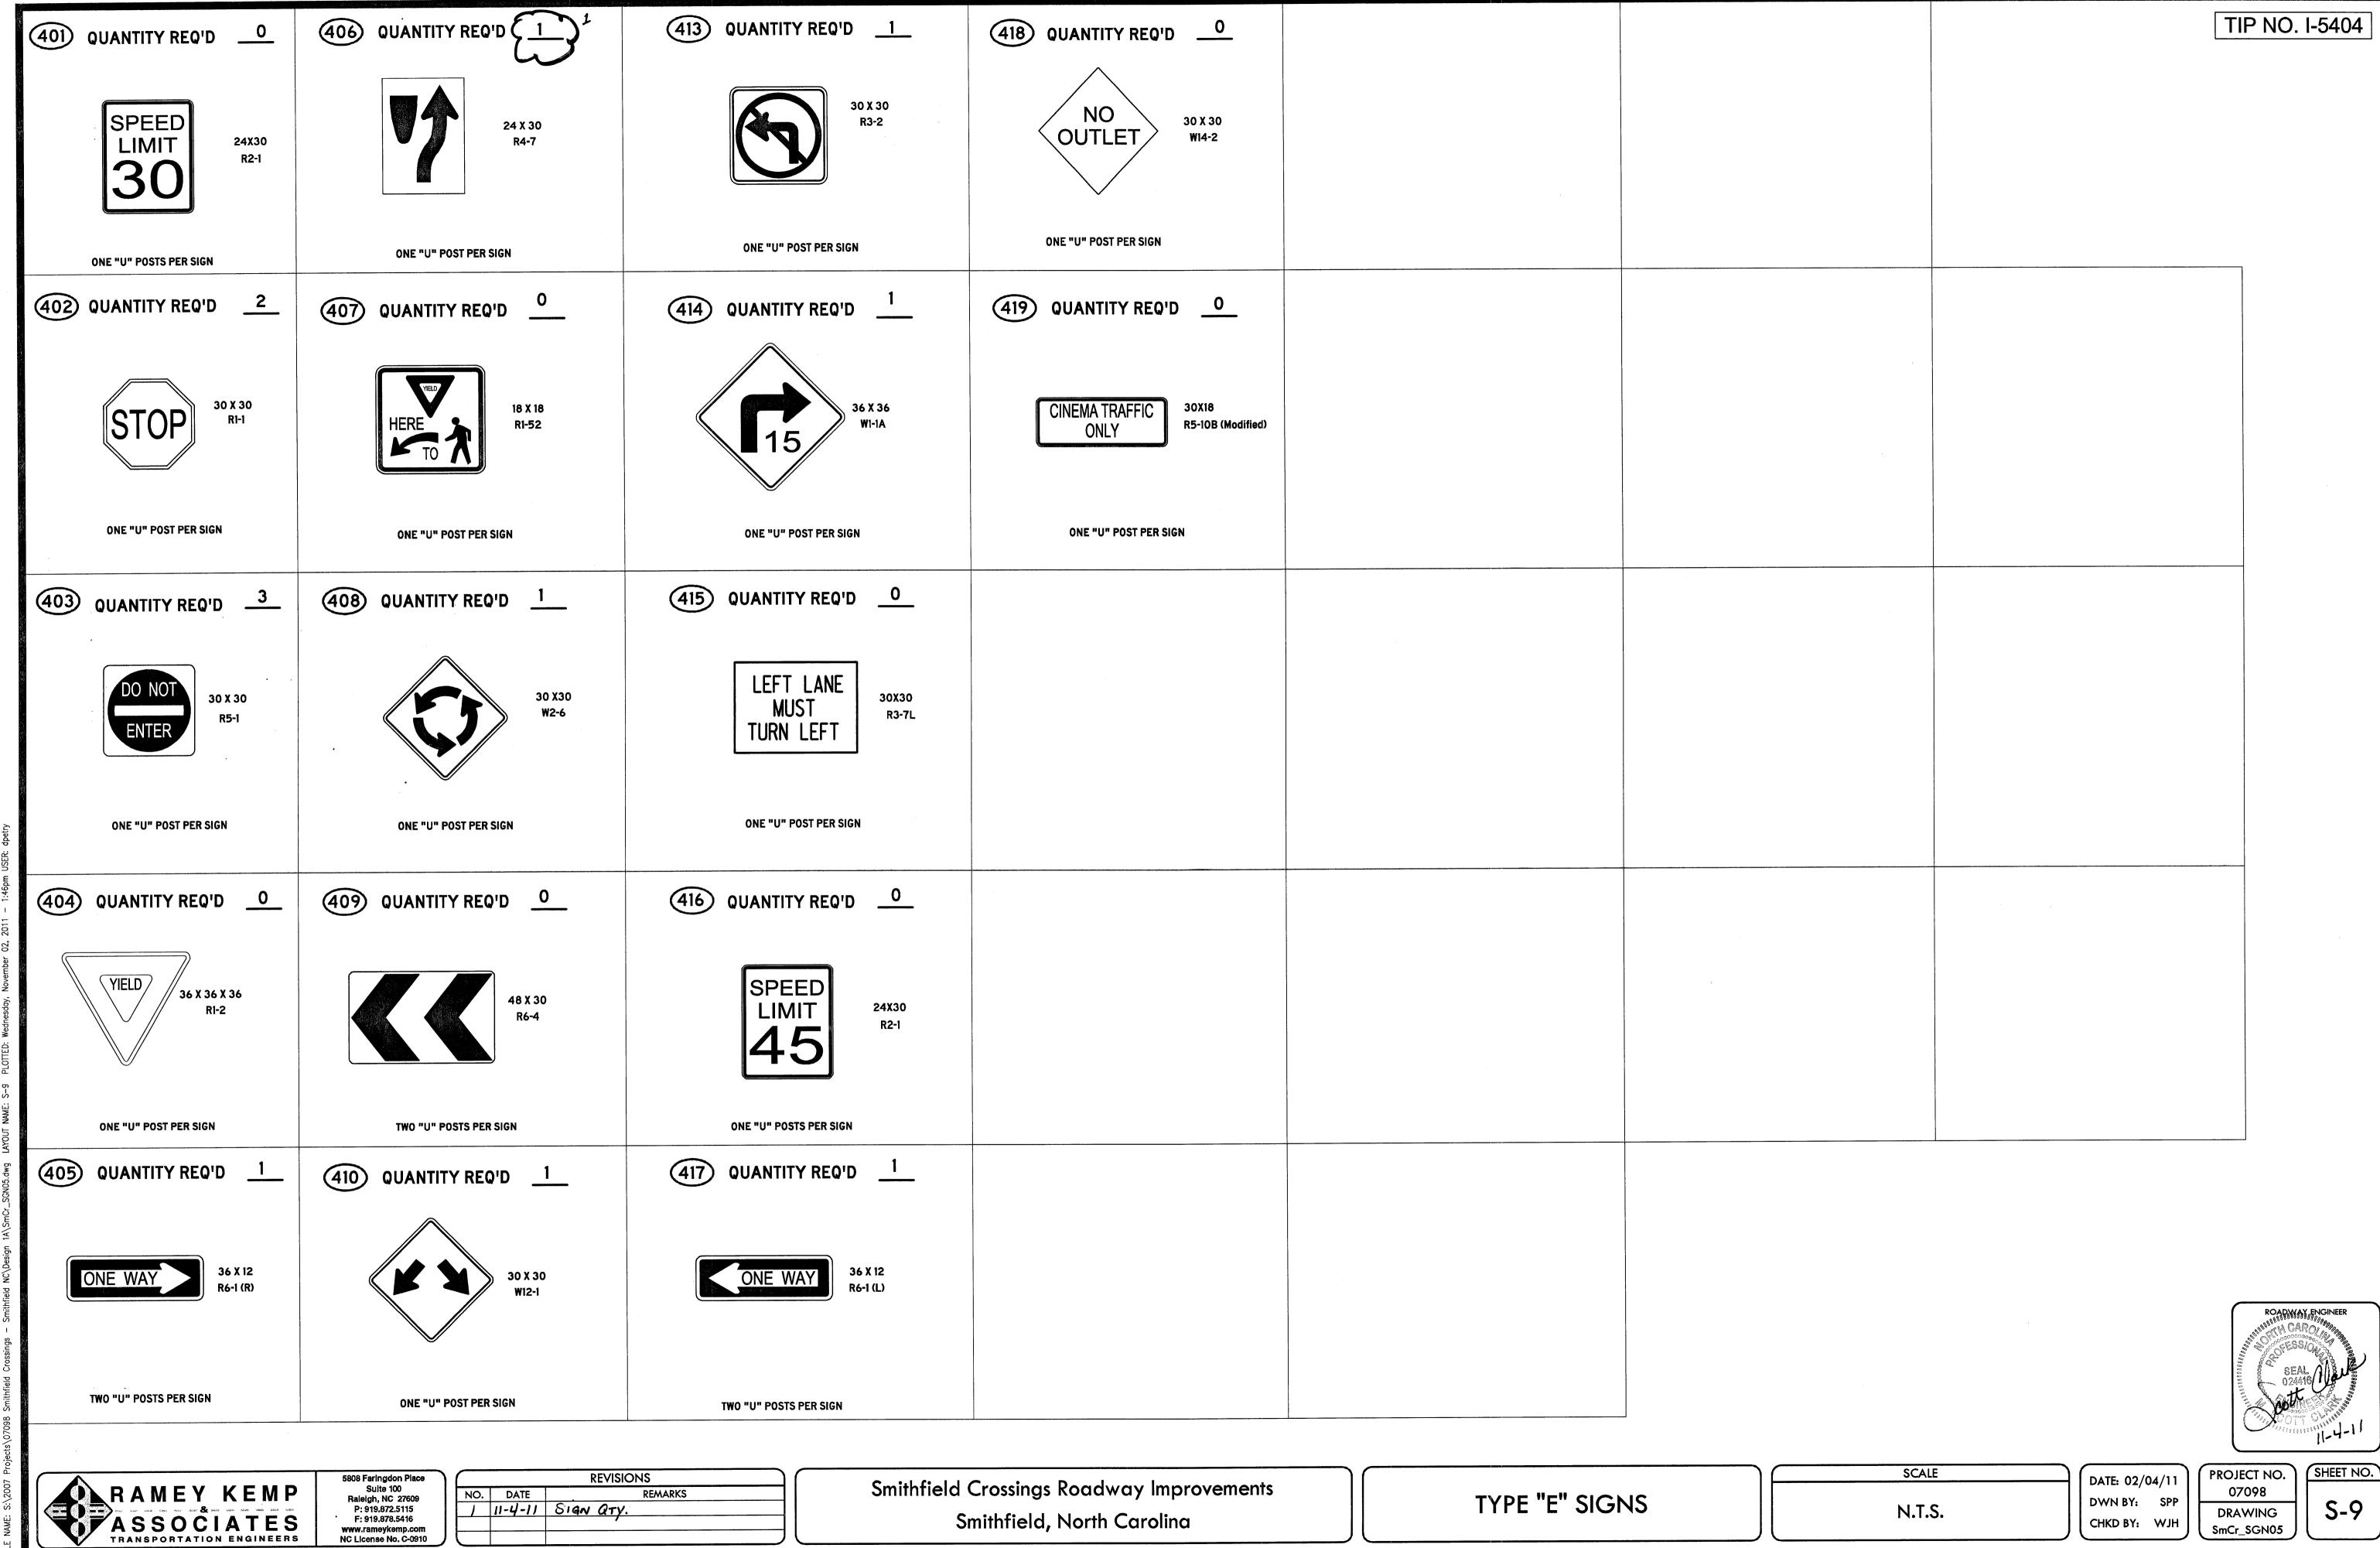

SmCr_SGN05

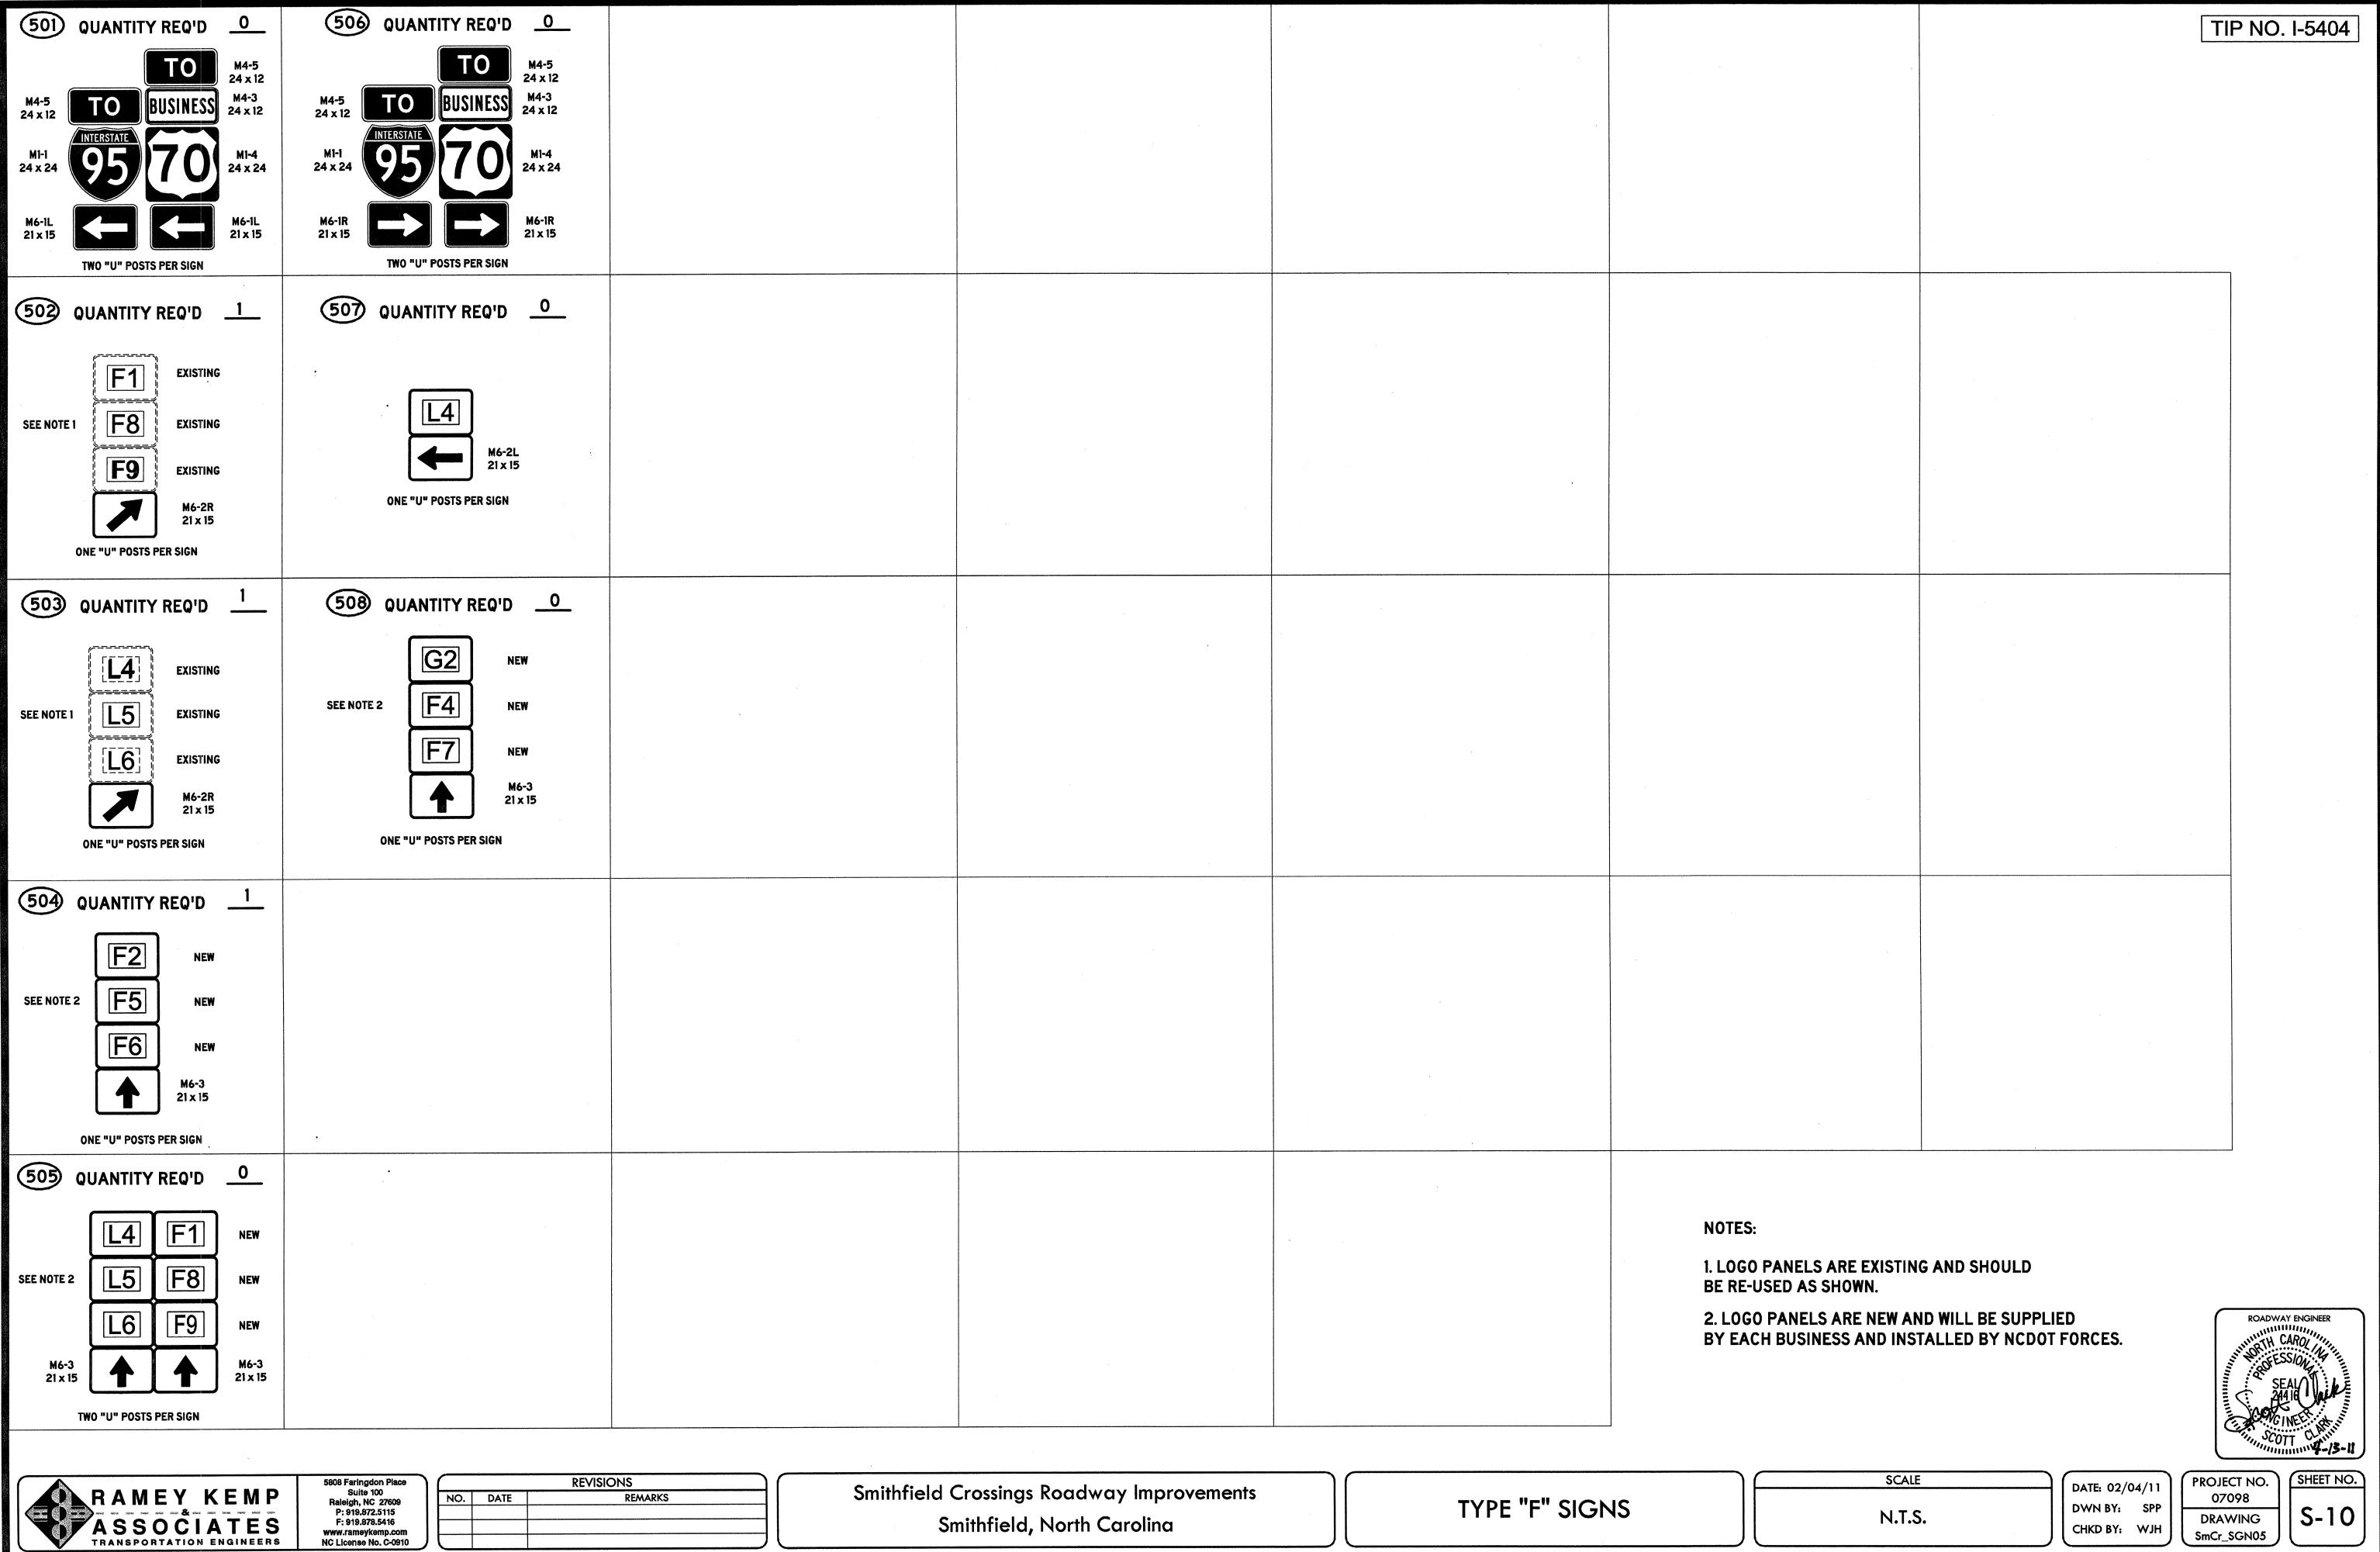


Smithfield, North Carolina

TYPE "F" SIGNS


CHKD BY: WJH

DRAWING

S-10 SmCr_SGN05

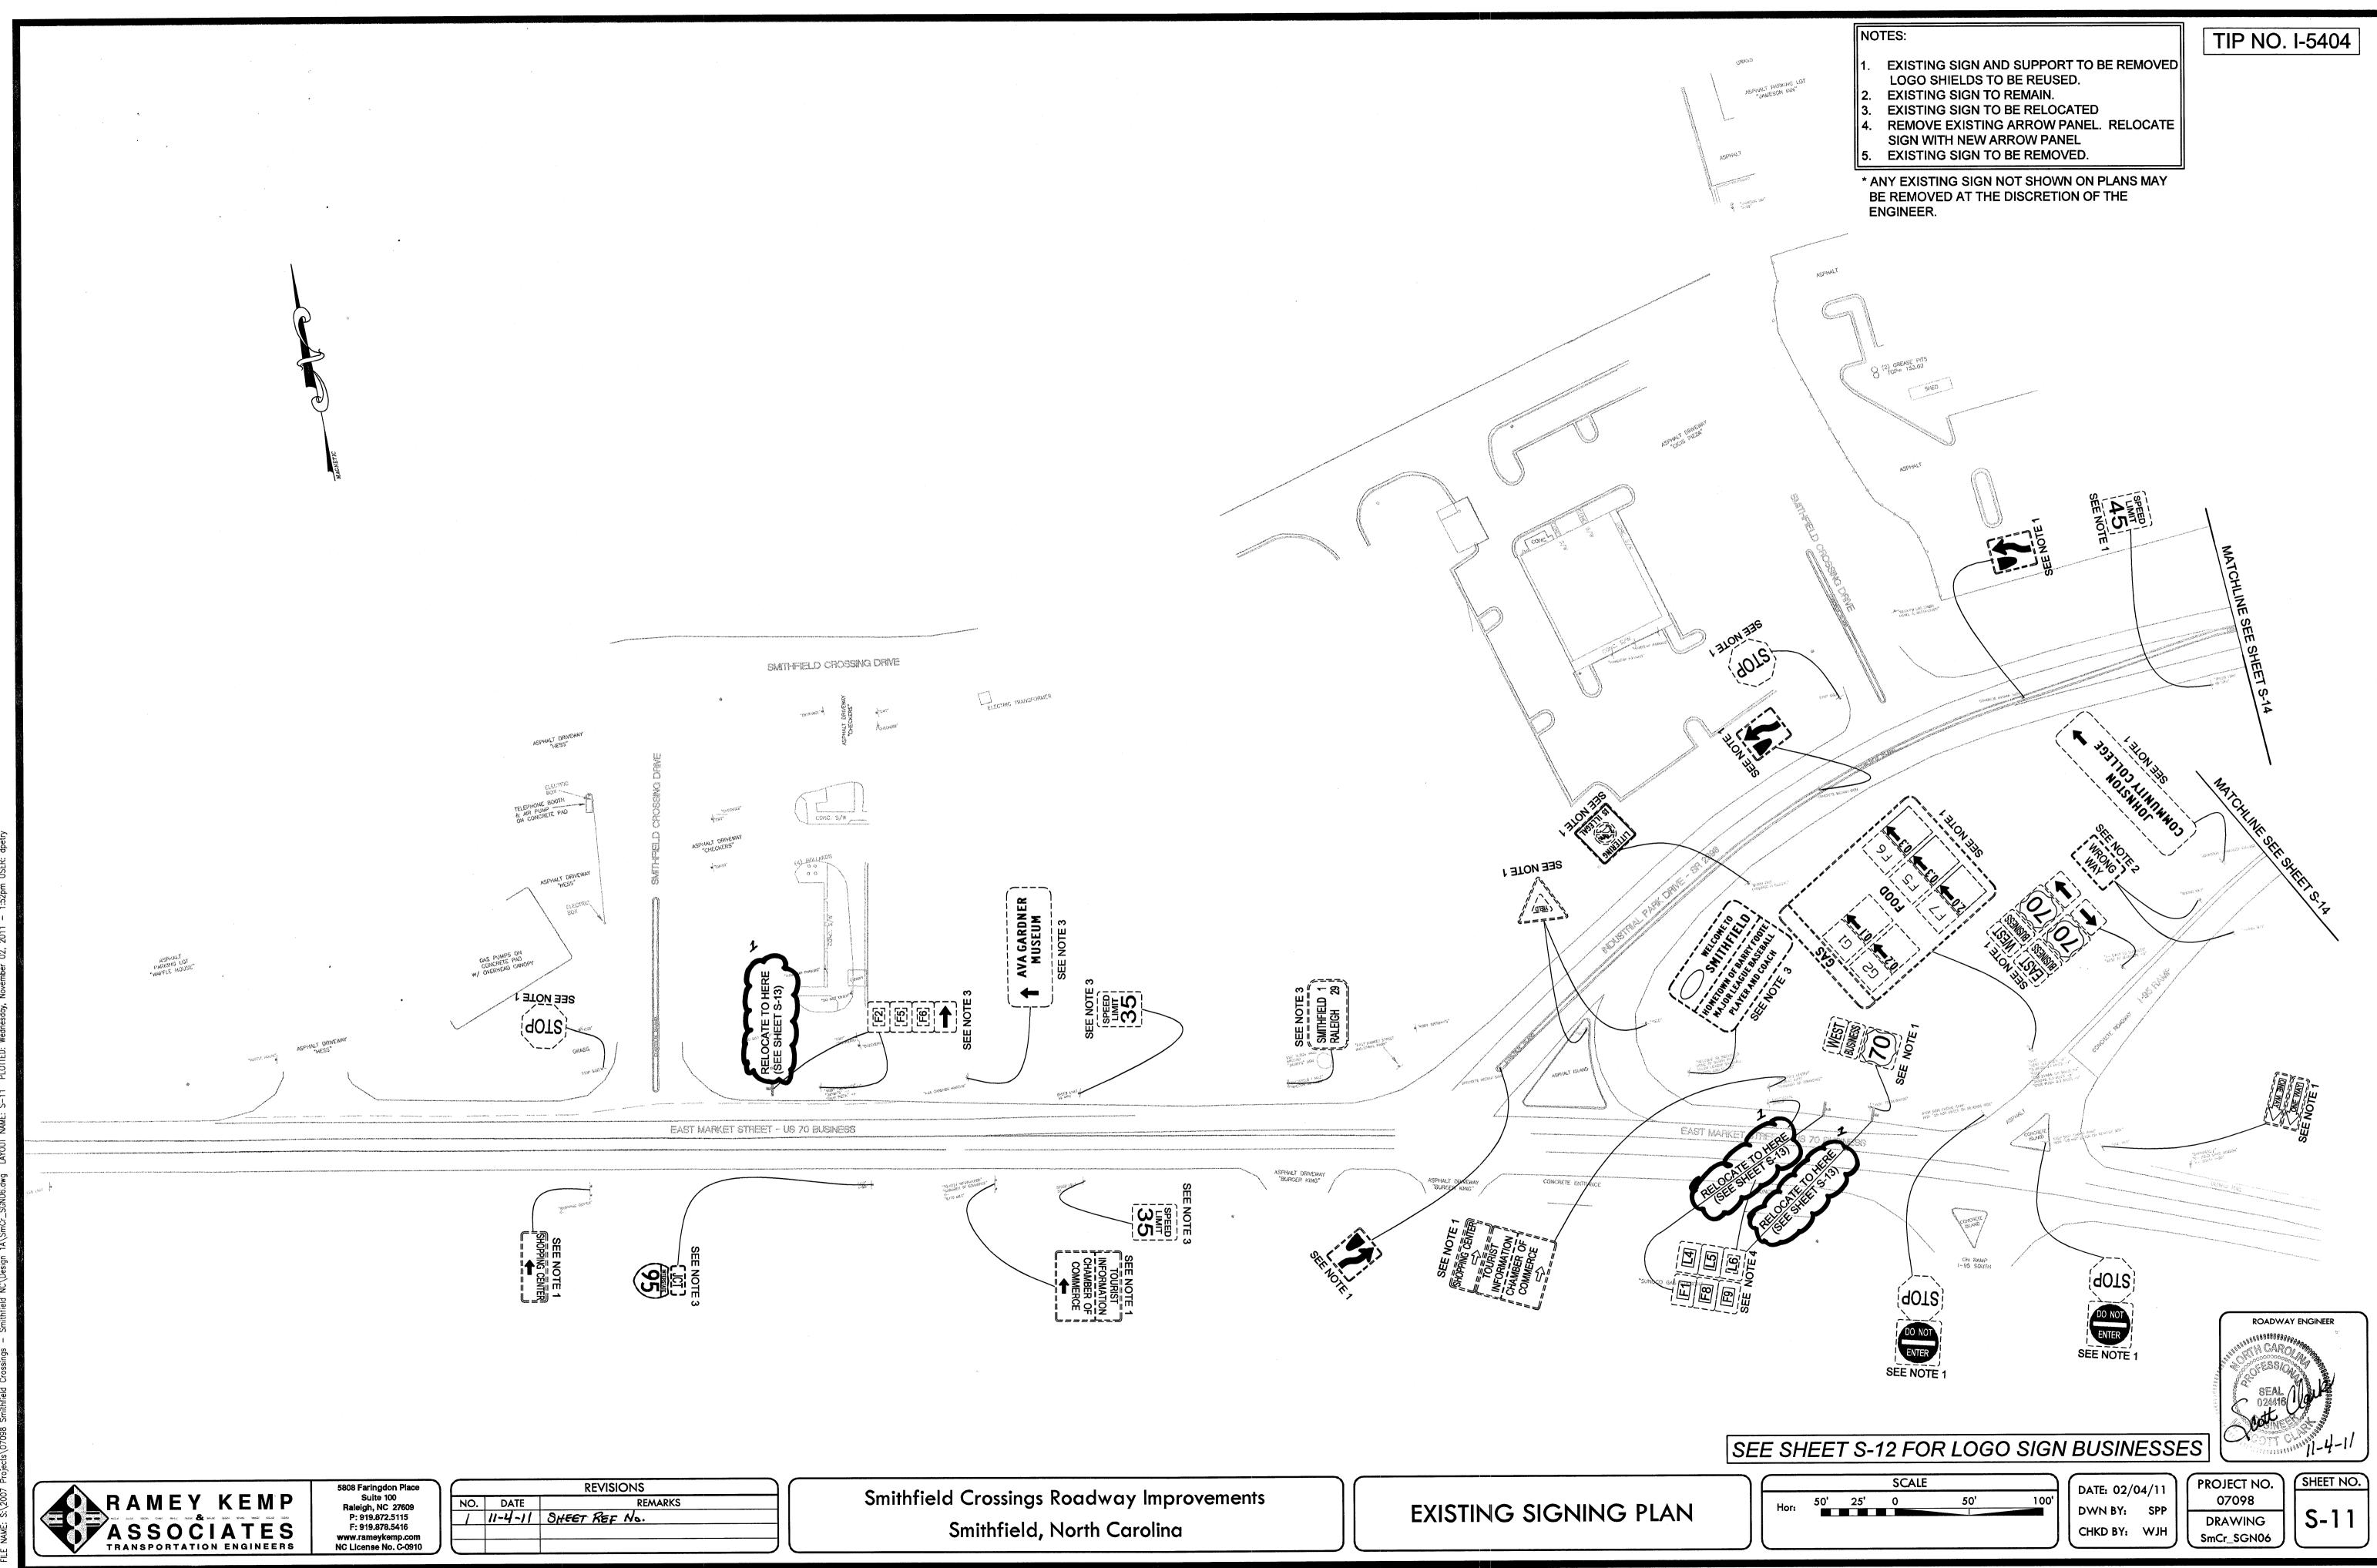

FILE NAME: S:\2007

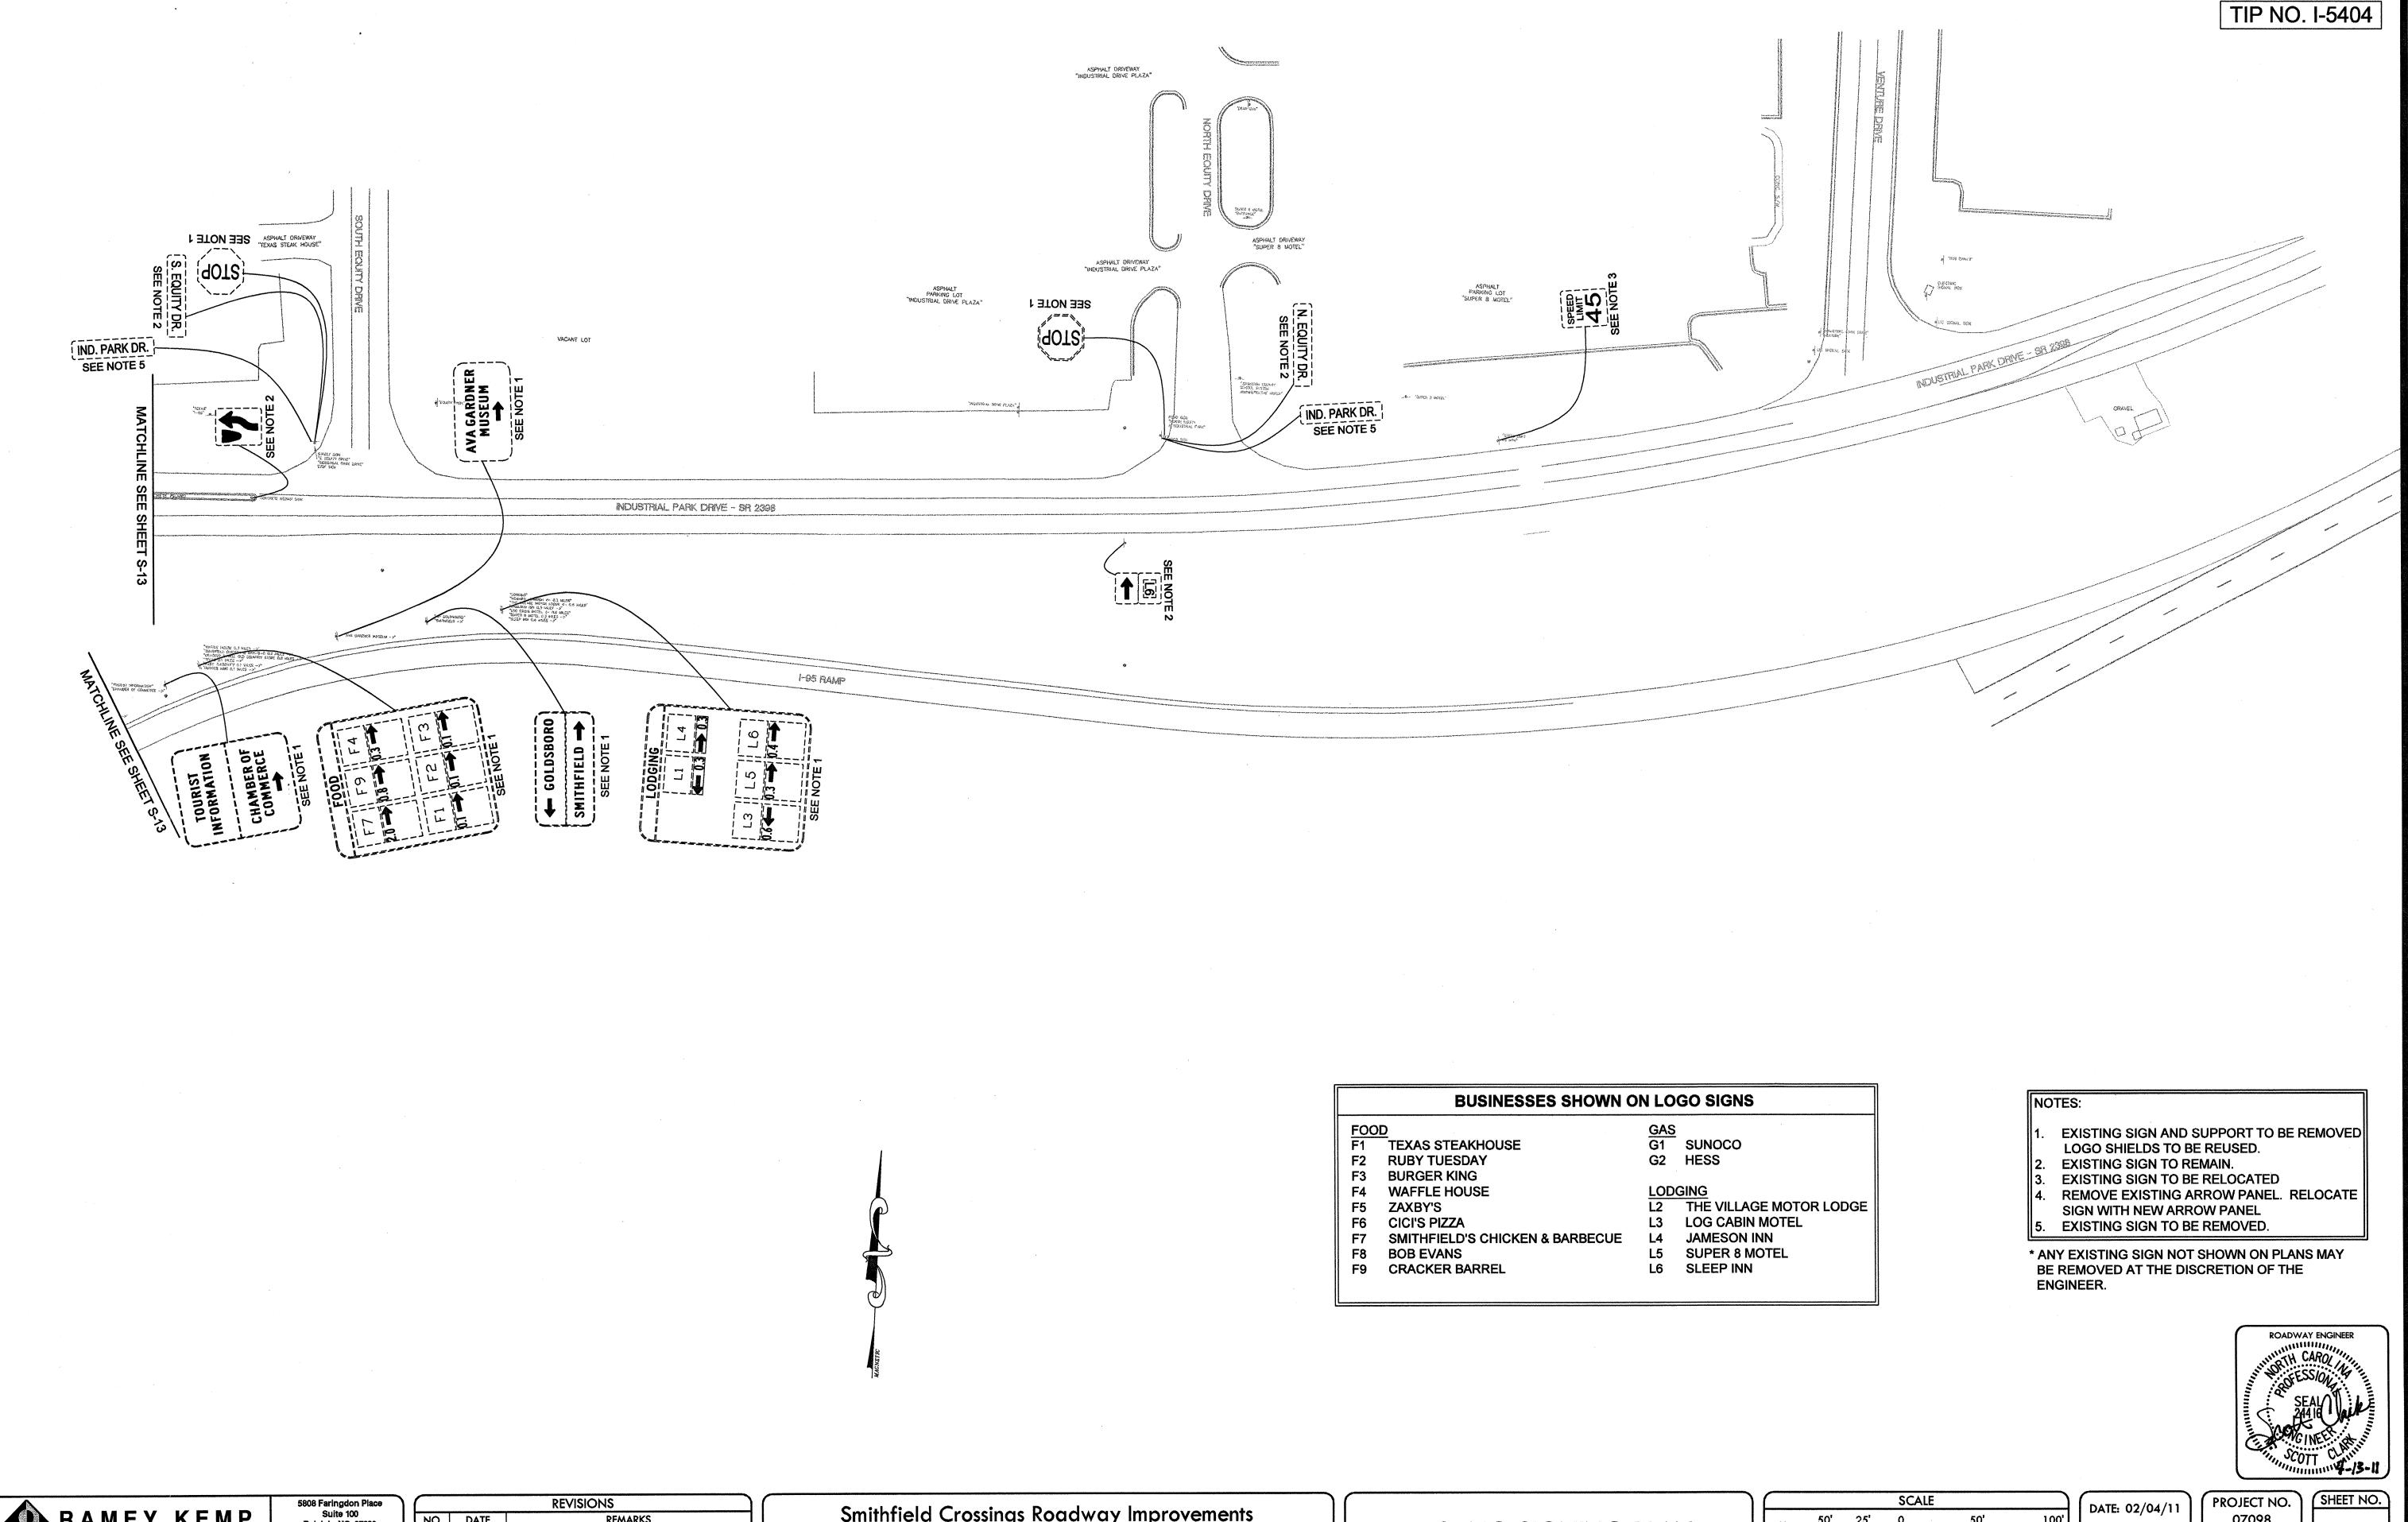


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NO. DATE REMARKS


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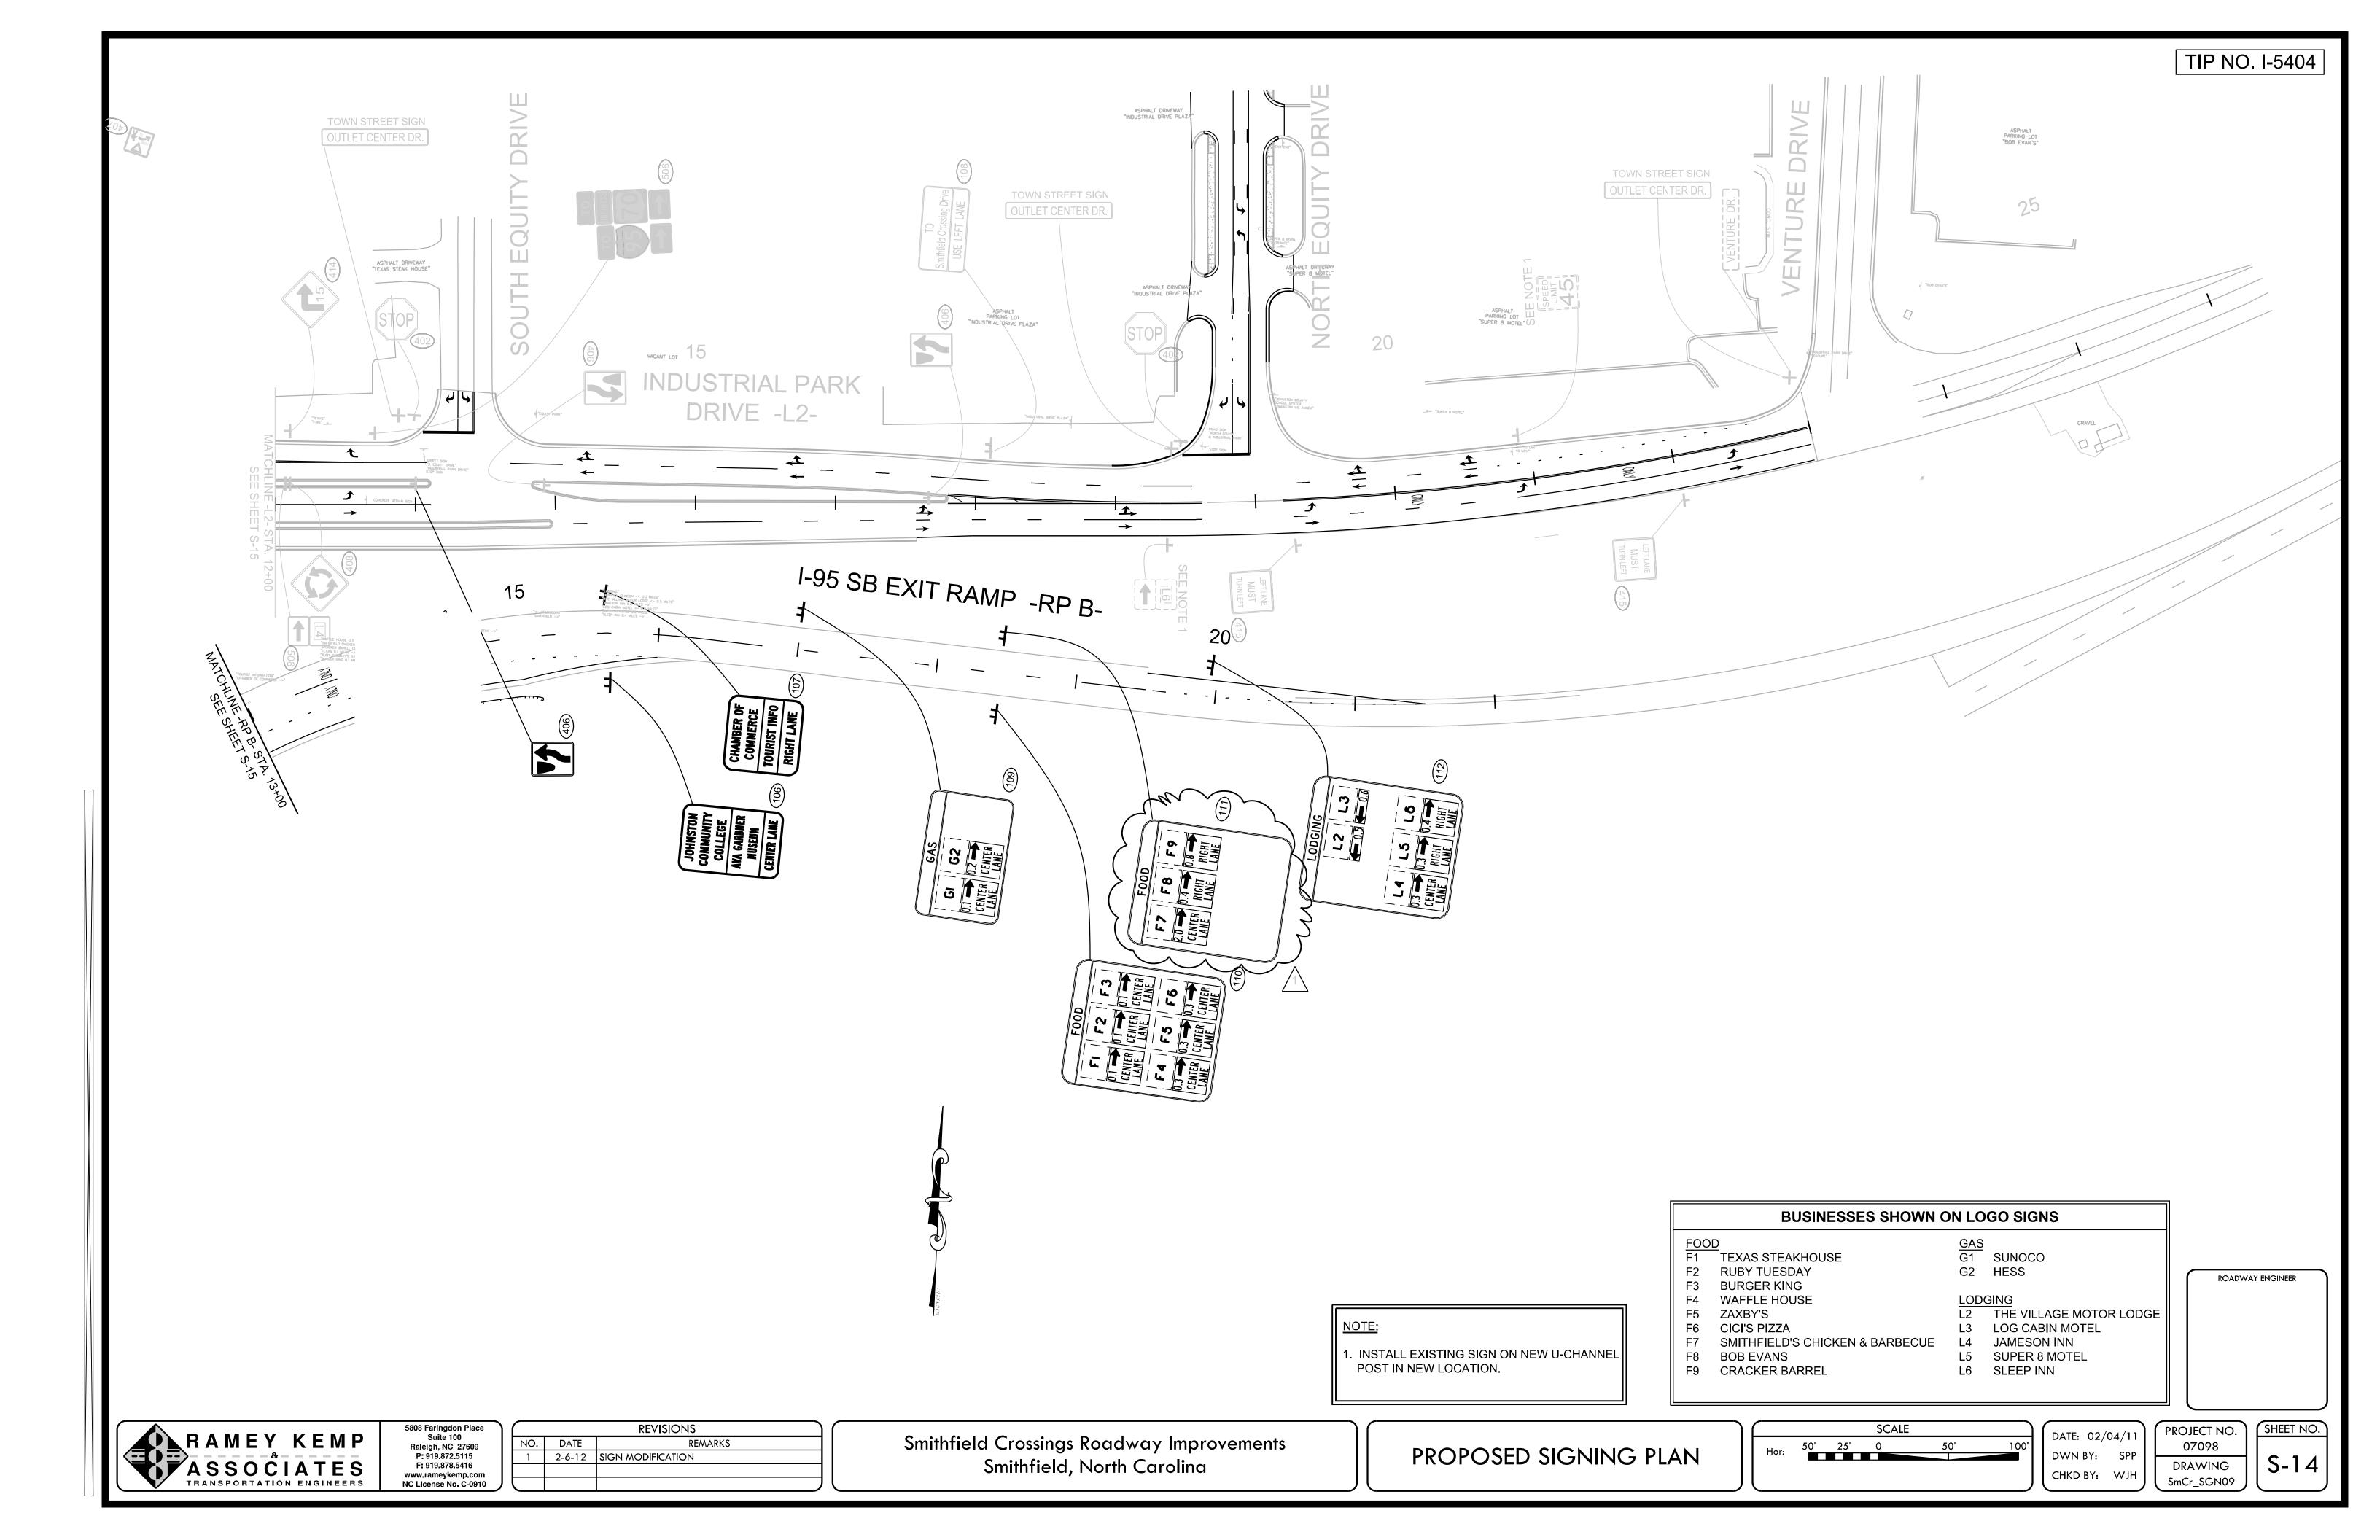
EXISTING SIGNING PLAN





DRAWING SmCr_SGN07

S-12

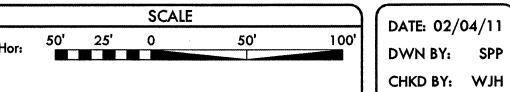

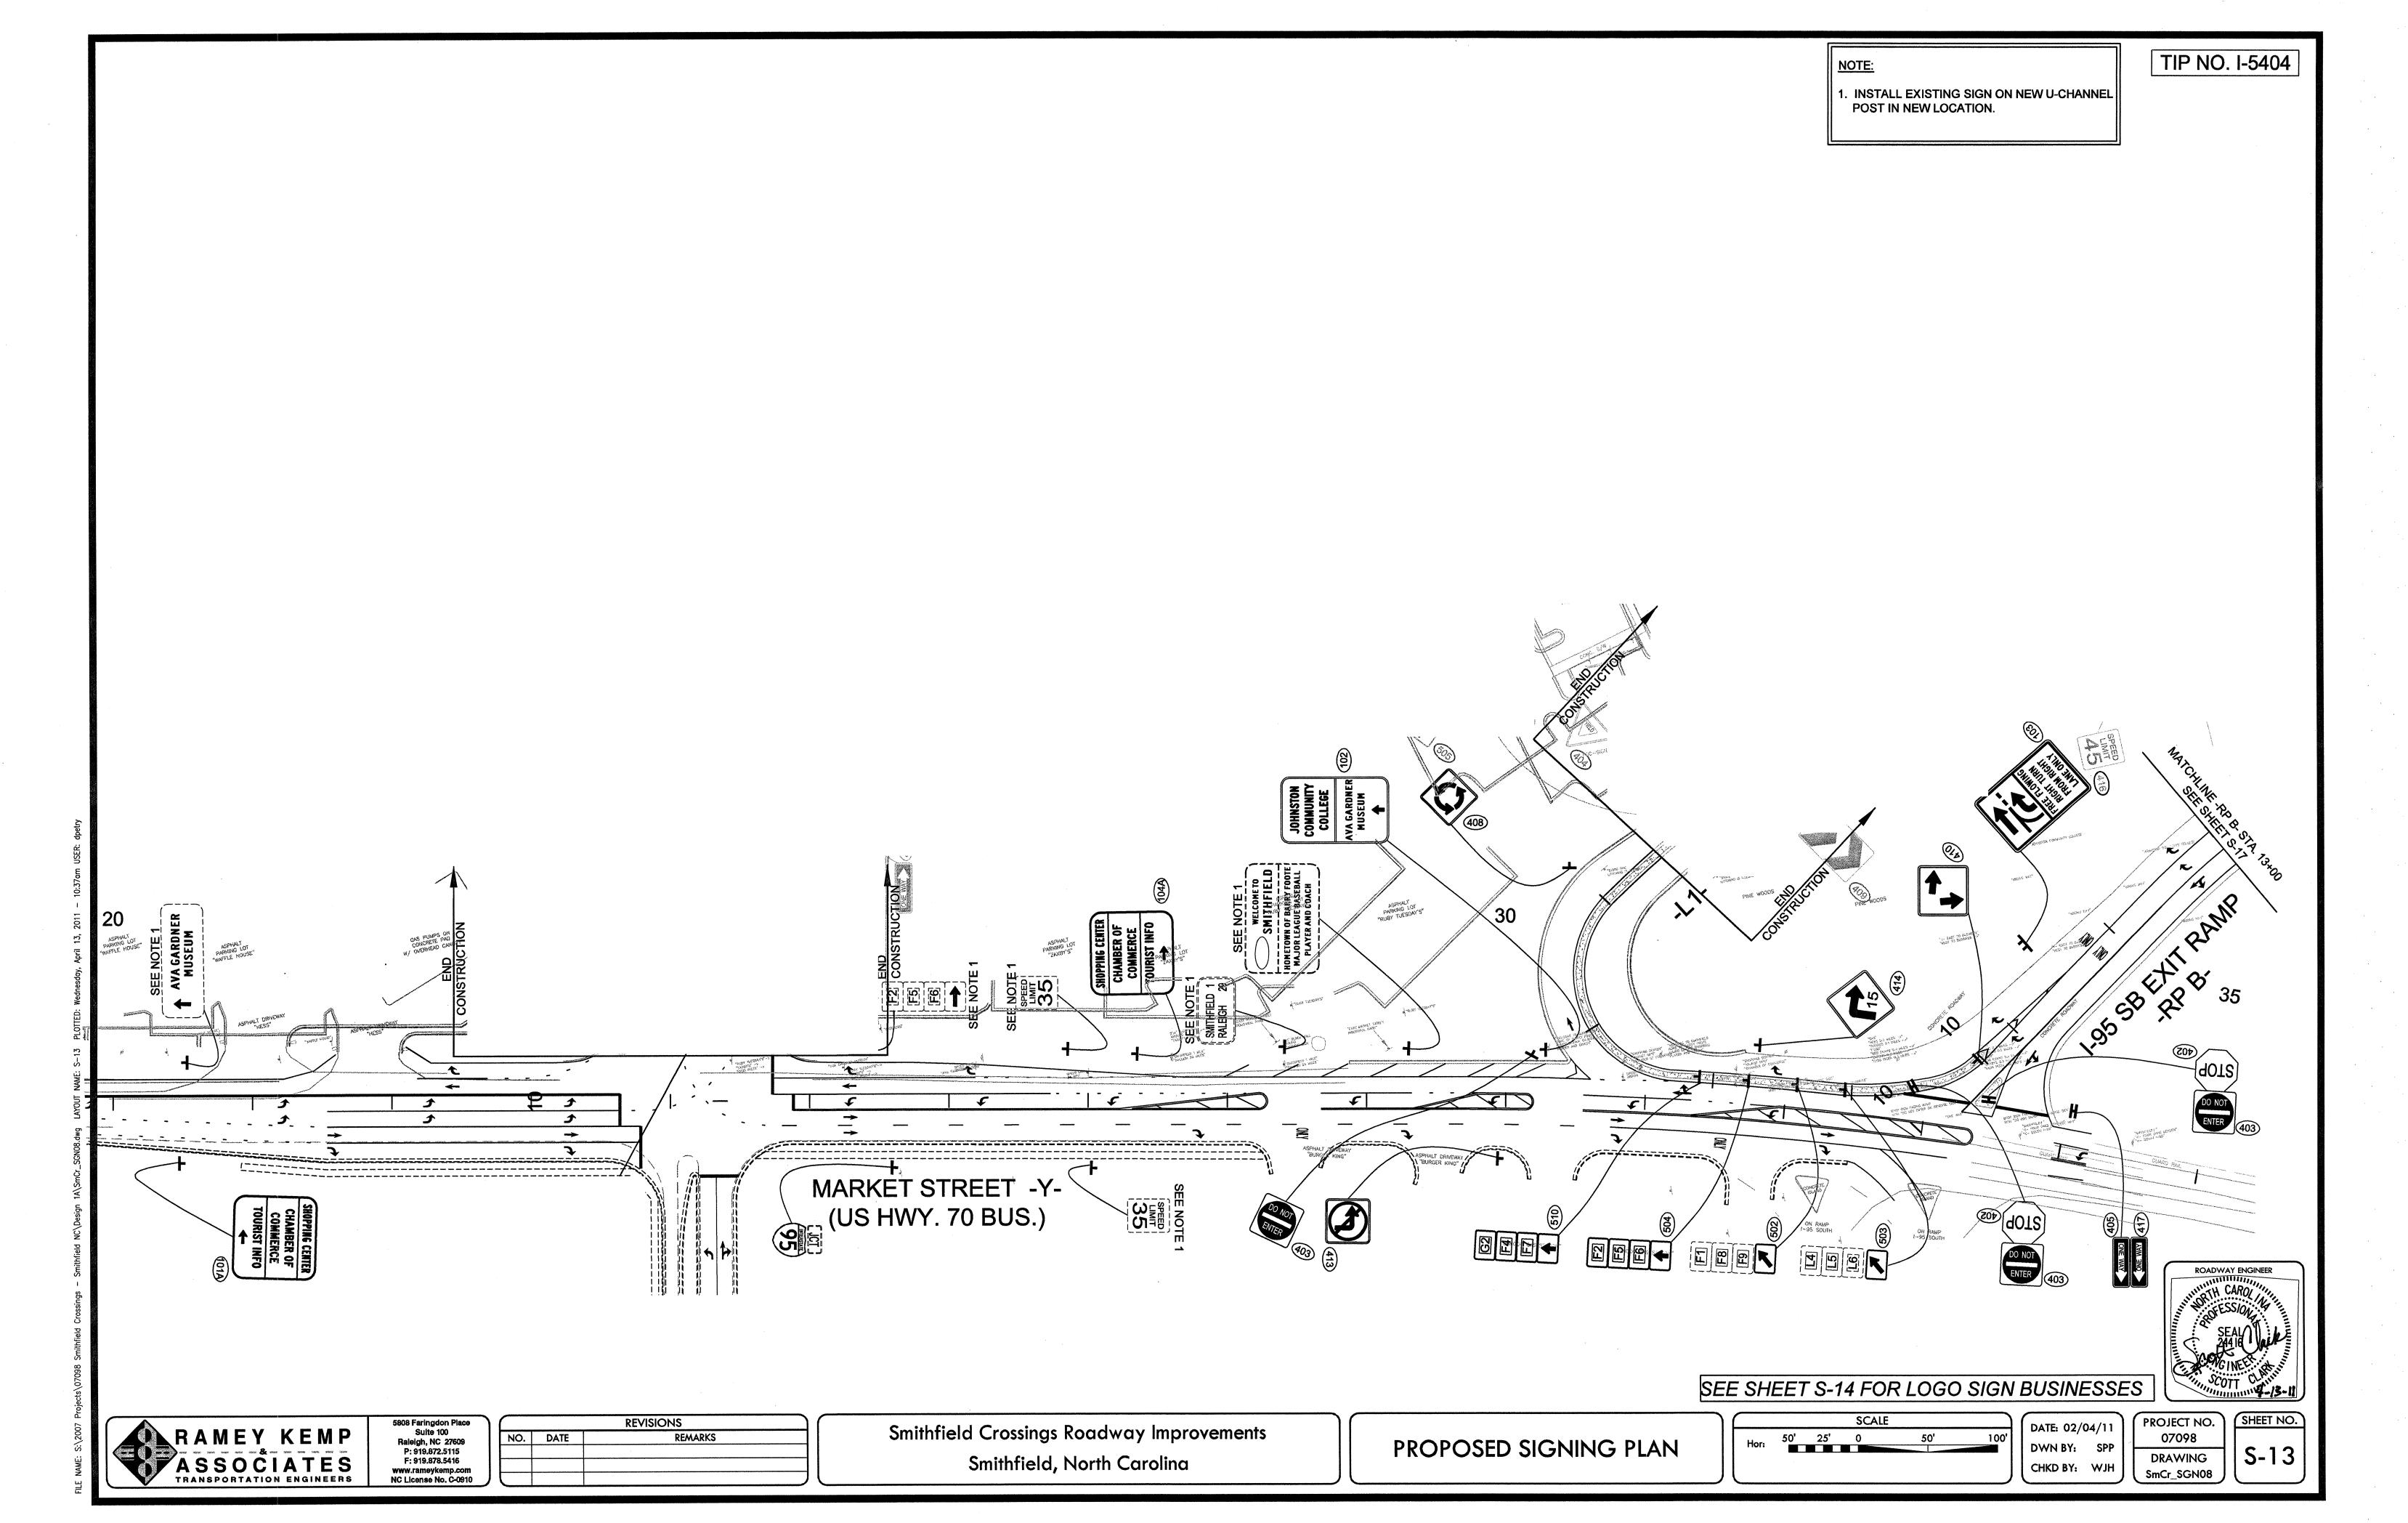

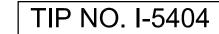


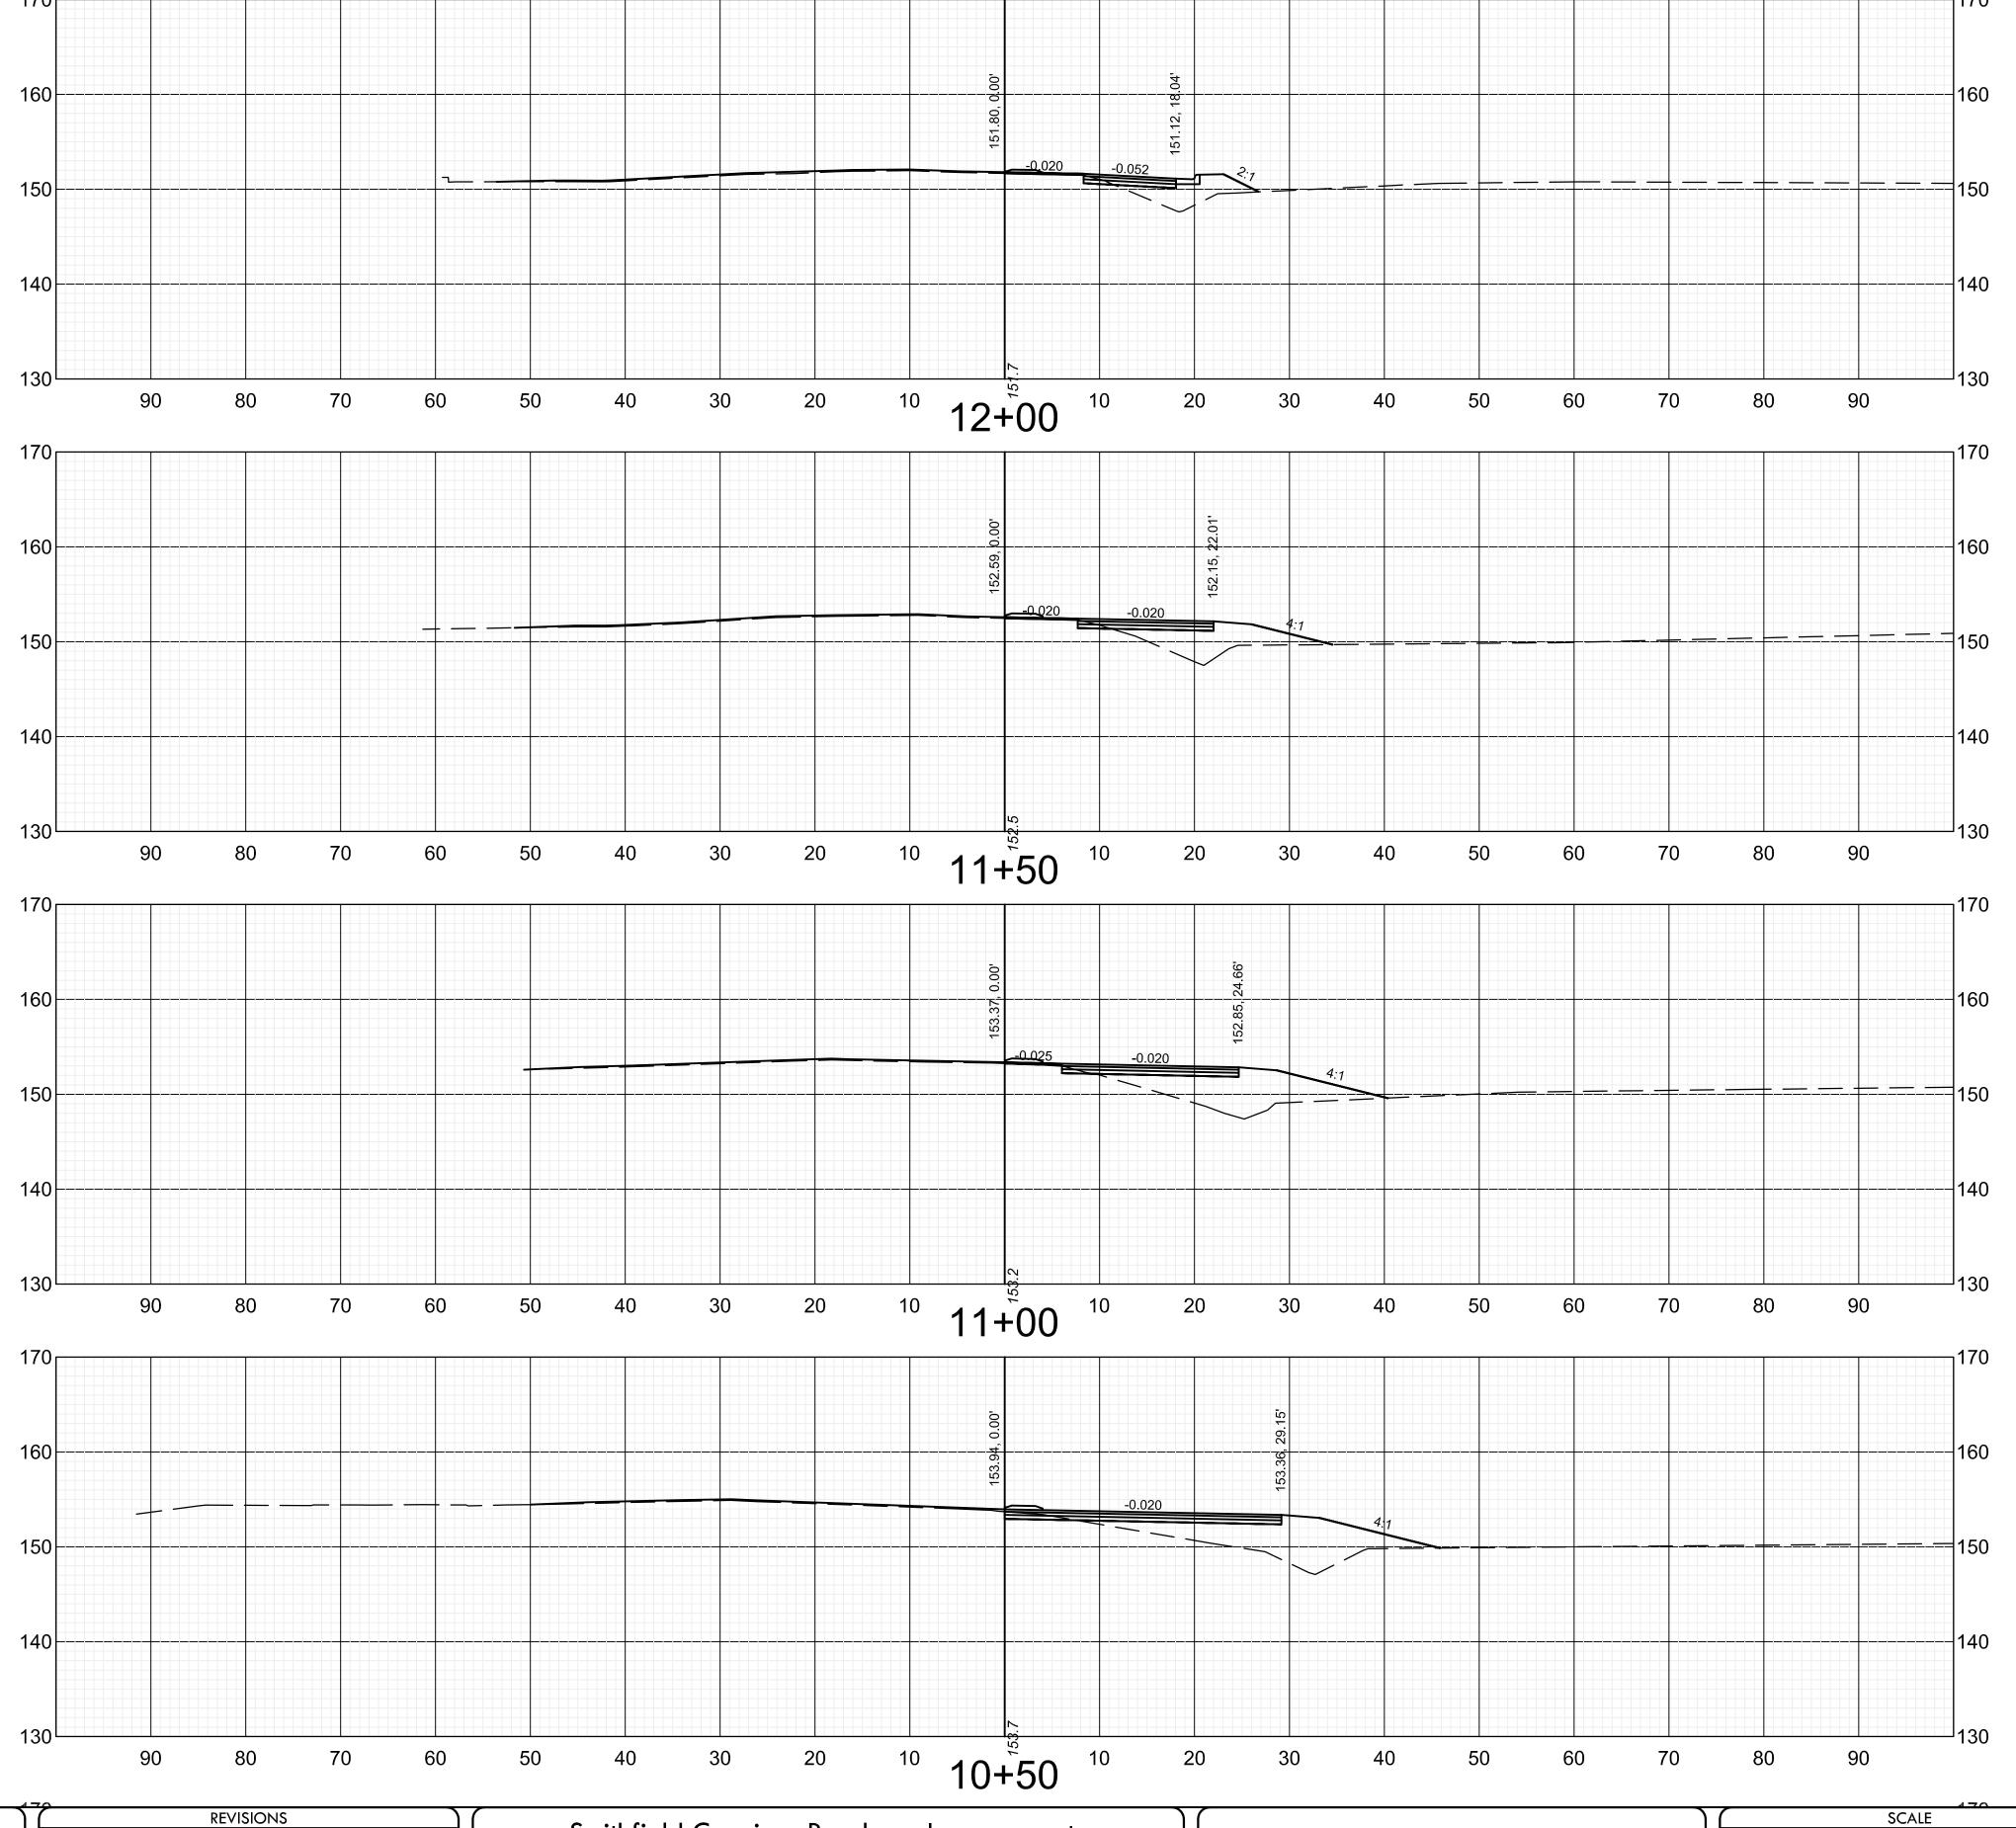

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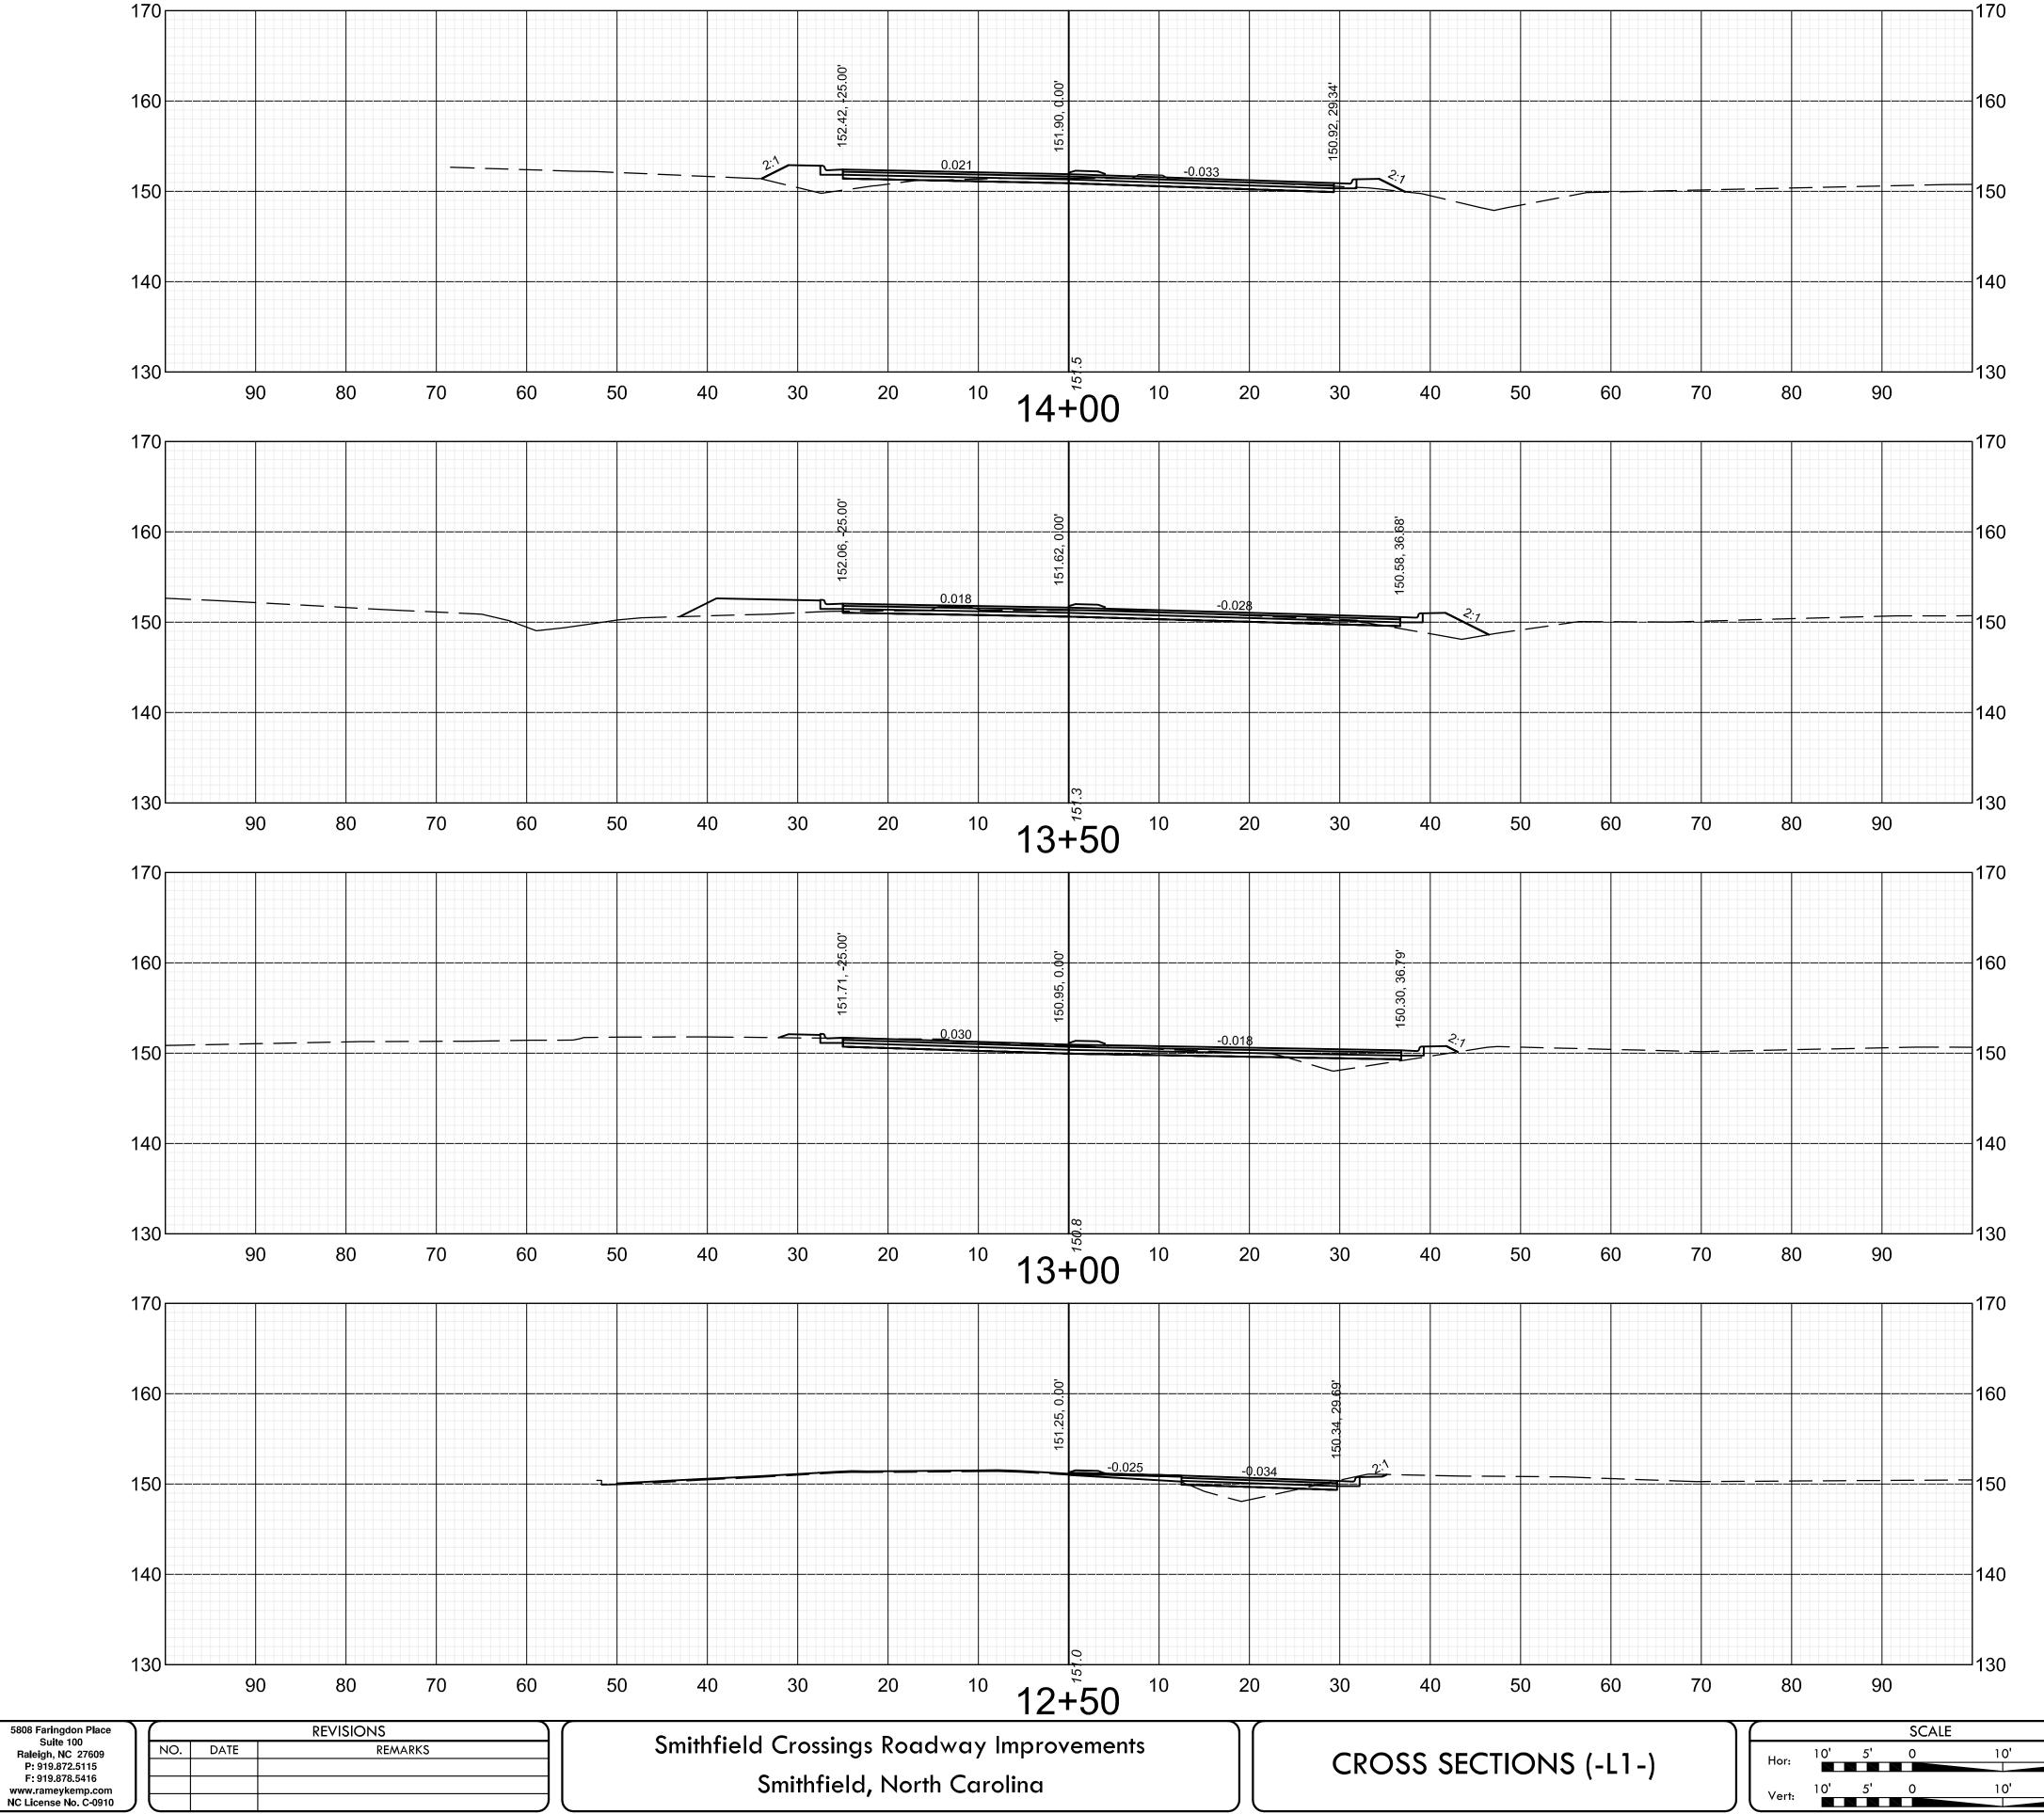
CROSS SECTIONS (-L1-)



DATE: 02/04/11

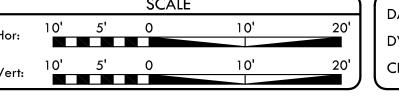PROJECT NO. 07098 DRAWING SmCr_XS02-IPD

SHEET NO.



RAMEY KEMP


ASSOCIATES
TRANSPORTATION ENGINEERS

Smithfield Crossings Roadway Improvements Smithfield, North Carolina

CROSS SECTIONS (-L1-)

DATE: 02/04/11

SHEET NO. PROJECT NO. 07098 DRAWING SmCr_XS02-IPD

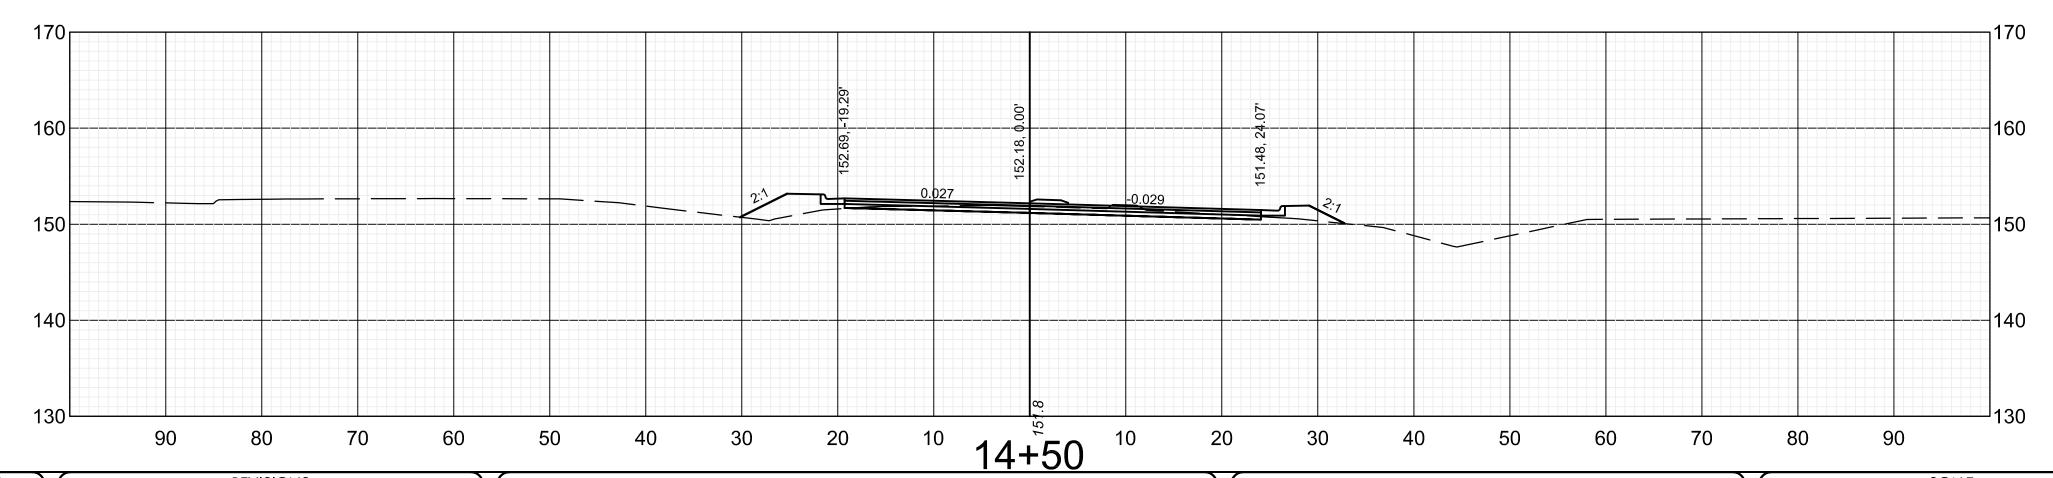

RAMEY KEMP ASSOCIATES TRANSPORTATION ENGINEERS

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REVISIONS NO. DATE

Smithfield Crossings Roadway Improvements Smithfield, North Carolina

CROSS SECTIONS (-L1-)

DATE: 02/04/11

PROJECT NO. 07098 DRAWING SmCr_XS02-IPD

SHEET NO.