ASSET NUMBER: CO.# SITE.# BLDG.# 32 - 07 - 35 REVISIONS DATE

DATE ISSUED: 10-05-15 DRAWN BY: MDM CHECKED BY: MDM

SHEET NO.

2012 APPENDIX B BUILDING CODE SUMMARY

DOILDING GODE SOMMANT	TYPE: V-
Name of Project:	
•	Building height
	Building Height
Proposed Use: UTILITY	
Owner or Authorized Agent: HIGHWAY DIVISION 5 Phone # 919-477-0953	
Owned By: STATE OF NORTH CAROLINA City/County Private State	
Code Enforcement Jurisdiction:	

LEAD DESIGN PROF	FESSIONAL:				
DESIGNER	FIRM	NAME	LICENSE #	TELEPHONE #	E-MAIL
Architectural <u>FACIL</u>	ITIES DESIGN, NCDOT				
SITE "Civil"					
Electrical					
Plumbing					
Mechanical				_	
Sprinkler-Standpipe					
Structural	NCDOT	MIKE MOUNTCASTLE	17326	(919) 707–4547	mdmountcastle@ncdot.

2012 EDITION OF NC CODE FOR:	■ New Construction		☐ Upfit
EXISTING: Reconstruction	☐ Alteration	⊠ Repair	
CONSTRUCTED 1989	ORIGINAL USE	RENOVATED	CURRENT USE

CONSTRUCTED	<u> 19</u>	89	ORIGINAL U	SE	RENOVATE	D	CURRENT USE
BUILDING	DATA						
Construction	Туре:	□ I-A	□ II-A	□ III–A	□ IV	□ V-A	
		□ I-B	□ II–B	□ III–B		⊠ ∨–в	
	Mixed	construction:	⊠ No	☐ Yes	Types		
Sprinklers:	☑ No	☐ Partial	☐Yes	□NFPA 13	□ NFPA	13R	□NFPA 13D
Standpipes:	⊠ No	☐Yes Clo	188 🗌 I 🔲		☐ Wet	☐ Dry	
Fire District:	⊠ No	□Yes		Flood Hazard A	rea: 🛛 No	□Yes	
Building Heigl	nt: Feet	<u>38'-0"</u>	Numbe	r of Stories <u> </u>			
Mezzanine:	⊠ No	☐Yes					
Gross Building	g Area:						
FLOOR		EXISTING	(SQ FT)	NEW	(SQ FT)		SUB-TOTAL
1st Floor		5278	3		0		5278

100 11001	0270					02.	•	
TOTAL	5278	0			5278			
ALLOWABLE AREA								
	☐ Assembly☐ Educational	□ A−1	A-2 Factory F-1	Moderate	☐ A-3 ☐ F-2 Low	_	□ A-5	
Hazardous	☐ H−1 Detonate	☐ H-2	Deflagrate 🔲 H	1-3 Combu	st □ H–4	Health	☐ H—5 HPM	
Institutional	□ I–1	□ I–2	□ I–3		□ I-4			
	I-3 Condition	□ 1	По	□ 3				

lixed Occupa	ncy: 🛛 No		Yes	Separation: ——	— Hr.	Exception	ı:
STORY NO.	DESCRIPTION AND USE	(A) BLDG AREA PER STORY (ACTUAL)	(B) TABLE 503 AREA	(C) AREA FOR OPEN SPACE INCREASE	(D) AREA FOR SPRINKLER INCREASE	(E) Allowable Area or Unlimited	(F) MAXIM BUILD ARE
				1107 11050			

☐ S-1 Moderate ☐ S-2 Low ☐ High-piled

SUMMARY OF WORK:

The Contractor shall provide the work required for a complete, first-class roof replacement and roof framing repair in accordance with plans and specifications. The work shall proceed in, but not be limited to, the following sequence:

I. Retrofit the dome entrance with the new gable roof.

- 2. Remove and dispose of the existing asphalt shingles and roofing material. (Note: Removal, repair, and replacement work may be done in stages.)
- 3. Call for an inspection by the Owner's on-site representative to determine how much of the existing roof sheathing and other components need replacement. Complete roof substrate repair work as required to properly receive new roofing. Verify and document with the Owner's on-site representative in writing and with digital photography all unit price work.
- 4. Install new asphalt shingle roofing system with all roof vents, flashing, edge trim, and
- other necessary components. 5. Call for final inspection by the project administrator and Owner's representative.

The Contractor is responsible for weatherproofing the building from precipitation during the life of the contract. The Contractor shall use tarps, plastic, or other suitable materials to weatherproof the building. The Contractor shall be responsible for repairing any damages incurred to the building caused by water intrusion as a result of the work or failure to protect the structure during construction.

All exposed existing interior roof and side wall framing lumber that is damaged shall be removed and replaced in kind. The extent and exact manner of repair or replacement shall be agreed upon in advance and approved by the Engineer.

Contractor is responsible for removal and off-site disposal of all roofing materials.

After removal of the old roofing material, the Contractor shall call for an inspection by the Owner representative to determine how much of the existing roof structure, if any, must be removed and replaced.

Rotted sheathing shall be removed back to the nearest rafter or framing member. Replacement sheathing shall match thickness of existing sheathing.

The roof geometry is unusual. The dome is comprised of sheathing panels that are wider at the base, tapering to the peak. The sheathing panels will likely be trapezoidal in shape, depending on the rafters to which they are attached. There are parallel rafters and rafters that taper toward the peak, so that the number of rafters decreases toward the peak. The roof area is estimated as 9000 SF. The exact area and dimensions of the roof shall be verified by the Contractor to the extent that they affect his work.

All existing metal roof vents shall be replaced with similar aluminum roof vents of equal or greater cápacity approved by the Designer. Vents are estimated at approximately 51 sq. in. of net free area each (field verify). Submit catalog cut sheets with specifications of proposed new vents to Designer for approval.

The Contractor will remove and replace all flashing around all vertical and horizontal intersections of exterior finish material.

ALLOWABLE HEIGHT

PE:	V-B	ALLOWABLE (TABLE 503)	INCREASE FOR SPRINKLERS	SHOWN ON PLANS	CODE REFERENCE
ilding	height in feet	Feet40	Feet=H+20'= <u>N/A</u>	Feet <u>38'-1"</u>	503
ilding	Height in Stories	Stories 1	Stories+1= <u>N/A</u>	Stories1	503
					-


FIRE PROTECTION REQUIREMENTS

	FIRE RATING			DECION # FOR	DESIGN # FOR	DESIGN #	
BUILDING ELEMENT	SEPARATION DISTANCE (FEET)	REQ'D	PROVIDED W/ REDUCT	SHEET #	DESIGN # FOR RATED ASSEMBLY	RATED PENETRATION	FOR RATED JOINTS
Structural frame, including columns, girders, & trusses	>10	0	0				
Exterior walls		0	0				
Interior Walls and partitions	-	0	0				
Roof construction	>10	0	0				
* Indicate section number permitting reduction							

LIFE SAFETY SYSTEM REQUIREMENTS

Emergency Lighting:	⊠ No	□Yes
Exit Signs:	☑ No	∐Yes
Fire Alarm:	☑ No	∐Yes
Smoke Detection Systems:	☑ No	∐Yes
Panic Hardware:	☑ No	∐Yes

E	EXIT	REQUIREMENTS	N/A	
		KEQUIKEMEN13	N/A	

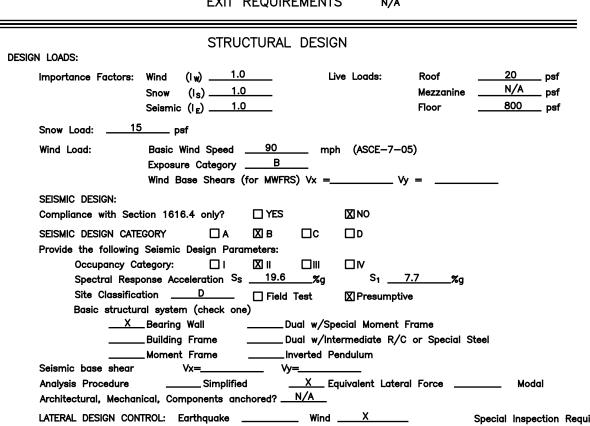


PLUMBING, ENERGY, & MECHANICAL SUMMARIES - NOT APPLICABLE

☑ Field Test ☐ Presumptive ____N/A

DRAWING INDEX

- TITLE SHEET & CODE SUMMARY
- ELEVATIONS & DETAILS S2 PLAN & DETAILS
- S3 DETAILS & GENERAL NOTES

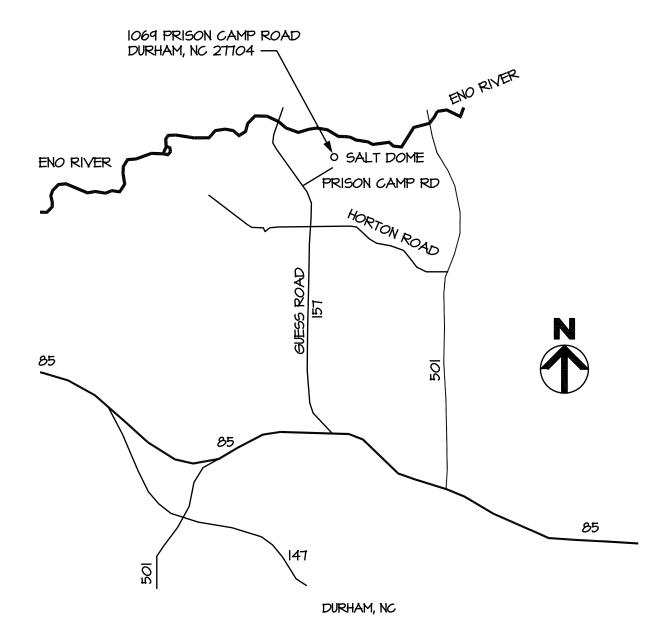

ROOF REPAIR & REPLACEMENT

FOR DURHAM COUNTY SALT DOME

VICINITY MAP NOT TO SCALE


- OWNER TO REMOVE ELECTRICAL SERVICE PRIOR TO CONSTRUCTION



FRONT ENTRY




REAR ELEVATION

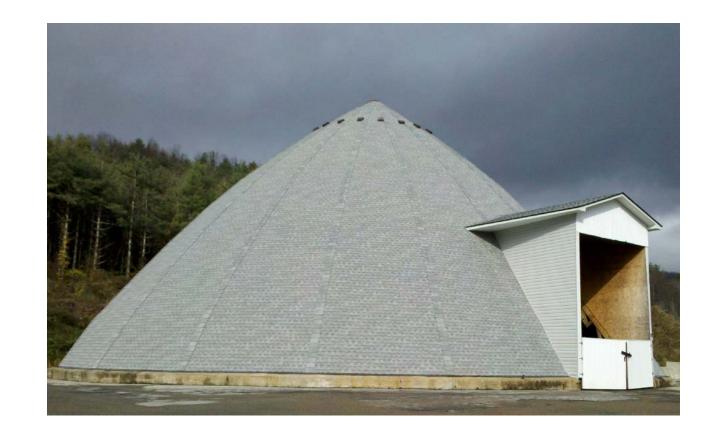


NOTE: PHOTO OF SIMILAR DOME FOR REFERENCE USE ONLY.





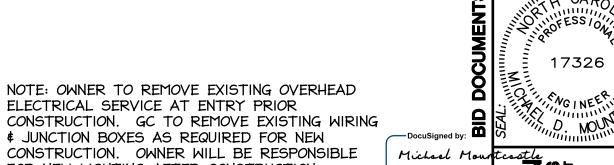


DESIGNATION DESIGNATION NO PORTION NO PORTIO FACILITIES
ARCHITECTS & E

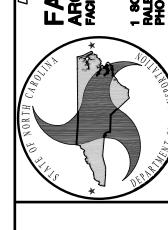


STATE CONSTRUCTION ID.# 15-11515-01A ASSET NUMBER: CO.# SITE.# BLDG.#


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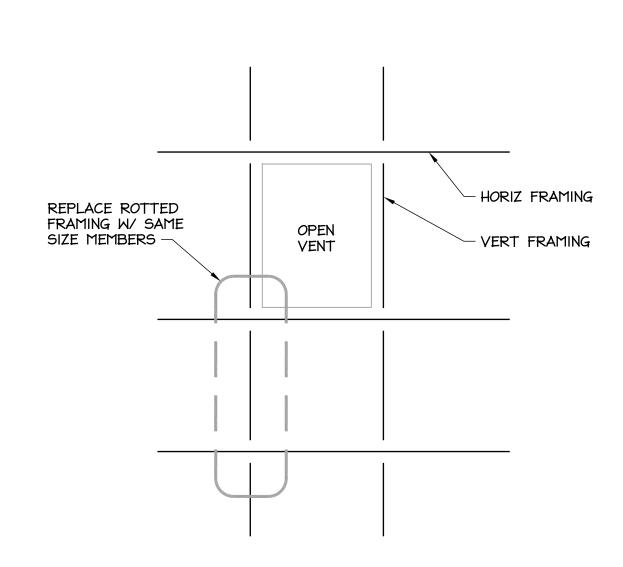


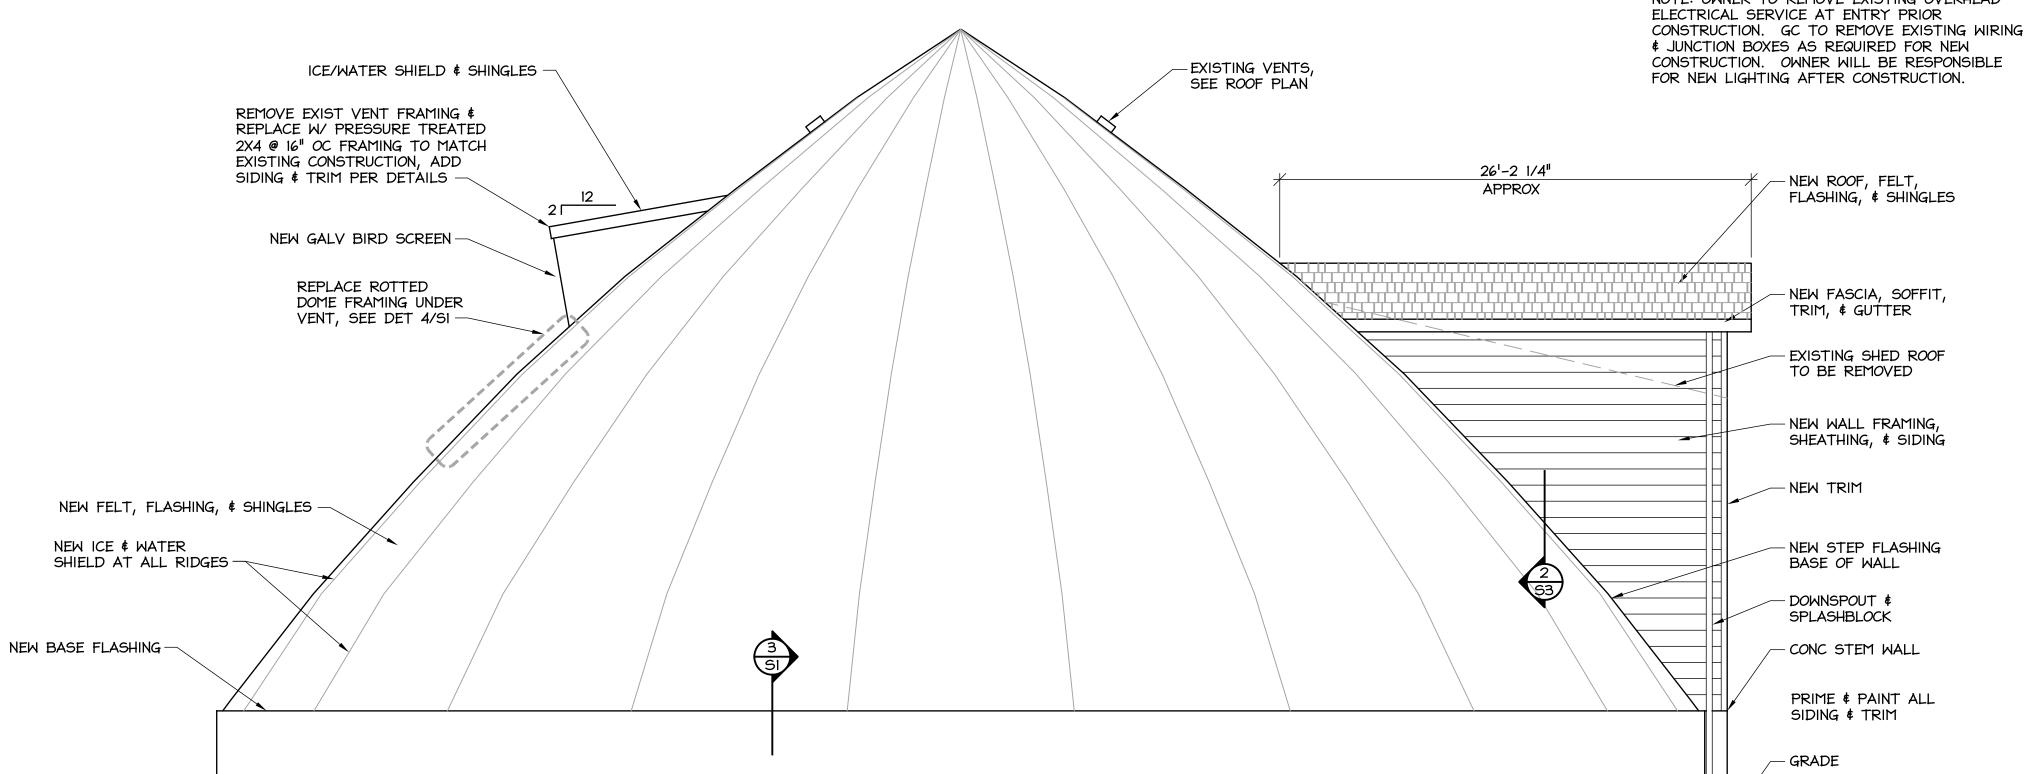


PRIME & PAINT ALL SIDING & TRIM

INSTALL ALUMINUM DRIP EDGE AT ALL EAVES

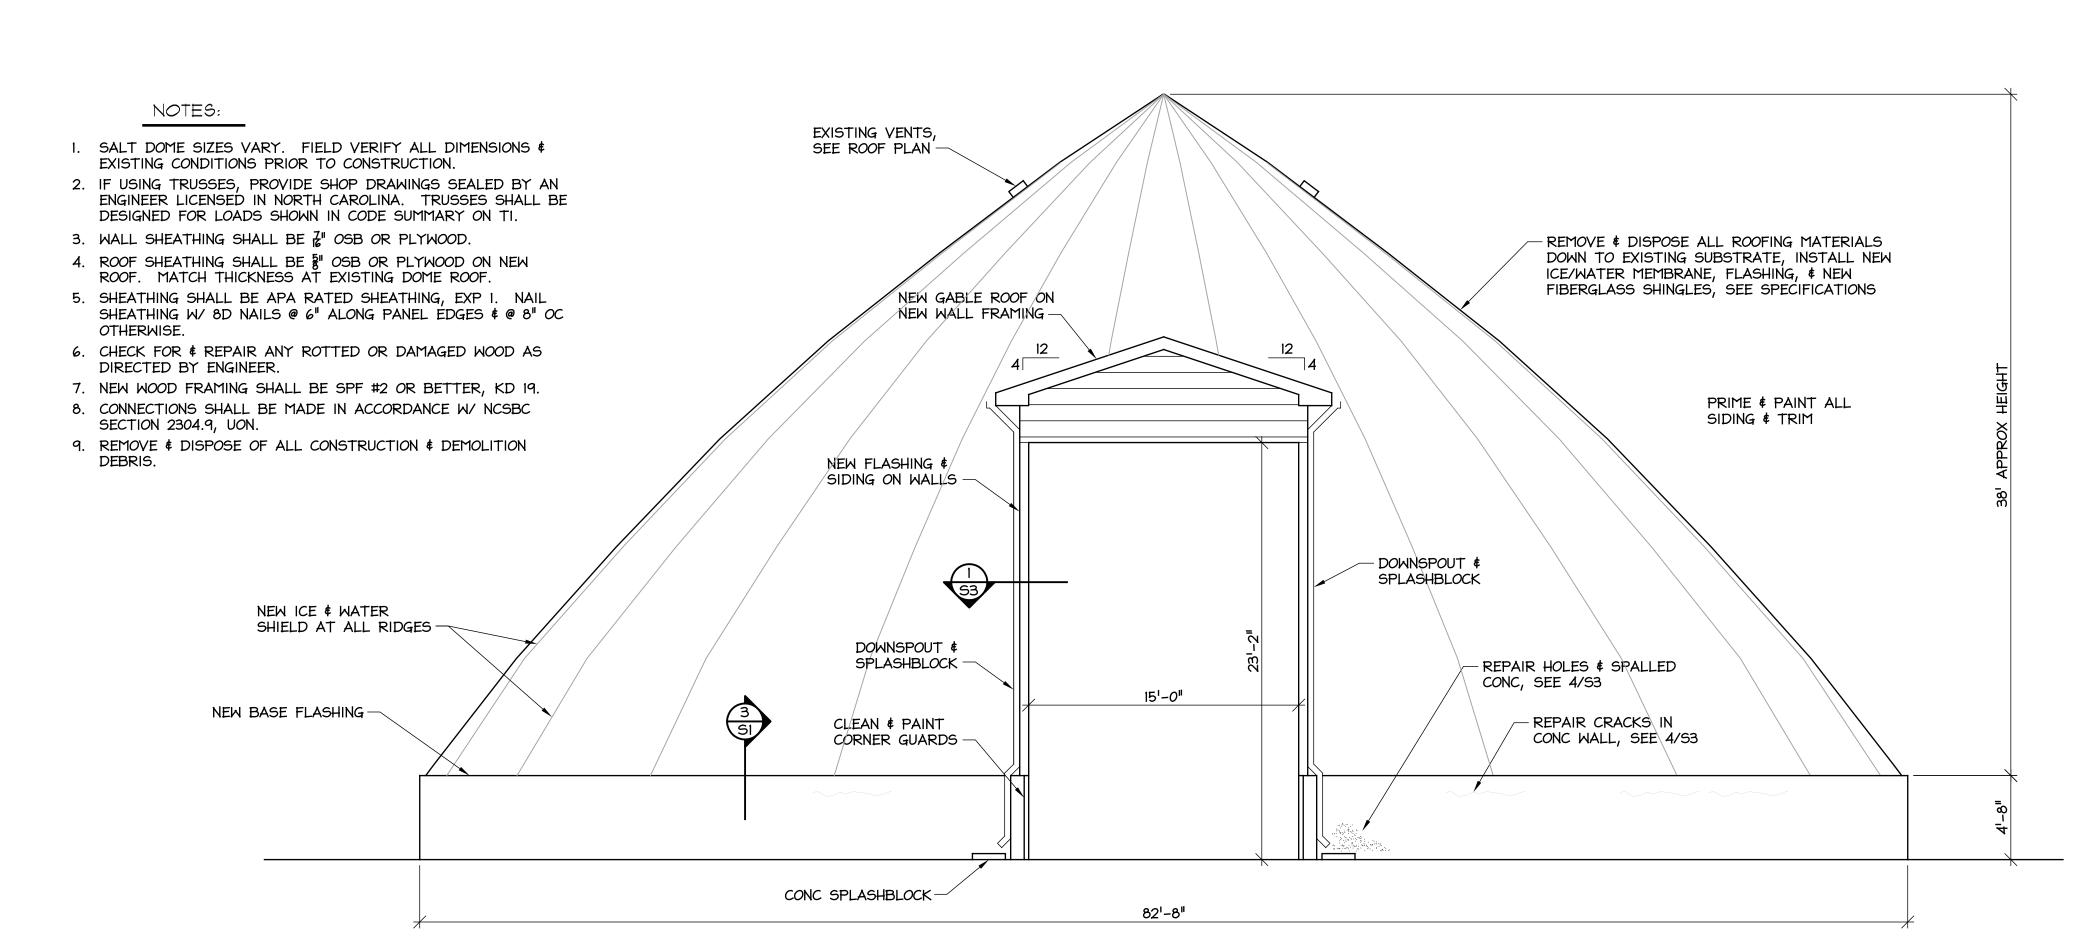VENT FRAMING SCALE: 3/4" = 1'-0"

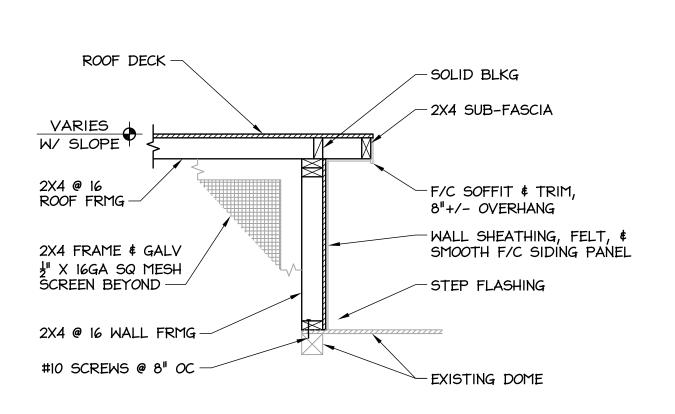


4 INTERIOR VIEW OF VENT SI NO SCALE

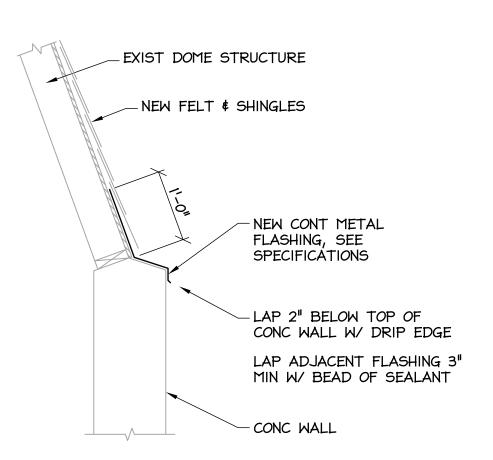

3 BASE FLASHING SCALE: 3/4" = 1'-0"

FRONT ELEVATION SCALE: 3/16" = 1'-0"

DESIGN ENGINEERS

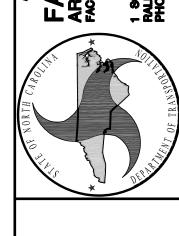

REROOF MCDOT IN CARO 00 DURHAM

STATE CONSTRUCTION ID.# 15-11515-01A

ASSET NUMBER: CO.# SITE.# BLDG.#

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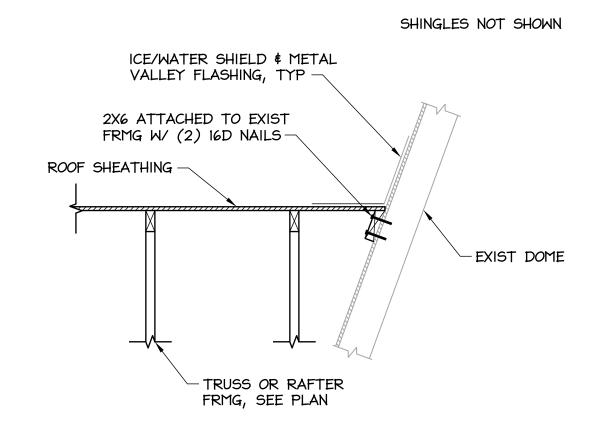
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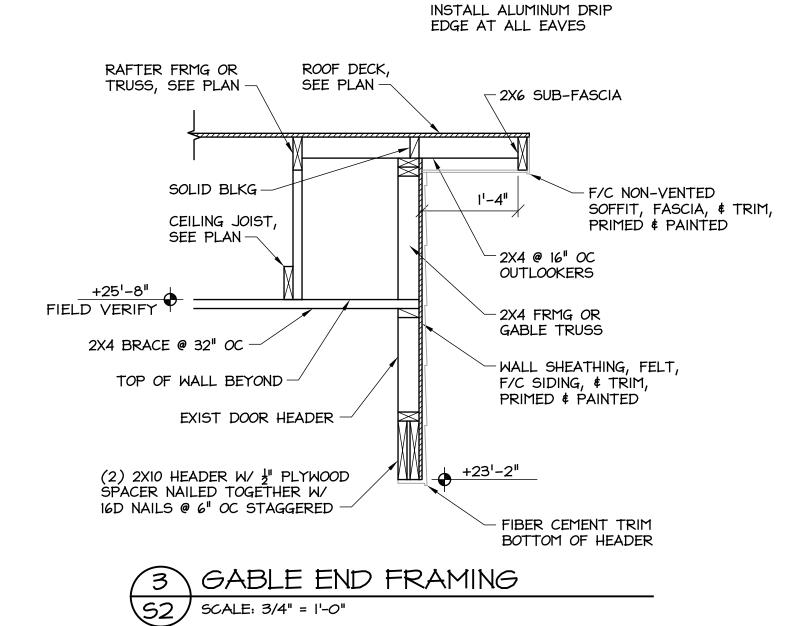
ROOF PLAN


SCALE: 3/16" = 1'-0"

S2




ROOF BEARING AT DOME 52 | SCALE: 3/4" = 1'-0"



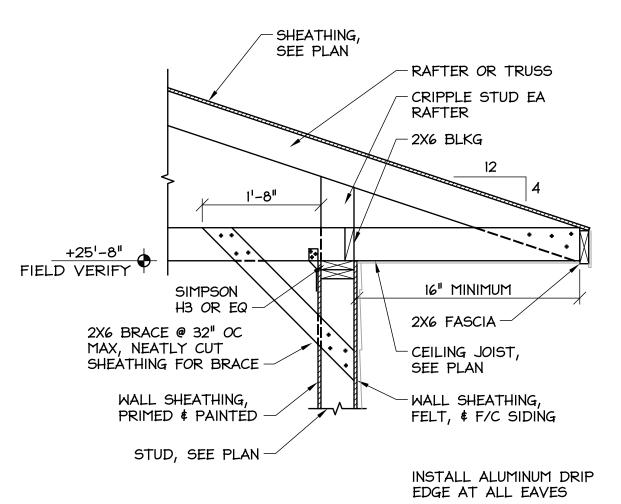



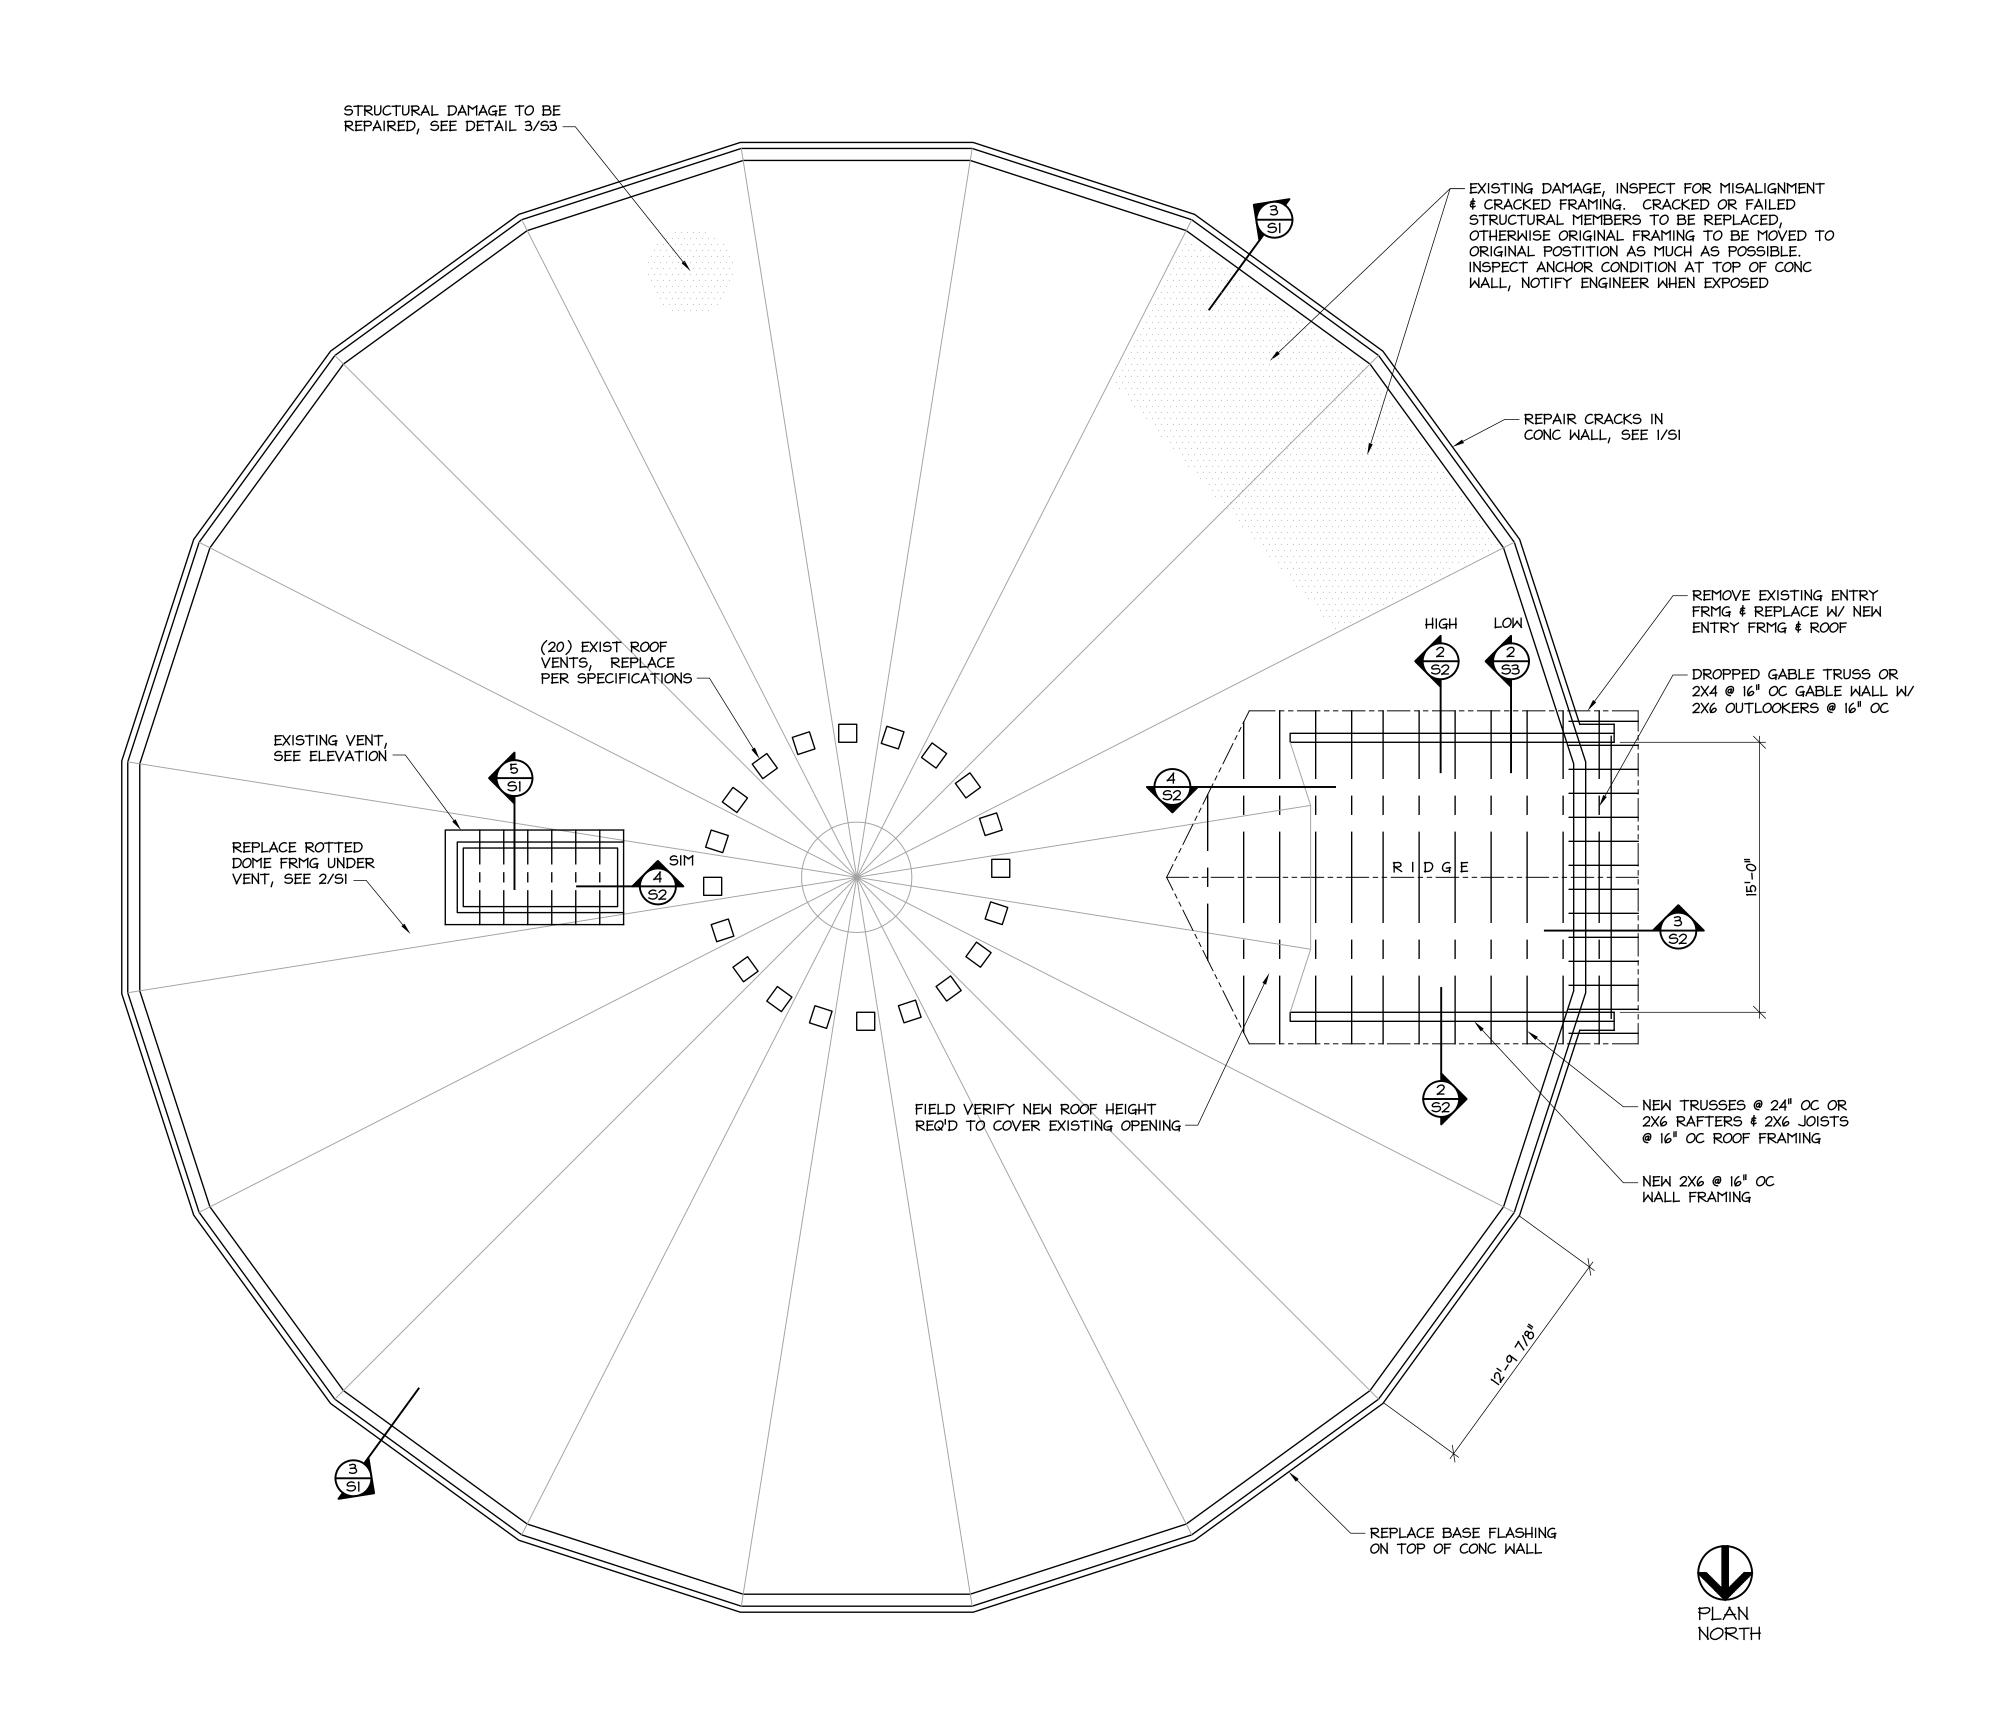



- A. GENERAL
- 1. See specifications for further information. in case of conflict between specifications & drawings, contact engineer for resolution.
- Contractor is responsible for coordination & distribution of all changes in contract documents to all subcontractors.
- 3. Contractor shall verify all field conditions, elevations, & dimensions prior to construction. Do not scale from plans.
- 4. Means & methods of construction, including temporary bracing, shoring, & jobsite safety, are the responsibility of the contractor.
- 5. Structural frame shall be braced until erection is complete & permanent connections & bracing are installed.
- B. WOOD

EXIST REINF-

4 CONCRETE
53 SCALE: 3/4" = 1'-0"


- 1. Structural lumber shall be SPF #2 or better, UON. Wood for fabricated trusses shall be SYP #2 or better, except that webs may be SYP #3.
- 2. Wood in contact with concrete or masonry shall be treated.
- 3. Straps, ties, hangers, & other connection hardware shall be galvanized.
- 4. Connections not otherwise detailed shall be in accordance with Tables 2304.9.1.1 thru 2304.9.1.6 of the NC State Building Code.
- 5. Trusses shall be designed for the full dead & live loads specified in the contract. Submit truss shop drawings bearing the seal of a registered professional engineer licensed in the state of NC. Show truss layout & truss designs including required bracing. Bracing design is the truss designer's responsibility.
- 6. Contractor shall install both temporary and permanent bracing. Note that permanent bracing is often shown on individual truss calculation pages instead of the truss layout sheet, especially where there is no hard ceiling applied to truss.
- 7. Additional bracing may be required by engineer of record as indicated on plans for support of gable walls or other items.
- 8. Install blocking in walls & ceiling where required for partitions, fixtures, & other misc items. Coordinate with all trades.

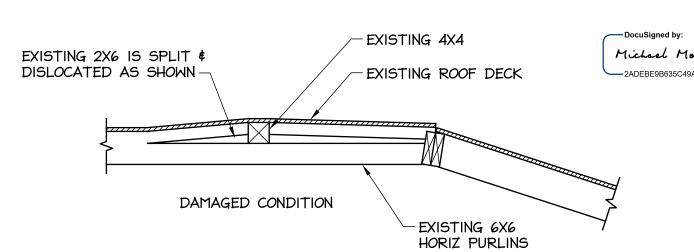

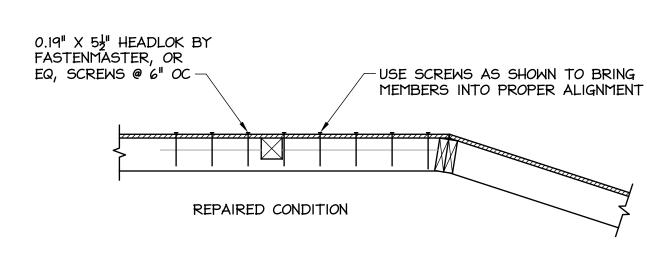





REMOVE EXISTING WALL FRAMING DOWN TO TOP OF TRUSS, BUILD NEW WALL ABOVE AS SHOWN, DO NOT CUT TRUSS

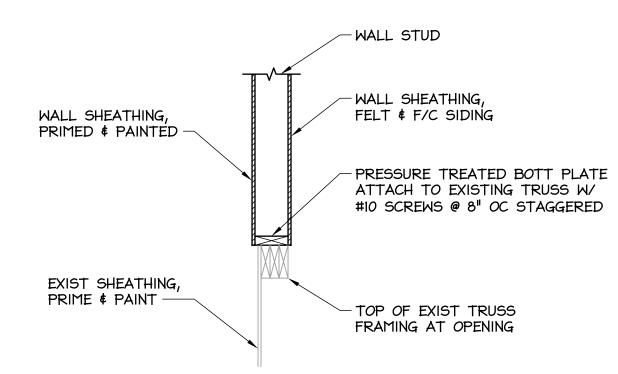



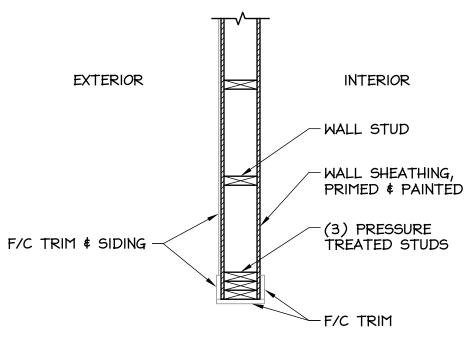

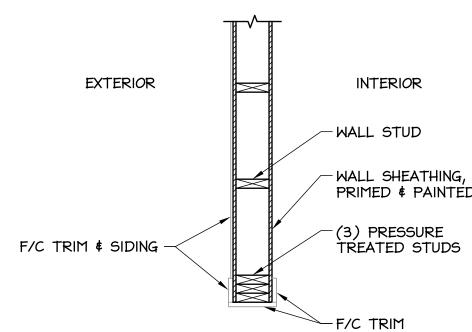



- CONCRETE WALL

REMOVE LOOSE CONCRETE
AT CRACKED AREAS, CLEAN

INSTALL PATCH PER MFR'S WRITTEN INSTRUCTIONS

NOTE, LIGHTLY TAP WALL

CRACKED OR LOOSE CONC

SEE SPECIFICATIONS FOR PATCHING MATERIALS

INDICATES SOLID CONC, HOLLOW TONE INDICATES

W/ HAMMER, RINGING TONE

11/19/2015 | 10:39 AM PT

DESIGN ENGINEERS T DIVISION, NODOT FACILITIES
ARCHITECTS & E



REROOF NO 0 **DURH**

STATE CONSTRUCTION ID.# 15-11515-01A ASSET NUMBER: CO.# SITE.# BLDG.# 32 **-** 07 **-** 35 REVISIONS

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SHEET NO. **S3**